# SITE DEVELOPMENT PLANS

FOR

# MAIFLY DEVELOPMENT

# 5 & 9 FRESE ROAD

SITUATED IN:

# TOWN OF DRYDEN - TOMPKINS COUNTY - NEW YORK

### PROJECT CONTACTS:

APPLICANT:
MATT DURBIN
MAIFLY DEVELOPMENT
2400 OXFORD DRIVE
PITTSBURGH, PA 115210
(412) 770-4595

ARCHITECT:
NOAH DEMAREST
STREAM COLLABORATIVE
108 WEST STATE STREET
ITHACA, NY 14850
(607) 216-8802

SANITARY SEWER: RICK YOUNG TOWN OF DRYDEN DEPARTMENT OF PUBLIC WORKS 61 EAST MAIN STREET DRYDEN, NY 13053 (607) 844-5188


ELECTRIC:
NEW YORK STATE ELECTRIC & GAS
18 LINK DRIVE
BINGHAMTON, NY 13904
(607) 343-5283

SURVEYOR: DARREN BROCK, L.S. TG MILLER, PC 605 W STATE STREET SUITE A ITHACA, NY 14850 (607) 272-6477

CIVIL ENGINEER: ADAM M. FISHEL, PE, CPESC MARATHON ENGINEERING 840 HANSHAW ROAD, SUITE 12 ITHACA, NY 14850 (607) 241-2917

WATER: BOLTON POINT WATER SYSTEM STEVE RIDDLE 1402 EAST SHORE DRIVE ITHACA, NY 14850 (607) 277-0660

GAS: NEW YORK STATE ELECTRIC & GAS 18 LINK DRIVE BINGHAMTON, NY 13904 (607) 343-5283

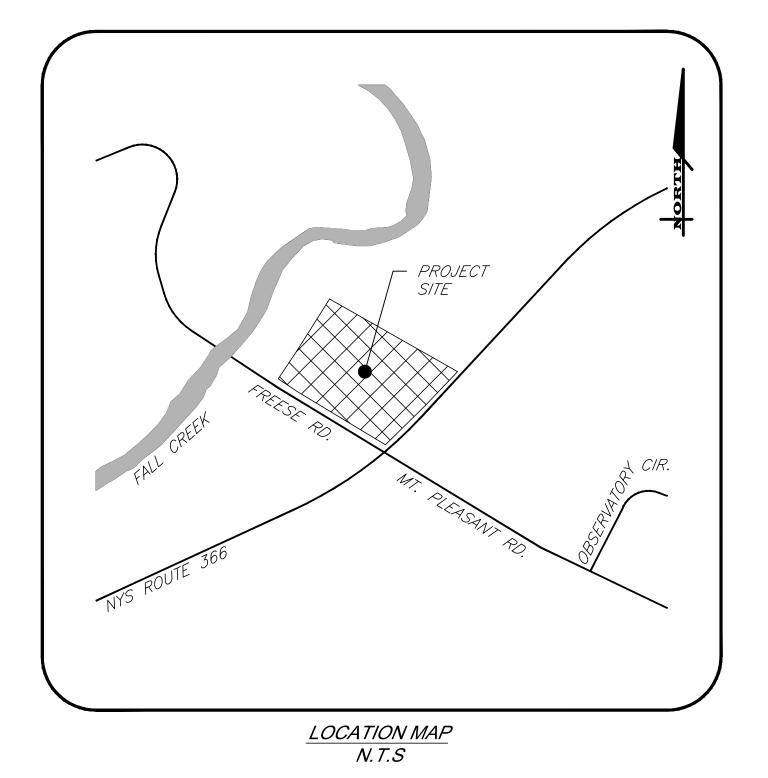




ROCHESTER LOCATION

3 9 CASCADE DRIVE
ROCHESTER, NY 14614
5 8 5 - 4 5 8 - 7 7 7 0

ITHACA LOCATION

840 HANSHAW RD, STE 12
ITHACA, NY 14850
6 0 7 - 2 4 1 - 2 9 1 7

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ON PIPE OR IRON PIN ENGTH OR LENGTH OF CURVE

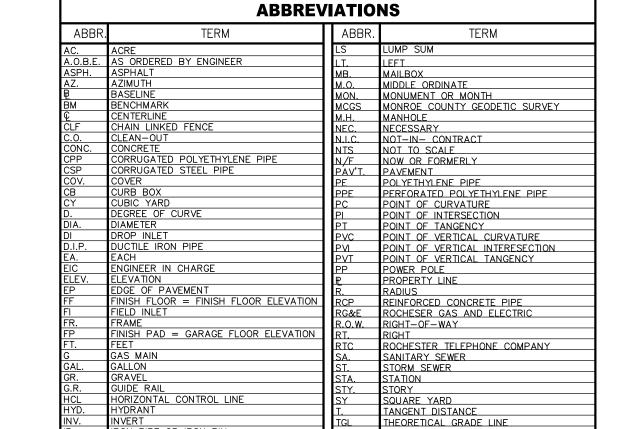TREE LINE

LIGHT POLE

POWER POLE

+00 + CENTERLINE AND STATIONING

8" PVC SDR-35\_ SANITARY SEWER WITH MANHOLE

O12"PE ST O 1.0% STORM SEWER, MANHOLE & FIELD/DROP INLET

DRAINAGE FLOW ARROW

SPOT ELEVATION

TREE PROTECTION

PARKING SPACE COUNT

VERTICAL CURVE

<u>(ITRIFIED TILE PIPE</u> ENTRAL ANGLE

GAS MAIN & VALVE

ELECTRIC CONDUIT & STRUCTURE

TELEPHONE CONDUIT & STRUCTURE

, WATER MAIN WITH HYDRANT & GATE VALVE


### LIST OF DRAWINGS DWG TITLE COVER SHEET BOUNDARY & TOPOGRAPHIC MAP C1.0 | DEMOLITION PLAN C2.0 OVERALL SITE PLAN C2.1 | SITE PLAN C2.2 RECREATION AREA ENLARGEMENTS PLAN GRADING, DRAINAGE AND EROSION CONTROL PLAN (1 OF 2) GRADING, DRAINAGE AND EROSION CONTROL PLAN (2 OF 2) C4.0 UTILITY PLAN (1 OF 2) C4.1 UTILITY PLAN (2 OF 2) C5.0 LIGHTING AND LANDSCAPING PLAN C6.0 | DETAIL SHEET (1 OF 5) C6.1 DETAIL SHEET (2 OF 5) C6.2 DETAIL SHEET (3 OF 5) C6.3 DETAIL SHEET (4 OF 5) C6.4 DETAIL SHEET (5 OF 5) C7.0 TRUCK TURN PLAN C8.0 HIGHWAY IMPROVEMENT PLAN (1 OF 2) C8.1 | HIGHWAY IMPROVEMENT PLAN (2 OF 2) C8.2 | HIGHWAY IMPROVEMENT PLAN (2 OF 3)

OWNER / APPLICANT:


MAIFLY DEVELOPMENT 2400 OXFORD DRIVE PITTSBURGH, PA 15210


COPYRIGHT © 2020 MARATHON ENGINEERING OF ROCHESTER, P.C. DESIGNER CONTACT STATEMENT:

MARATHON ENGINEERING IS RESPONSIBLE FOR THE DESIGN OF THIS PROJECT. ADAM M. FISHEL, PE, CPESC IS THE DESIGNER AND IS FAMILIAR WITH THE NYSDOT STANDARDS AND REQUIREMENTS AND SHALL BE CONTACTED AT (607) 241–2917 TO RESOLVE ISSUES OR PROBLEMS DURING CONSTRUCTION. ALL REVISIONS, INCLUDING REVISIONS NECESSARY DUE TO FIELD CONDITIONS, SHALL BE APPROVED BY THE NYSDOT.

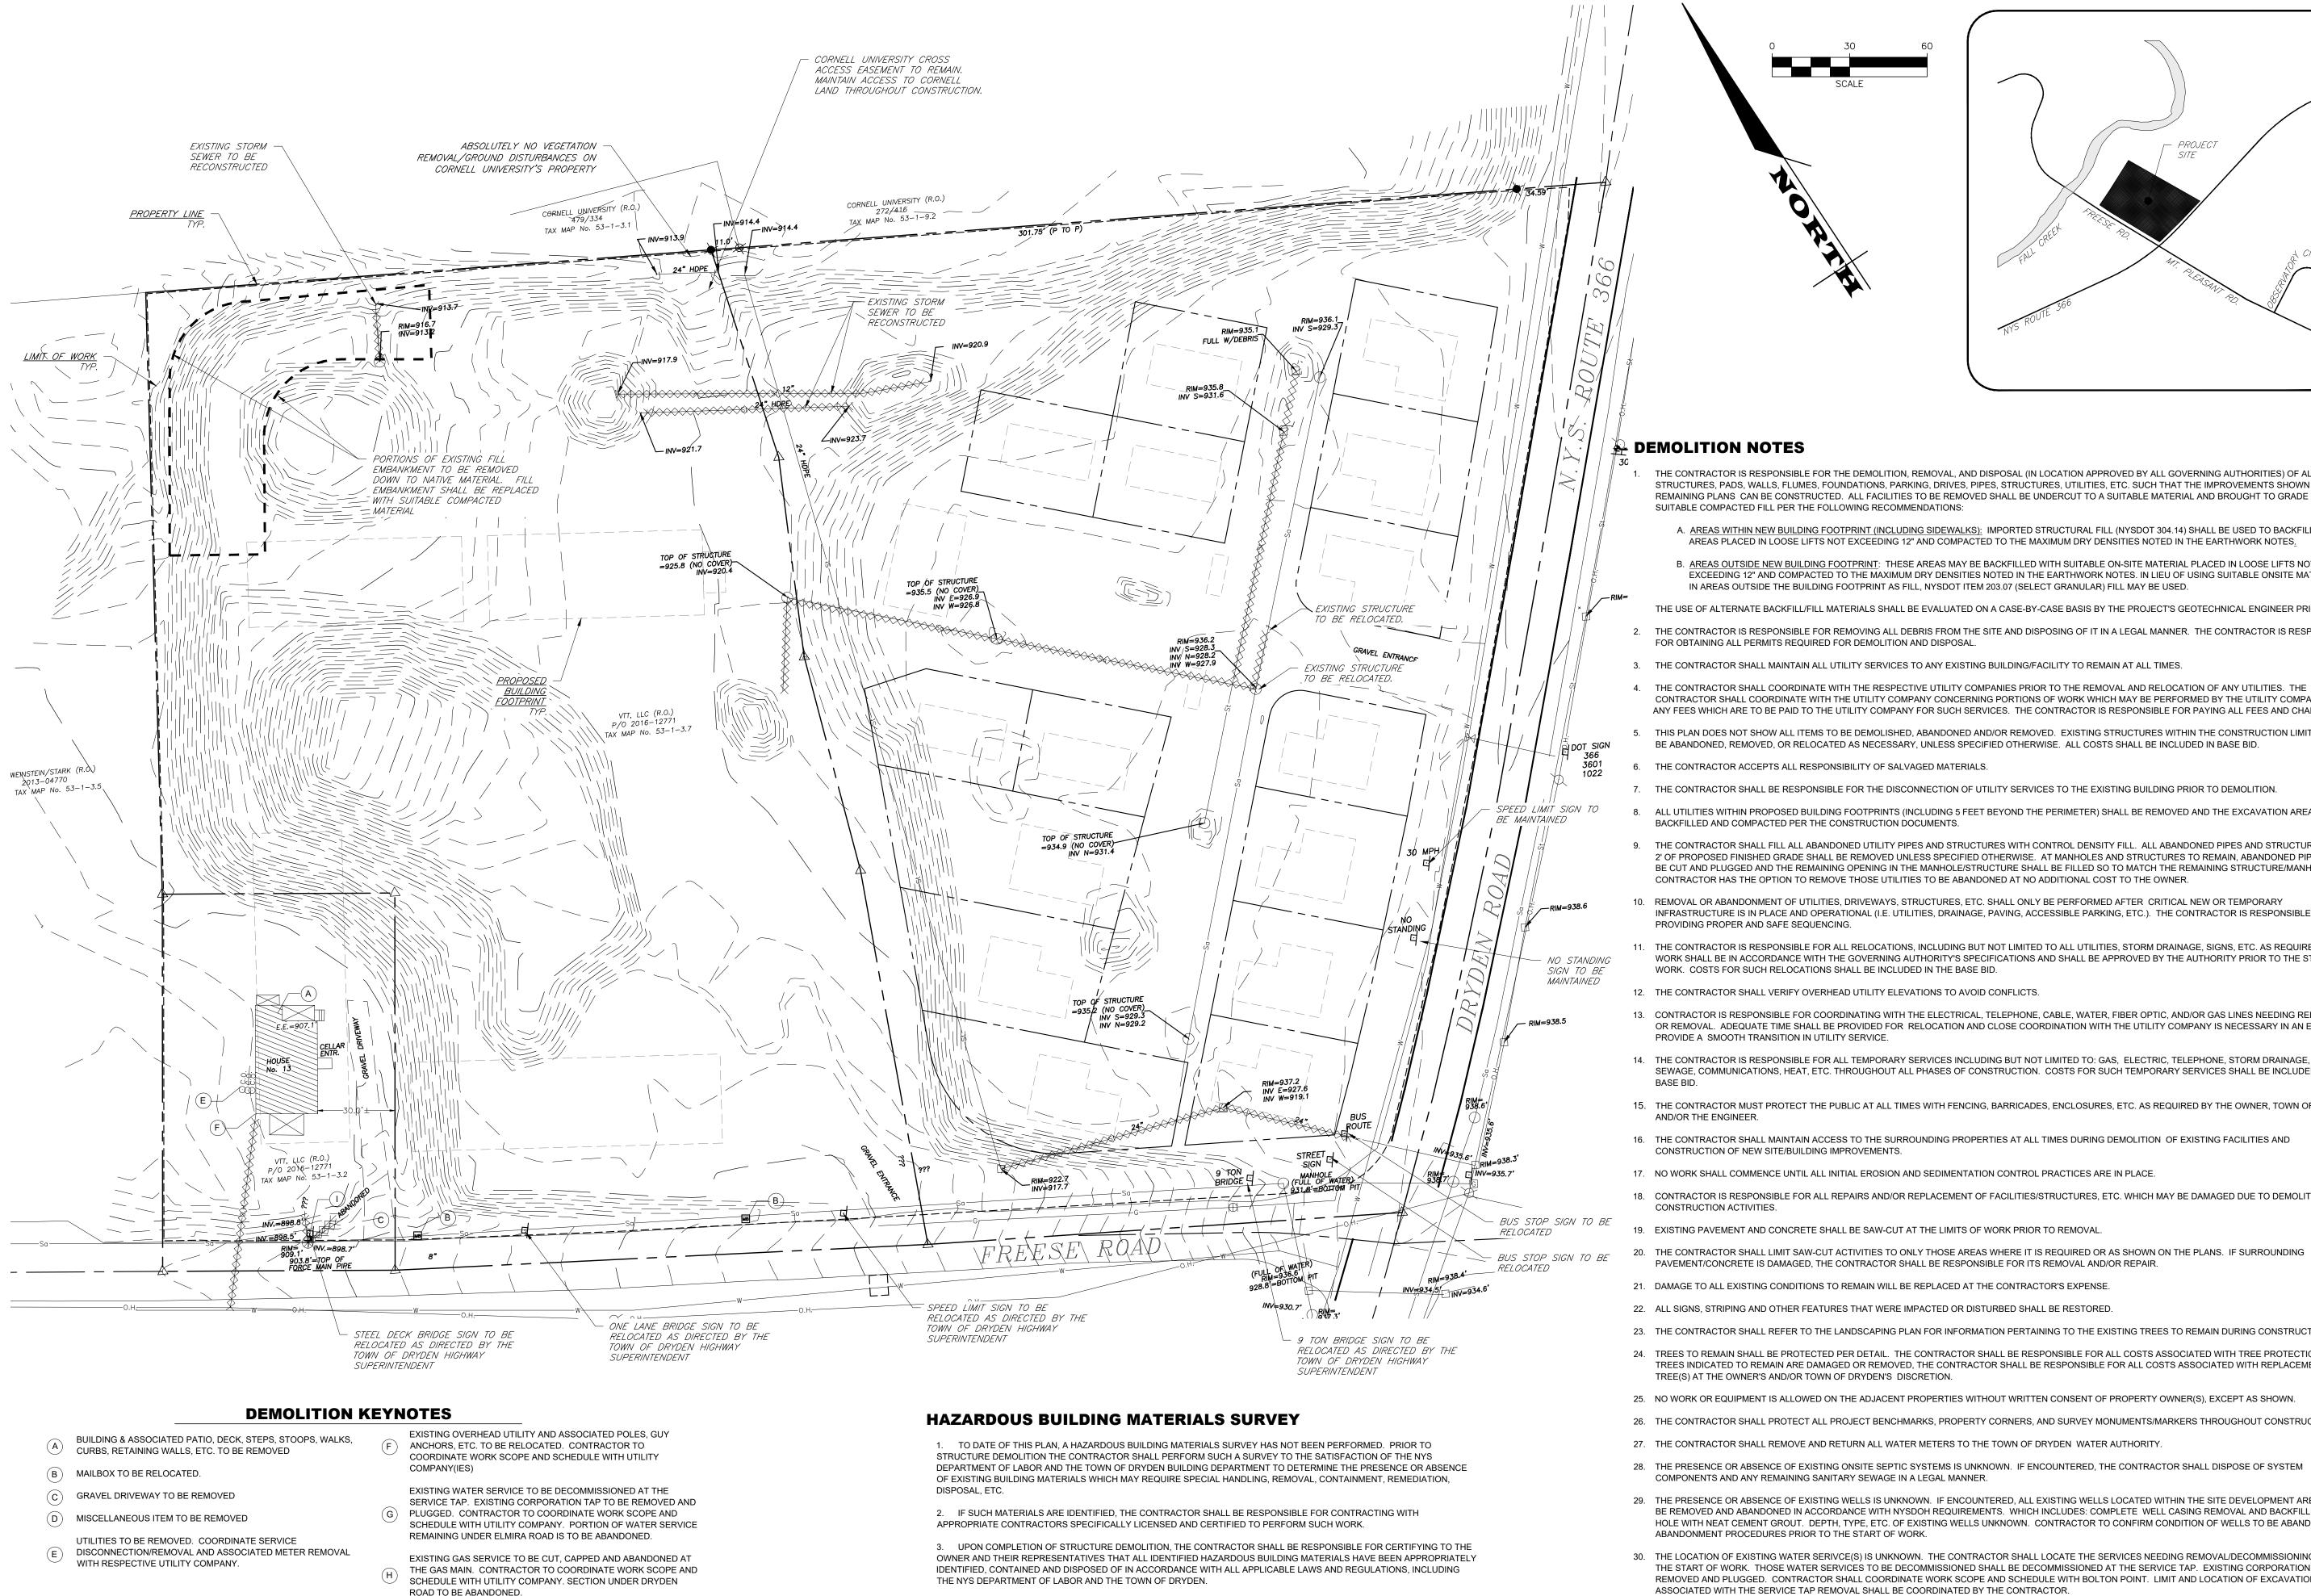

CONTRACTOR TO LOCATE AND REMOVE EXISTING SANITARY LATERAL ENTERING THE EXISTING MANHOLE AND REPAIR/PLUG STRUCTURE ENTRANCE PER TOWN OF DRYDEN REQUIREMENTS. EXISTING LATERAL INVERT UNKNOWN. THE EXISTING BENCH SHALL BE REMOVED IN ITS ENTIRETY AND NEW BENCH INSTALLED.

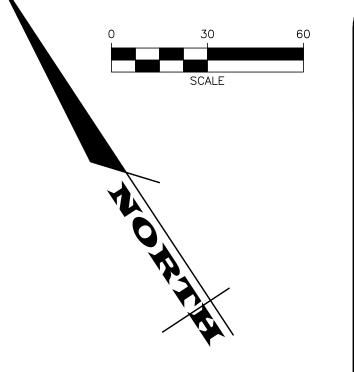

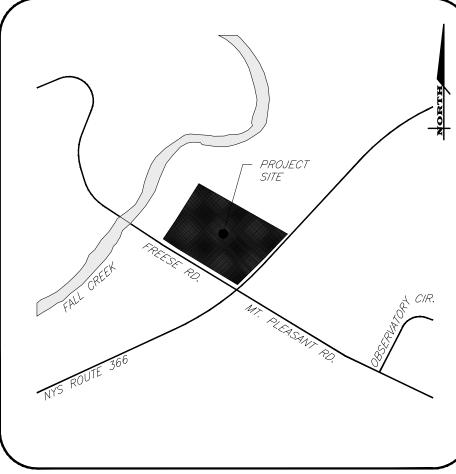

### A DEMOLITION NOTES

- THE CONTRACTOR IS RESPONSIBLE FOR THE DEMOLITION, REMOVAL, AND DISPOSAL (IN LOCATION APPROVED BY ALL GOVERNING AUTHORITIES) OF ALL STRUCTURES, PADS, WALLS, FLUMES, FOUNDATIONS, PARKING, DRIVES, PIPES, STRUCTURES, UTILITIES, ETC. SUCH THAT THE IMPROVEMENTS SHOWN ON THE REMAINING PLANS CAN BE CONSTRUCTED. ALL FACILITIES TO BE REMOVED SHALL BE UNDERCUT TO A SUITABLE MATERIAL AND BROUGHT TO GRADE WITH SUITABLE COMPACTED FILL PER THE FOLLOWING RECOMMENDATIONS:
  - A. AREAS WITHIN NEW BUILDING FOOTPRINT (INCLUDING SIDEWALKS): IMPORTED STRUCTURAL FILL (NYSDOT 304.14) SHALL BE USED TO BACKFILL THESE AREAS PLACED IN LOOSE LIFTS NOT EXCEEDING 12" AND COMPACTED TO THE MAXIMUM DRY DENSITIES NOTED IN THE EARTHWORK NOTES.
  - B. AREAS OUTSIDE NEW BUILDING FOOTPRINT: THESE AREAS MAY BE BACKFILLED WITH SUITABLE ON-SITE MATERIAL PLACED IN LOOSE LIFTS NOT EXCEEDING 12" AND COMPACTED TO THE MAXIMUM DRY DENSITIES NOTED IN THE EARTHWORK NOTES. IN LIEU OF USING SUITABLE ONSITE MATERIAL IN AREAS OUTSIDE THE BUILDING FOOTPRINT AS FILL, NYSDOT ITEM 203.07 (SELECT GRANULAR) FILL MAY BE USED.
- THE USE OF ALTERNATE BACKFILL/FILL MATERIALS SHALL BE EVALUATED ON A CASE-BY-CASE BASIS BY THE PROJECT'S GEOTECHNICAL ENGINEER PRIOR TO USE
- THE CONTRACTOR IS RESPONSIBLE FOR REMOVING ALL DEBRIS FROM THE SITE AND DISPOSING OF IT IN A LEGAL MANNER. THE CONTRACTOR IS RESPONSIBLE FOR OBTAINING ALL PERMITS REQUIRED FOR DEMOLITION AND DISPOSAL.
- 3. THE CONTRACTOR SHALL MAINTAIN ALL UTILITY SERVICES TO ANY EXISTING BUILDING/FACILITY TO REMAIN AT ALL TIMES.
- 4. THE CONTRACTOR SHALL COORDINATE WITH THE RESPECTIVE UTILITY COMPANIES PRIOR TO THE REMOVAL AND RELOCATION OF ANY UTILITIES. THE CONTRACTOR SHALL COORDINATE WITH THE UTILITY COMPANY CONCERNING PORTIONS OF WORK WHICH MAY BE PERFORMED BY THE UTILITY COMPANY AND ANY FEES WHICH ARE TO BE PAID TO THE UTILITY COMPANY FOR SUCH SERVICES. THE CONTRACTOR IS RESPONSIBLE FOR PAYING ALL FEES AND CHARGES.
- 5. THIS PLAN DOES NOT SHOW ALL ITEMS TO BE DEMOLISHED, ABANDONED AND/OR REMOVED. EXISTING STRUCTURES WITHIN THE CONSTRUCTION LIMITS ARE TO BE ABANDONED, REMOVED, OR RELOCATED AS NECESSARY, UNLESS SPECIFIED OTHERWISE. ALL COSTS SHALL BE INCLUDED IN BASE BID.
- 6. THE CONTRACTOR ACCEPTS ALL RESPONSIBILITY OF SALVAGED MATERIALS
- THE CONTRACTOR SHALL BE RESPONSIBLE FOR THE DISCONNECTION OF UTILITY SERVICES TO THE EXISTING BUILDING PRIOR TO DEMOLITION.
- ALL UTILITIES WITHIN PROPOSED BUILDING FOOTPRINTS (INCLUDING 5 FEET BEYOND THE PERIMETER) SHALL BE REMOVED AND THE EXCAVATION AREA SHALL BE BACKFILLED AND COMPACTED PER THE CONSTRUCTION DOCUMENTS.
- THE CONTRACTOR SHALL FILL ALL ABANDONED UTILITY PIPES AND STRUCTURES WITH CONTROL DENSITY FILL. ALL ABANDONED PIPES AND STRUCTURES WITHIN 2' OF PROPOSED FINISHED GRADE SHALL BE REMOVED UNLESS SPECIFIED OTHERWISE. AT MANHOLES AND STRUCTURES TO REMAIN, ABANDONED PIPES SHALL BE CUT AND PLUGGED AND THE REMAINING OPENING IN THE MANHOLE/STRUCTURE SHALL BE FILLED SO TO MATCH THE REMAINING STRUCTURE/MANHOLE. THE CONTRACTOR HAS THE OPTION TO REMOVE THOSE UTILITIES TO BE ABANDONED AT NO ADDITIONAL COST TO THE OWNER.
- INFRASTRUCTURE IS IN PLACE AND OPERATIONAL (I.E. UTILITIES, DRAINAGE, PAVING, ACCESSIBLE PARKING, ETC.). THE CONTRACTOR IS RESPONSIBLE FOR PROVIDING PROPER AND SAFE SEQUENCING.
- 11. THE CONTRACTOR IS RESPONSIBLE FOR ALL RELOCATIONS, INCLUDING BUT NOT LIMITED TO ALL UTILITIES, STORM DRAINAGE, SIGNS, ETC. AS REQUIRED, ALL WORK SHALL BE IN ACCORDANCE WITH THE GOVERNING AUTHORITY'S SPECIFICATIONS AND SHALL BE APPROVED BY THE AUTHORITY PRIOR TO THE START OF WORK. COSTS FOR SUCH RELOCATIONS SHALL BE INCLUDED IN THE BASE BID.
- 12. THE CONTRACTOR SHALL VERIFY OVERHEAD UTILITY ELEVATIONS TO AVOID CONFLICTS.
- 13. CONTRACTOR IS RESPONSIBLE FOR COORDINATING WITH THE ELECTRICAL, TELEPHONE, CABLE, WATER, FIBER OPTIC, AND/OR GAS LINES NEEDING RELOCATION OR REMOVAL. ADEQUATE TIME SHALL BE PROVIDED FOR RELOCATION AND CLOSE COORDINATION WITH THE UTILITY COMPANY IS NECESSARY IN AN EFFORT TO PROVIDE A SMOOTH TRANSITION IN UTILITY SERVICE.
- 14. THE CONTRACTOR IS RESPONSIBLE FOR ALL TEMPORARY SERVICES INCLUDING BUT NOT LIMITED TO: GAS. ELECTRIC. TELEPHONE. STORM DRAINAGE. SANITARY SEWAGE, COMMUNICATIONS, HEAT, ETC. THROUGHOUT ALL PHASES OF CONSTRUCTION. COSTS FOR SUCH TEMPORARY SERVICES SHALL BE INCLUDED IN THE
- 15. THE CONTRACTOR MUST PROTECT THE PUBLIC AT ALL TIMES WITH FENCING, BARRICADES, ENCLOSURES, ETC. AS REQUIRED BY THE OWNER, TOWN OF DRYDEN
- 16. THE CONTRACTOR SHALL MAINTAIN ACCESS TO THE SURROUNDING PROPERTIES AT ALL TIMES DURING DEMOLITION OF EXISTING FACILITIES AND CONSTRUCTION OF NEW SITE/BUILDING IMPROVEMENTS.
- 17. NO WORK SHALL COMMENCE UNTIL ALL INITIAL EROSION AND SEDIMENTATION CONTROL PRACTICES ARE IN PLACE.
- 18. CONTRACTOR IS RESPONSIBLE FOR ALL REPAIRS AND/OR REPLACEMENT OF FACILITIES/STRUCTURES, ETC. WHICH MAY BE DAMAGED DUE TO DEMOLITION OR CONSTRUCTION ACTIVITIES.
- 19. EXISTING PAVEMENT AND CONCRETE SHALL BE SAW-CUT AT THE LIMITS OF WORK PRIOR TO REMOVAL.
- 20. THE CONTRACTOR SHALL LIMIT SAW-CUT ACTIVITIES TO ONLY THOSE AREAS WHERE IT IS REQUIRED OR AS SHOWN ON THE PLANS. IF SURROUNDING PAVEMENT/CONCRETE IS DAMAGED, THE CONTRACTOR SHALL BE RESPONSIBLE FOR ITS REMOVAL AND/OR REPAIR.
- 21. DAMAGE TO ALL EXISTING CONDITIONS TO REMAIN WILL BE REPLACED AT THE CONTRACTOR'S EXPENSE.
- 22. ALL SIGNS, STRIPING AND OTHER FEATURES THAT WERE IMPACTED OR DISTURBED SHALL BE RESTORED.
- 23. THE CONTRACTOR SHALL REFER TO THE LANDSCAPING PLAN FOR INFORMATION PERTAINING TO THE EXISTING TREES TO REMAIN DURING CONSTRUCTION.
- 24. TREES TO REMAIN SHALL BE PROTECTED PER DETAIL. THE CONTRACTOR SHALL BE RESPONSIBLE FOR ALL COSTS ASSOCIATED WITH TREE PROTECTION. IF TREES INDICATED TO REMAIN ARE DAMAGED OR REMOVED, THE CONTRACTOR SHALL BE RESPONSIBLE FOR ALL COSTS ASSOCIATED WITH REPLACEMENT OF THE TREE(S) AT THE OWNER'S AND/OR TOWN OF DRYDEN'S DISCRETION.
- 25. NO WORK OR EQUIPMENT IS ALLOWED ON THE ADJACENT PROPERTIES WITHOUT WRITTEN CONSENT OF PROPERTY OWNER(S), EXCEPT AS SHOWN.
- 26. THE CONTRACTOR SHALL PROTECT ALL PROJECT BENCHMARKS, PROPERTY CORNERS, AND SURVEY MONUMENTS/MARKERS THROUGHOUT CONSTRUCTION.
- 27. THE CONTRACTOR SHALL REMOVE AND RETURN ALL WATER METERS TO THE TOWN OF DRYDEN WATER AUTHORITY.
- COMPONENTS AND ANY REMAINING SANITARY SEWAGE IN A LEGAL MANNER. 29. THE PRESENCE OR ABSENCE OF EXISTING WELLS IS UNKNOWN. IF ENCOUNTERED, ALL EXISTING WELLS LOCATED WITHIN THE SITE DEVELOPMENT AREA SHALL BE REMOVED AND ABANDONED IN ACCORDANCE WITH NYSDOH REQUIREMENTS. WHICH INCLUDES: COMPLETE WELL CASING REMOVAL AND BACKFILLING WELL
- HOLE WITH NEAT CEMENT GROUT. DEPTH, TYPE, ETC. OF EXISTING WELLS UNKNOWN. CONTRACTOR TO CONFIRM CONDITION OF WELLS TO BE ABANDONED AND ABANDONMENT PROCEDURES PRIOR TO THE START OF WORK.
- 30. THE LOCATION OF EXISTING WATER SERIVCE(S) IS UNKNOWN. THE CONTRACTOR SHALL LOCATE THE SERVICES NEEDING REMOVAL/DECOMMISSIONING PRIOR TO THE START OF WORK. THOSE WATER SERVICES TO BE DECOMMISSIONED SHALL BE DECOMMISSIONED AT THE SERVICE TAP. EXISTING CORPORATION TAP REMOVED AND PLUGGED. CONTRACTOR SHALL COORDINATE WORK SCOPE AND SCHEDULE WITH BOLTON POINT. LIMIT AND LOCATION OF EXCAVATION ASSOCIATED WITH THE SERVICE TAP REMOVAL SHALL BE COORDINATED BY THE CONTRACTOR.



39 CASCADE DRIVE ROCHESTER, NY 14614 5 8 5 - 4 5 8 - 7 7 7 0 ITHACA LOCATION

840 HANSHAW RD, STE 12 ITHACA, NY 14850 6 0 7 - 2 4 1 - 2 9 1 7 www.marathoneng.com

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JOB NO: 1096-20 SCALE: 1"=30' DRAWN: AXADESIGNED: AMF DATE: 7/22/20 REVISIONS

TERSE( DRYDEI

DATE BY REVISION 8/28/20 AMF RE\ VISIONS PER PLANNING BOA COMMENTS


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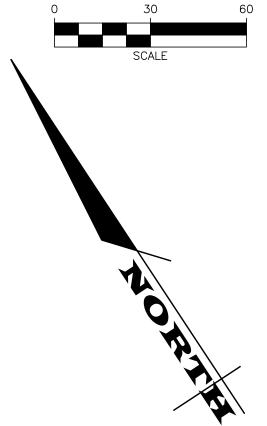
ADAM M. FISHEL


DRAWING TITLE: Demo Plan

SHEET No: 1096-20

DRAWING No:



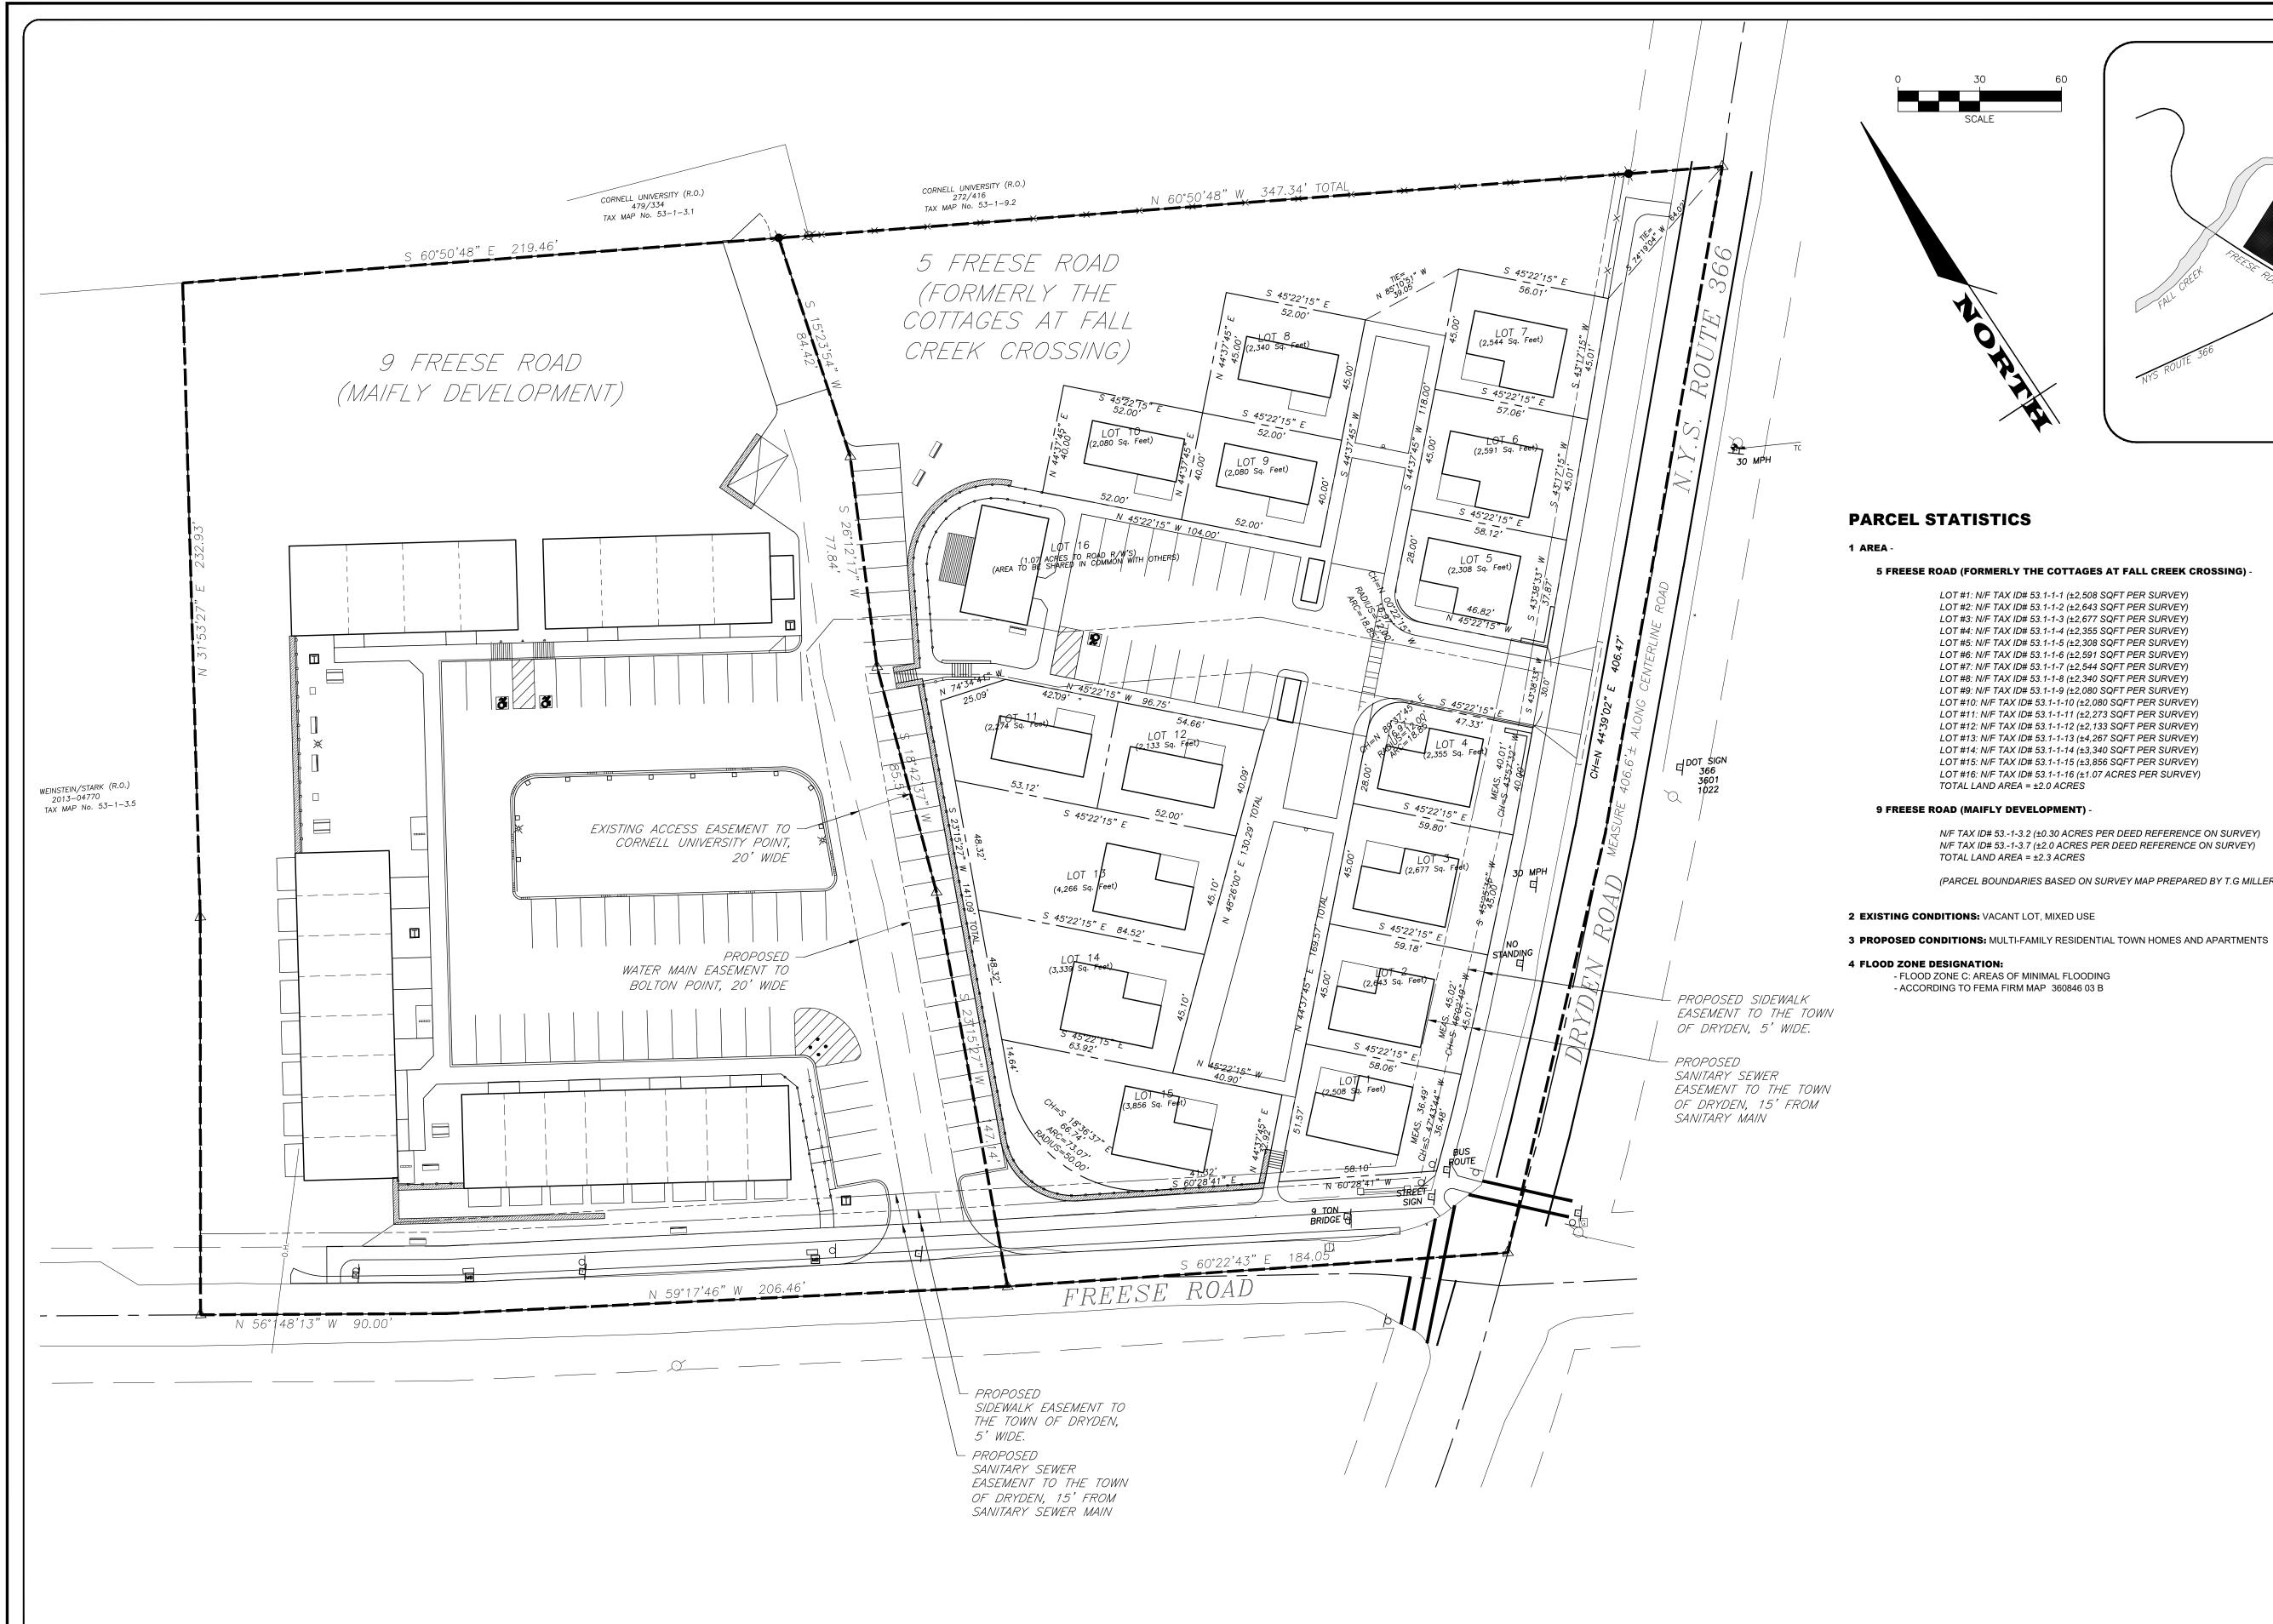

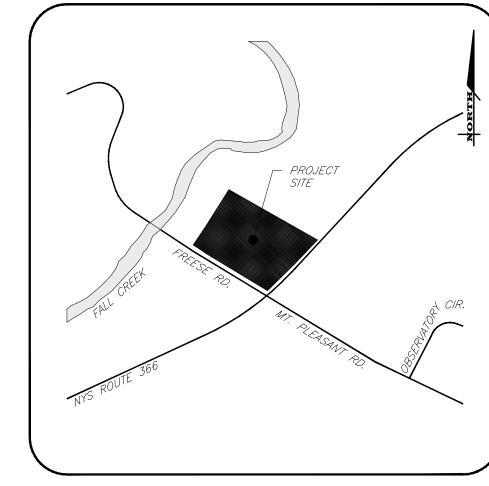

### 5 FREESE ROAD (FORMERLY THE COTTAGES AT FALL CREEK CROSSING)

LOT #1: N/F TAX ID# 53.1-1-1 (±2,508 SQFT PER SURVEY) LOT #2: N/F TAX ID# 53.1-1-2 (±2,643 SQFT PER SURVEY) LOT #3: N/F TAX ID# 53.1-1-3 (±2,677 SQFT PER SURVEY) LOT #4: N/F TAX ID# 53.1-1-4 (±2,355 SQFT PER SURVEY) LOT #5: N/F TAX ID# 53.1-1-5 (±2,308 SQFT PER SURVEY) LOT #6: N/F TAX ID# 53.1-1-6 (±2,591 SQFT PER SURVEY) LOT #7: N/F TAX ID# 53.1-1-7 (±2,544 SQFT PER SURVEY) LOT #8: N/F TAX ID# 53.1-1-8 (±2,340 SQFT PER SURVEY) LOT #9: N/F TAX ID# 53.1-1-9 (±2,080 SQFT PER SURVEY) LOT #10: N/F TAX ID# 53.1-1-10 (±2,080 SQFT PER SURVEY) LOT #11: N/F TAX ID# 53.1-1-11 (±2,273 SQFT PER SURVEY) LOT #12: N/F TAX ID# 53.1-1-12 (±2,133 SQFT PER SURVEY) LOT #13: N/F TAX ID# 53.1-1-13 (±4,267 SQFT PER SURVEY) LOT #14: N/F TAX ID# 53.1-1-14 (±3,340 SQFT PER SURVEY) LOT #15: N/F TAX ID# 53.1-1-15 (±3,856 SQFT PER SURVEY) LOT #16: N/F TAX ID# 53.1-1-16 (±1.07 ACRES PER SURVEY)

N/F TAX ID# 53.-1-3.2 (±0.30 ACRES PER DEED REFERENCE ON SURVEY) N/F TAX ID# 53.-1-3.7 (±2.0 ACRES PER DEED REFERENCE ON SURVEY) TOTAL LAND AREA = ±2.3 ACRES

(PARCEL BOUNDARIES BASED ON SURVEY MAP PREPARED BY T.G MILLER P.C DATED 7-17-20)

### 2 EXISTING CONDITIONS: VACANT LOT, MIXED USE

- FLOOD ZONE C: AREAS OF MINIMAL FLOODING

MARATHON **ENGINEERING** 

> 39 CASCADE DRIVE ROCHESTER, NY 14614 5 8 5 - 4 5 8 - 7 7 7 0 ITHACA LOCATION 840 HANSHAW RD, STE 12

ITHACA, NY 14850 6 0 7 - 2 4 1 - 2 9 1 7 www.marathoneng.com

ROCHESTER LOCATION

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JOB NO: 1096-20 SCALE: 1"=30' DRAWN: AMF DESIGNED: AMF DATE: 7/30/20 REVISIONS DATE BY REVISION 8/28/20 AMF REVISIONS PER PLANNING BOAR COMMENTS


INTERSECT OF DRYDEN

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DRAWING TITLE: Overall Site Plan

ADAM M. FISHEL

SHEET No: 1096-20 JOB No: DRAWING No:

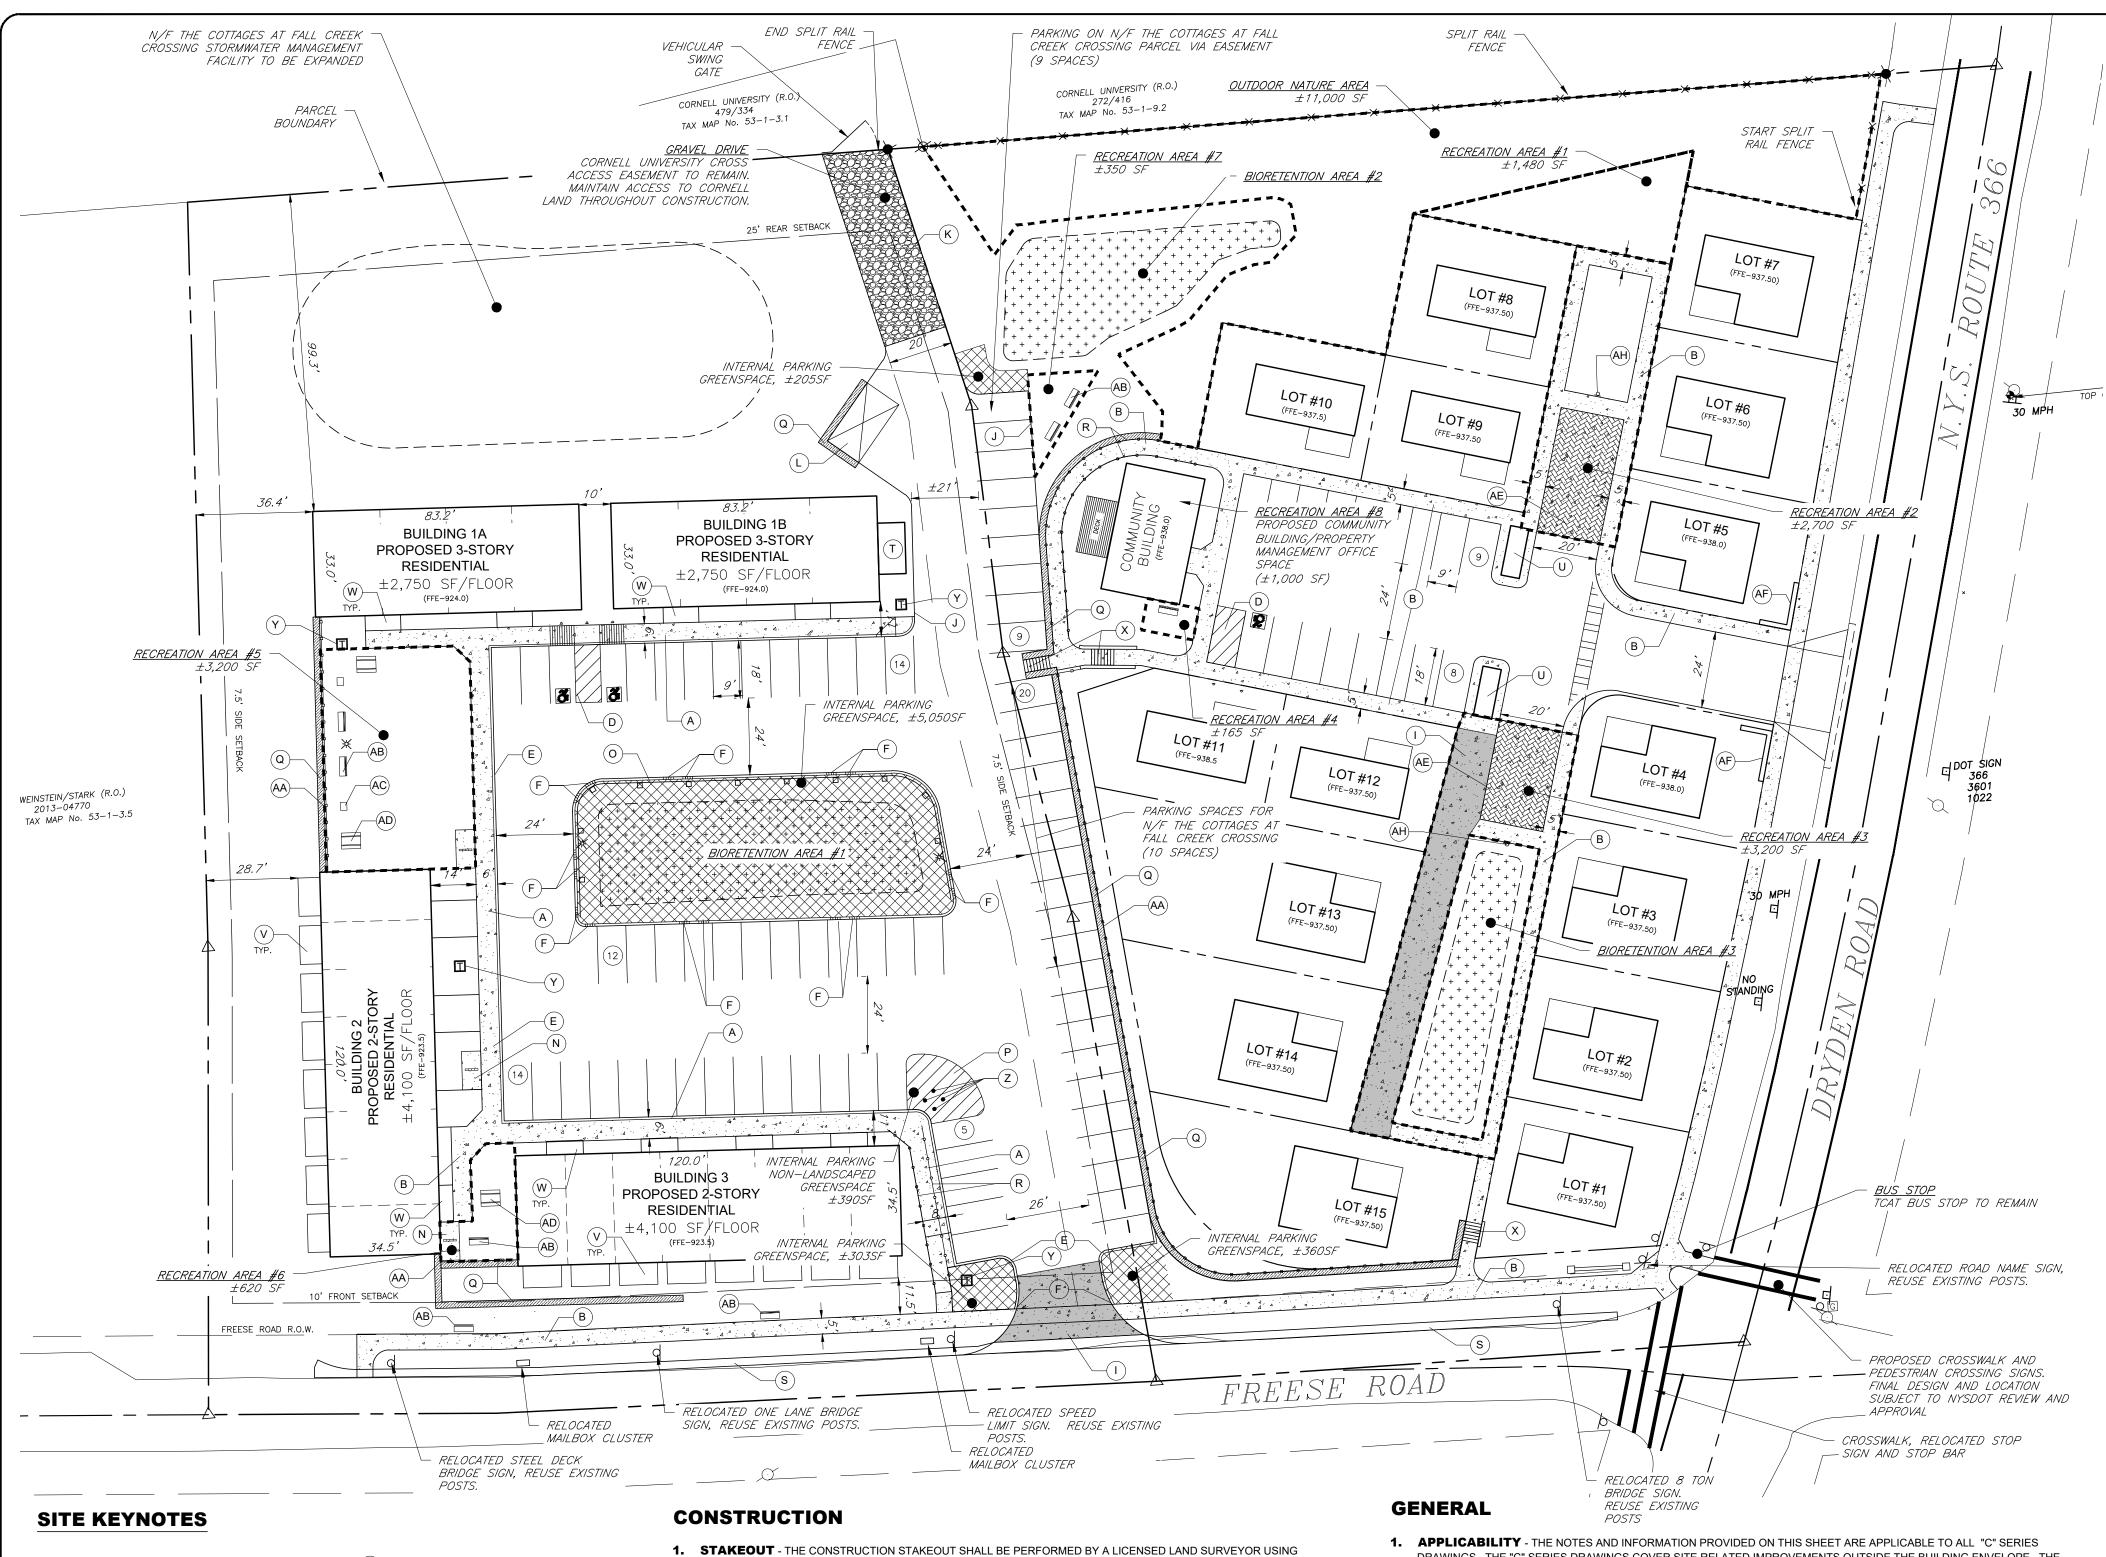

RAISED SIDEWALK WITH INTEGRAL CURBING, WIDTH (U) BIKE SHED, RE: ARCH SHOWN ON PLANS (V) DECK, RE: ARCH

(W) STOOP, RE: ARCH

(Y) TRANSFORMER

(Z) PIPE BOLLARDS

(AA) CHAIN LINK FENCE

PARK STYLE BENCHES. SIZE, TYPE, FINISH,

QUANTITY, ETC. TO BE SELECTED BY OWNER.

(AC) BBQ GRILL APPARATUS. TBD BY OWNER

(AD) WOODEN PICNIC TABLE. TBD BY OWNER

SEAT WALL, RE: ARCHITECTURAL PLANS

(AG) DEVELOPMENT SIGN, RE: ARCHITECTURAL PLANS

(AE) HEAVY DUTY STAMPED CONCRETE

(AH) "NO PARKING, FIRE LANE" SIGN

(x) STAIRS

- B CONCRETE SIDEWALK, WIDTH SHOWN ON PLANS
- C) ACCESSIBLE RAMP
- D ACCESSIBLE PARKING AND SIGNAGE (E) 18" CONCRETE CURBING
- F CURB TRANSITION
- (G) REGULAR DUTY ASPHALT PAVEMENT
- (H) HEAVY DUTY ASPHALT PAVEMENT
- HEAVY DUTY CONCRETE PAVEMENT
- EDGE OF PAVEMENT K GRAVEL ACCESS DRIVE
- DUMPSTER ENCLOSURE
- M) LIGHT FIXTURE


- O TIMBER GUIDE RAIL
- STRIPED AREA. EDGE LINES TO BE SWSL/4" AND P STRIPES ARE TO BE SWSL/4" 2'-0" O.C. @45° TO THE EDGE LINES.
- Q RETAINING WALL
- R) HANDRAIL
- S CONCRETE GUTTER
- MECHANICAL ROOM, RE: ARCH


- CONTROL PROVIDED ON THE "LAYOUT PLAN". THE BUILDING FOOTPRINT(S), DATED 08/18/20, WERE PROVIDED BY STREAM COLLABORATIVE. DISCREPANCIES WITH BUILDING(S), CONTROL POINTS, AND/ OR TIE DIMENSIONS SHALL BE REPORTED TO THE DESIGN ENGINEER (PRIOR TO THE INSTALLATION OF IMPROVEMENTS) FOR COORDINATION AND
- 2. BOUNDARY BOUNDARY INFORMATION WAS TAKEN FROM SURVEY TITLE PREPARED BY T.G MILLER P.C. DATED 08/13/2020 AND IS SHOWN FOR GRAPHICAL REPRESENTATION ONLY.
- 3. LAYOUT DIMENSIONS SHOWN, WHERE APPLICABLE, SHALL BE FROM THE FACE OF CURB UNLESS SPECIFICALLY
  - 4. **DEMOLITION** CLEARING AND GRUBBING SHALL BE LIMITED TO THE SITE BOUNDARIES OR WITHIN THE "WORK LIMIT LINE" AS DEFINED ON THE PLAN. TREES AND OBJECTS DESIGNATED FOR REMOVAL SHALL BE COORDINATED AND FIELD VERIFIED WITH PROJECT ON-SITE REPRESENTATIVE. ALL MATERIALS SHALL BE LEGALLY DISPOSED OF OFF-SITE OR RETURNED TO OWNER AS DIRECTED BY CONTRACT DOCUMENTS. ALL ITEMS NOT SPECIFICALLY CALLED OUT TO BE
  - 5. COORDINATION THE CONTRACTOR SHALL COORDINATE INSTALLATION OF UTILITY WORK WITH OTHER SITE UTILITIES (I.E. GAS, ELECTRIC, LIGHTING, COMMUNICATIONS) TO AVOID POTENTIAL INSTALLATION CONFLICTS.
  - 6. STAGING AS DEFINED BY THE CONTRACT DOCUMENTS THE CONTRACTOR SHALL CONSTRUCT A SECURE STAGING AREA FOR STORAGE OF EQUIPMENT, MATERIALS, EMPLOYEE PARKING AND OFFICE SPACE. IF THE AREA/METHOD IS NOT SPECIFICALLY DEFINED ON THE DOCUMENTS THEN IT SHALL BE COORDINATED WITH THE OWNER'S ON-SITE
  - 7. CLOSE-OUT THE CONTRACTOR'S WORK SCOPE INCLUDES BUT IS NOT LIMITED TO THE FOLLOWING AT PROJECT
  - CLOSE-OUT TO THE SATISFACTION OF OWNER'S ON-SITE REPRESENTATIVE:

REMOVED SHALL REMAIN.

- REMOVAL OF ANY CONSTRUCTION DEBRIS. CLEANING PAVEMENT AND WALKWAY SURFACES.
- RESTORATION OF ALL DISTURBED GRASS AND LANDSCAPED AREAS. • PROVIDING BONDS, GUARANTEES, CERTIFICATIONS, ETC. AS REQUIRED BY CONTRACT DOCUMENTS.
- PROVIDING REDLINES FOR RECORD DRAWING. • COMPLETION OF FINAL PUNCH LIST ITEMS.

- DRAWINGS. THE "C" SERIES DRAWINGS COVER SITE RELATED IMPROVEMENTS OUTSIDE THE BUILDING ENVELOPE. THE BUILDING ENVELOPE INCLUDES ALL AREA WITHIN 5' OUTSIDE OF THE BUILDING'S EXTERIOR WALL.
  - 2. MAPPING THE EXISTING UNDERGROUND UTILITIES WERE PLOTTED BASED ON RECORD MAPPING SUPPLIED BY OTHERS. THE ENGINEER MAKES NO WARRANTY AS TO THE LOCATION, SIZE, TYPE, ELEVATION, AND/OR NUMBER OF EXISTING UTILITIES. THE CONTRACTOR SHALL BE RESPONSIBLE FOR DETERMINING THE HORIZONTAL AND VERTICAL LOCATION OF UTILITIES IN THE
  - 3. UTILITY STAKEOUT THE CONTRACTOR SHALL NOTIFY DIG SAFELY NEW YORK (1-800-962-7962) FOR A UTILITY STAKEOUT 48 HOURS IN ADVANCE OF COMMENCING WORK. STAKEOUT OF PRIVATE UTILITIES SHALL BE COORDINATED WITH THE OWNER.
  - 4. PROPERTY PROTECTION THE CONTRACTOR IS RESPONSIBLE FOR DAMAGE TO EXISTING PAVEMENT, CURBS, WALKS, LAWNS, TREES, ETC. CAUSED BY THEIR CONSTRUCTION OPERATIONS. ALL DAMAGE SHALL BE REPAIRED OR REPLACED BY THE CONTRACTOR TO THE OWNER'S SATISFACTION AT NO ADDITIONAL EXPENSE.
  - ACCESS THE CONTRACTOR SHALL PROVIDE SATISFACTORY VEHICULAR ACCESS TO ALL ADJOINING PROPERTIES, PRIVATE ROADWAYS, PARKING FACILITIES, AND PUBLIC STREETS DURING CONSTRUCTION.
  - 6. SITE SAFETY PRIOR TO AND THROUGHOUT CONSTRUCTION, THE CONTRACTOR SHALL POST SIGNAGE IN CONFORMANCE WITH THE REQUIREMENTS OF THE LOCAL MUNICIPALITY AND OCCUPATIONAL HEALTH AND SAFETY ACT (OHSA). JOB SAFETY AND MAINTENANCE AND PROTECTION OF TRAFFIC IS THE RESPONSIBILITY OF THE CONTRACTOR.
  - 7. **EXCAVATIONS** ALL EXCAVATIONS SHALL BE BACKFILLED/BARRICADED TO THE SATISFACTION OF THE OWNER'S REPRESENTATIVE AT THE CONCLUSION OF EACH WORKING DAY.
  - 8. MAINTENANCE PUBLIC STREETS, PRIVATE DRIVES AND PARKING FACILITIES SHALL BE KEPT FREE OF FOREIGN MATERIALS. ALL AREAS SHALL BE SWEPT CLEAN AT THE END OF EACH WORKING DAY AND/OR AS DIRECTED BY THE OWNER'S ON-SITE REPRESENTATIVE.
  - 9. CONSTRUCTION STORAGE STORAGE OF EQUIPMENT AND MATERIALS SHALL BE WITHIN A SPECIFIED AND SECURED AREA AS DETERMINED IN CONTRACT DOCUMENTS OR AS SPECIFIED BY THE OWNER'S ON-SITE REPRESENTATIVE.
  - 10. PERMIT(S) PRIOR TO CONSTRUCTION, THE CONTRACTOR SHALL OBTAIN THE NECESSARY PERMITS FROM THE APPLICABLE MUNICIPALITY OR AGENCY. THE CONTRACTOR IS RESPONSIBLE FOR ALL BONDS AND INSURANCES AND THE OWNER IS RESPONSIBLE FOR PERMIT FEES UNLESS OTHERWISE STATED IN THE OWNER/ CONTRACTOR AGREEMENT
  - 11. INTERIM CONDITIONS THE CONTRACTOR IS RESPONSIBLE TO MAINTAIN POSITIVE DRAINAGE AWAY FROM BUILDINGS AND WITHIN PROJECT AREA TO A STABILIZED OUTLET THROUGHOUT THE CONSTRUCTION PERIOD. THIS MAY REQUIRE INTERIM GRADING, SHIMMING OF PAVEMENT ETC. THAT IS NOT SPECIFICALLY SHOWN ON THE PLANS AND SHALL BE THE RESPONSIBILITY OF THE CONTRACTOR.
  - 12. SPECIFICATIONS TECHNICAL SPECIFICATIONS. IF SUPPLIED AS PART OF CONTRACT DOCUMENTS. ARE INTENDED TO AID AND HELP DEFINE THE CONTRACTOR'S WORK SCOPE. IF DISCREPANCIES OCCUR THE CONTRACTOR SHALL REQUEST A CLARIFICATION.

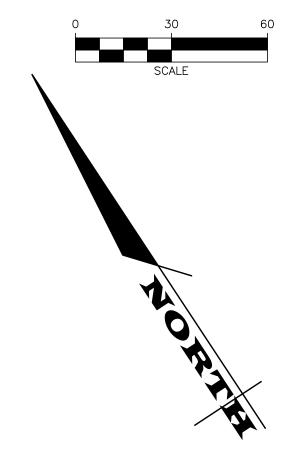

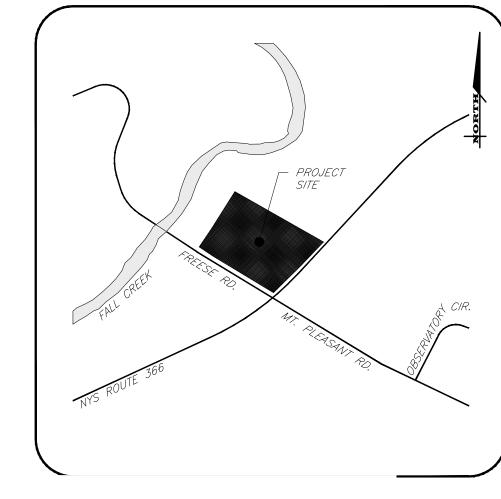

### **PROJECT STATISTICS**

### 1. GENERAL:

- 1.1 PROPERTY OWNER MAIFLY DEVELOPMENT
- 1.2 PROPERTY ADDRESS 5 & 9 FREESE ROAD ITHACA, NEW YORK 14850
- 1.3 TAX ACCOUNT SEE OVERALL PLAN

### 2. ZONING REGULATIONS:

2.1 ZONING DISTRICT - VHMUD - VARNA HAMLET MIXED USE DISTRICT

2.2 CODE REQUIREMENTS - (ASSOCIATED WITH 9 FREESE ROAD SITE UNLESS STATED OTHERWISE)

	REQUIRED	PROVIDED
MINIMUM LOT SIZE	1 AC	± 2.3 AC
MINIMUM LOT FRONTAGE	45'	± 292'
MINIMUM FRONT YARD SETBACK	10'	11.5'
MINIMUM SIDE YARD SETBACK	7.5'	28.7'
MINIMUM REAR YARD SETBACK	25'	99.3'
MAXIMUM BUILDING HEIGHT	40'	±33'
MAXIMUM BUILDING FOOTPRINT	5,000 SF	±4,100 SF
MINIMUM GREEN SPACE (5 FREESE RD.)	40%	±60%**
MINIMUM GREEN SPACE (9 FREESE RD.)	40%	±45%**
MINIMUM INTERNAL GREENSPACE WITHIN PARKII	VG ±5,300 SF	±6,305 SF
MINIMUM PARKING SPACE SIZE	9x20'	9x18*
NUMBER OF PARKING SPACES (5 FREESE RD.)		
STANDARD SPACES	15	<u>35</u>
TOTAL	15 ***	35 ****, ****
PARKING RATIO (SPACES/DWELLING UNIT)	1.2 MAX	2.33
NUMBER OF PARKING SPACES (9 FREESE RD.)		
STANDARD SPACES	30	53
ADA ACCESSIBLE SPACES	2	3
TOTAL	32 ***	56 ****
PARKING RATIO (SPACES/DWELLING UNIT)	1.2 MAX	1.75

MAXIMUM ALLOWABLE DENSITY: TOWNHOUSE

10 UNITS / ACRE GREEN DEVELOPMENT BONUS 2 UNITS / ACRE REDEVELOPMENT BONUS 2 UNITS / ACRE TOTAL 14 UNITS / ACRE

RENTAL APARTMENTS BASE ZONING 6 UNITS / ACRE GREEN DEVELOPMENT BONUS 4 UNITS / ACRE REDEVELOPMENT BONUS 4 UNITS / ACRE 14 UNITS / ACRE

\*\* GREEN SPACE DETERMINED FROM LOT AREA TO FREESE ROAD CENTERLINE. \*\*\* ONE PARKING SPACE PER DWELLING UNIT IS MINIMUM REQUIRED. \*\*\* MAX ALLOWABLE NUMBER OF PARKING SPACES IS 120% OF MINIMUM REQUIRED UNLESS EXPRESSLY APPROVED BY THE TOWN OF DRYDEN PLANNING BOARD.

SMALLER PARKING SPACES ARE ALLOWED SUBJECT TO PLANNING BOARD APPROVAL.

\*\*\*\* BASED ON SITE LAYOUT PLAN INCLUDED AS PART OF THE TOWN OF DRYDEN'S SUBDIVISION APPROVAL FOR "THE COTTAGES AT FALL CREEK CROSSING" APPROVED ON 12/21/16.

### 3. PARCEL STATISTICS:

2.3 VARIANCES - NONE

REFER TO SHEET C2.0 FOR PARCEL STATISTICS

### 4. PROPOSED BUILDING:

4.1 5 FREESE ROAD (FORMERLY THE COTTAGES AT FALL CREEK CROSSING PORTION): 5 2-BEDROOM UNITS

10 3-BEDROOM UNITS

TOTAL = 15 UNITS WITH 40 BEDROOMS TOTAL

### 4.2 9 FREESE ROAD (MAIFLY PORTION):

BUILDING 1A (3-STORY) - ±8,250 SF, TOTAL (APARTMENT BUILDING PROVIDING 1, 2 & 3 BEDROOM UNITS) BUILDING 1B (3-STORY) - ±8,250 SF, TOTAL (APARTMENT BUILDING PROVIDING 1, 2 & 3 BEDROOM UNITS) BUILDING 2 (2-STORY) - ±8,200 SF, TOTAL (TOWN HOMES PROVIDING 1, 2 & 3 BEDROOM UNITS) BUILDING 3 (2-STORY) - ±8,200 SF, TOTAL (TOWN HOMES PROVIDING 1, 2 & 3 BEDROOM UNITS) TOTAL = ±32,900 SF , TOTALING 32 DWELLING UNITS

TOTAL PROPOSED LOT DENSITY: 32 UNITS / 2.3 ACRES = 13.9 UNITS/ACRE.

### 5. POCKET PARK/RECREATION AMENITY SUMMARY:

FREESE ROAD	
- COMMUNITY BUILDING	±1,000 SF
- RECREATION AREA #1	±1,065 SF
- RECREATION AREA #2	±2,700 SF
- RECREATION AREA #3	±3,200 SF
- RECREATION AREA #4	±165 SF
- OUTDOOR NATURE AREA	±11,415 SF
SUBTOTAL	±19,545 SF
FREESE ROAD	
- RECREATION AREA #5	±3,200 SF
- RECREATION AREA #6	±620 SF
- RECREATION AREA #7	±350 SF
SUBTOTAL	±4,170 SF

### GRAND TOTAL ±23,715 SF

### - RECREATION SPACE DENSITY = ±741 SF/UNIT

BASED ON RECREATIONAL AREAS AVAILABLE TO ALL TENANTS/OWNERS INCLUDED IN THIS DEVELOPMENT. OPEN LAWN SPACE ASSOCIATED WITH 5 FREESE ROAD LOTS IS NOT INCLUDED.

REFER TO SHEET C2.2 FOR ENLARGEMENTS OF RECREATION AND OUTDOOR NATURE AREAS.

### **5 FREESE ROAD PRIVATE YARD AREA**

- USABLE YARD AREA TYP. OF 15 LOTS ±1,560 SF /PRIVATE YARD PRIVATE YARD AREA TOTAL ±23,400 SF

- RECREATION SPACE DENSITY = ±1,560 SF/UNIT



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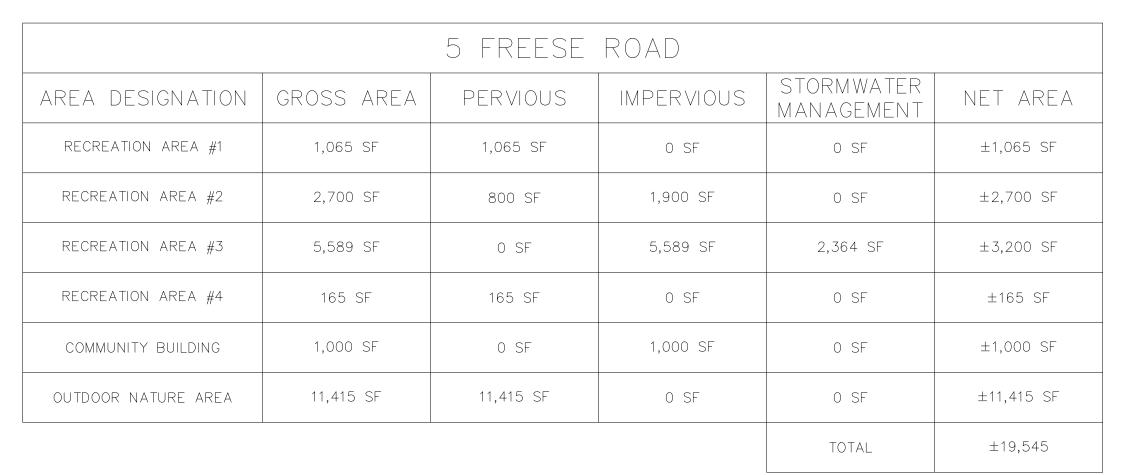
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1096-20 JOB NO: SCALE: 1"=30' DRAWN: DESIGNED: AMF 3/11/20 REVISIONS DATE BY REVISION 5/20/20 AXA 8/28/20 AMF REVISIONS PER PLANNING BOARD 9/28/20 AXA RECREATION AREA REVISIONS 10/16/20 AMF REVISIONS PER PLANNING BOAF COMMENTS COPYRIGHT<sup>©</sup> 2020 MARATHON ENG.


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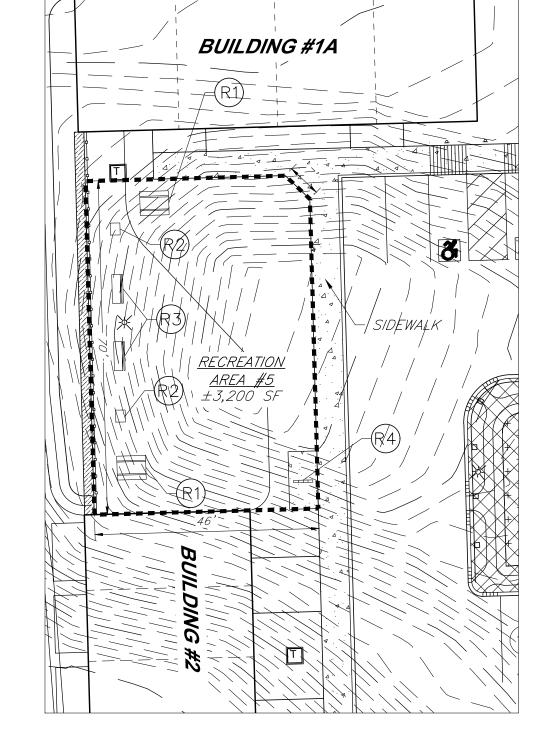
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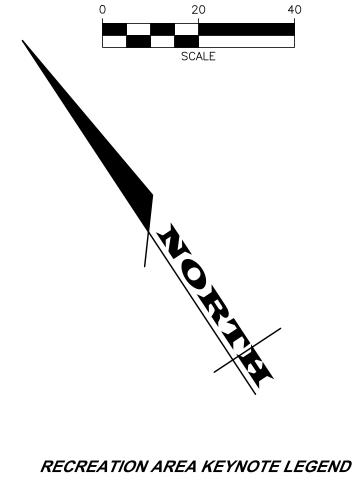
CONSTRUCTION



9 FREESE ROAD						
AREA DESIGNATION	GROSS AREA	PERVIOUS	IMPERVIOUS	STORMWATER MANAGEMENT	net area	
RECREATION AREA #5	3,200 SF	3,128 SF	72 SF	0 SF	±3,200 SF	
RECREATION AREA #6	620 SF	548 SF	72 SF	0 SF	±620 SF	
RECREATION AREA #7	350 SF	350 SF	0 SF	0 SF	±350 SF	
				TOTAL	±4,170	






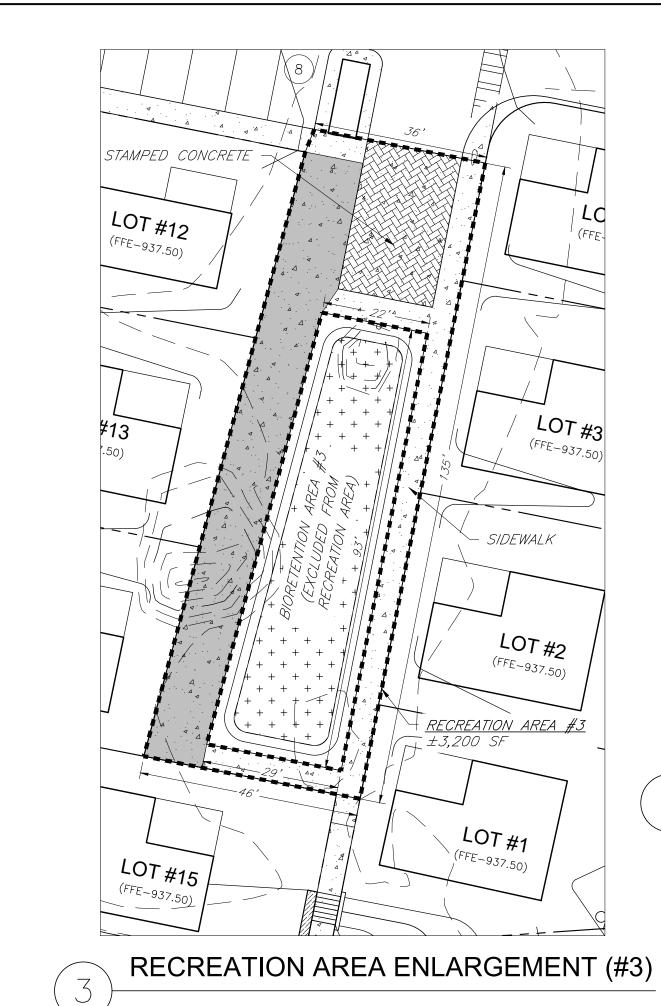



- (R1) WOODEN PICNIC TABLES, TBD BY OWNER
- BBQ GRILL APPARATUS, TBD BY OWNER
- (R3) PARK STYLE BENCHES, TBD BY OWNER
- (R4) BIKE RACK


**RECREATION AREA ENLARGEMENT (#5)** 

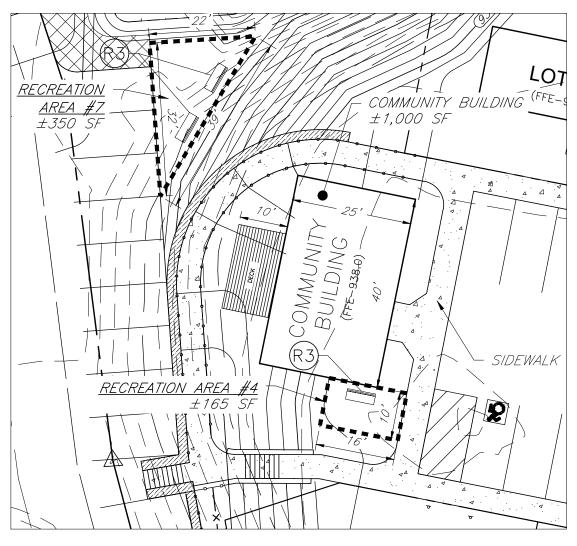

RECREATION AREA ENLARGEMENT (#4, #7, & #8)

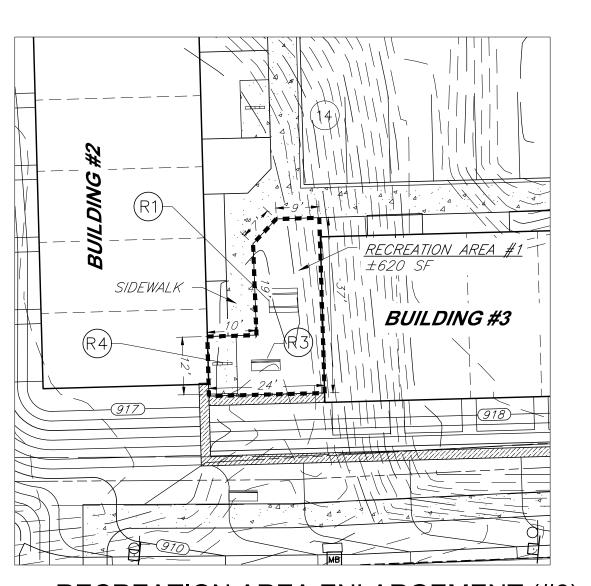

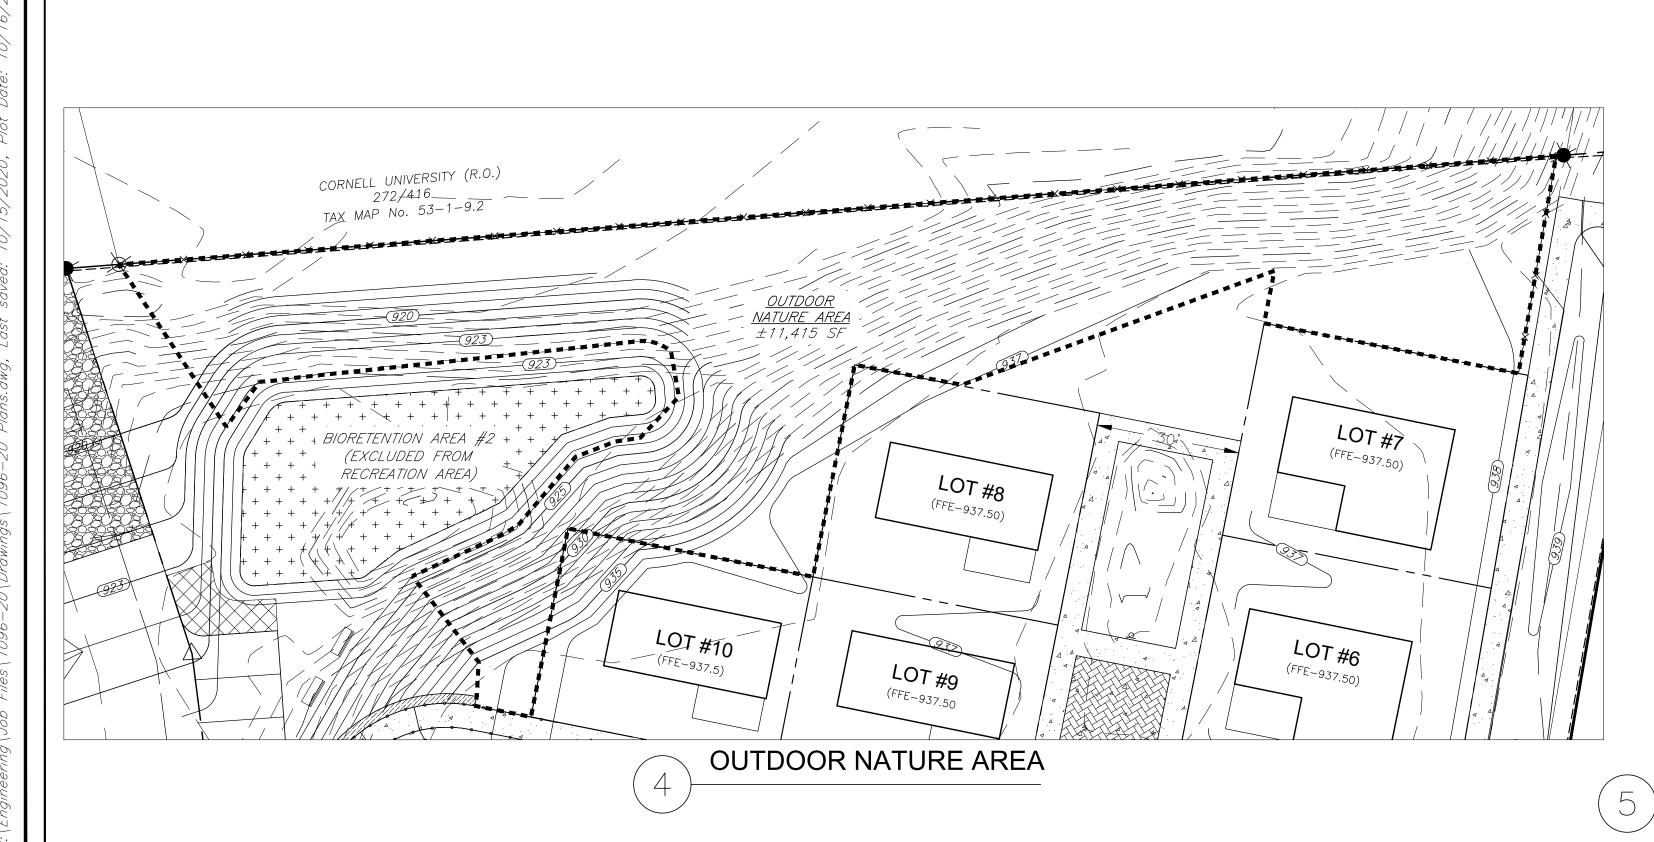

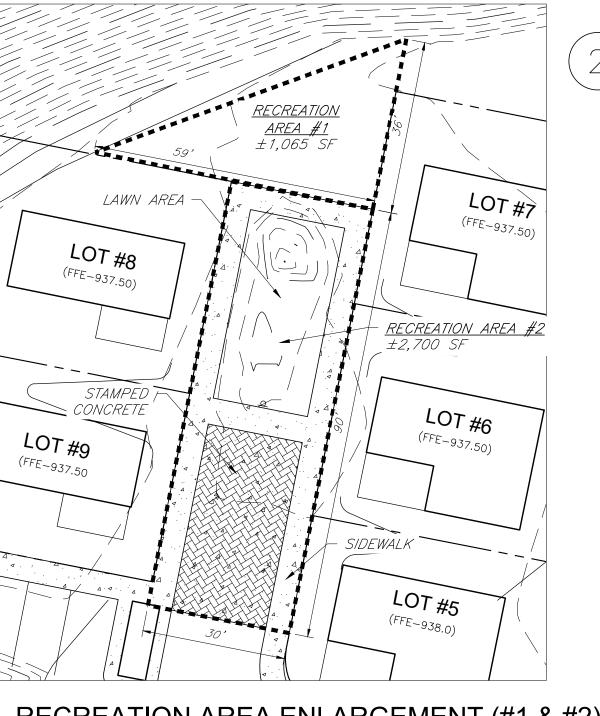

RECREATION AREA ENLARGEMENT (#1 & #2)

RECREATION AREA ENLARGEMENT (#6)



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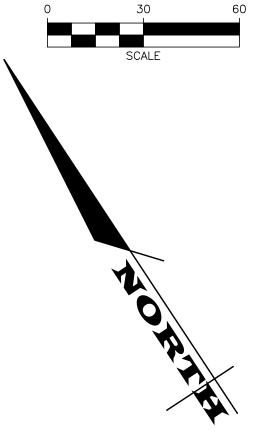
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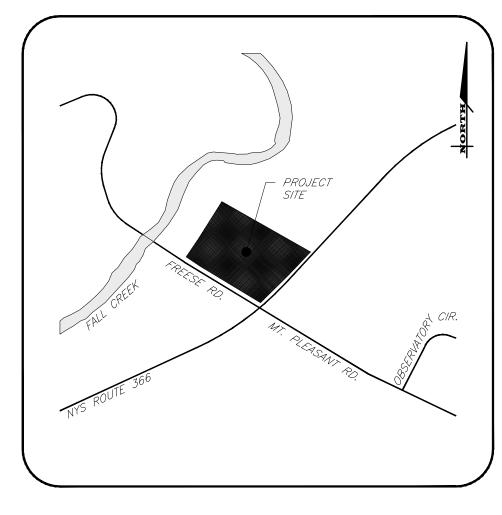
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DRAWING TITLE: Recreation Area Enlargements Plan

ADAM M. FISHEL







### **EROSION CONTROL**

- 1. CERTIFICATION THE STORM WATER POLLUTION PREVENTION PLAN (SWPPP), WHICH INCLUDES THE "GRADING PLAN", "EROSION CONTROL PLAN", "EROSION CONTROL NOTES", ALONG WITH THE "DRAINAGE REPORT", DEFINES AND MEETS THE REQUIREMENTS OF THE NEW YORK STATE DEPARTMENT OF ENVIRONMENTAL CONSERVATION (NYSDEC) LATEST STORM WATER REGULATIONS.
- 2. CONTRACTOR RESPONSIBILITY ALL CONTRACTORS AND SUB-CONTRACTORS SHALL CERTIFY WITHIN THE SWPPP THAT THEY WILL IMPLEMENT AND MAINTAIN STORM WATER MANAGEMENT PRACTICES.
- 3. INSPECTION EROSION CONTROL (EC) MEASURES INSTALLED AND MAINTAINED BY THE SITE WORK CONTRACTOR ARE SUBJECT TO THE REVIEW AND APPROVAL OF THE: MUNICIPALITY, DESIGN ENGINEER, NYSDEC, AND OWNER'S REPRESENTATIVE. IMMEDIATE ACTION BY THE CONTRACTOR SHALL BE TAKEN IF ADDITIONAL OR CORRECTIVE MEASURES ARE REQUIRED BY ANY ONE OF THESE CITED REVIEWERS. EROSION CONTROL MEASURES NOT SPECIFICALLY SHOWN ON CONTRACT DRAWINGS (I.E., STRAW BALES, COLLARS, FABRICS, ETC.) SHALL BE INSTALLED AS WARRANTED BY FIELD CONDITIONS, AND AS DIRECTED BY THE AFOREMENTIONED
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- 5. PRE-CONSTRUCTION THE APPROPRIATE EROSION CONTROL MEASURES AS DEFINED BY THE CONSTRUCTION DOCUMENTS SHALL BE INSTALLED PRIOR TO THE START OF ANY CONSTRUCTION ACTIVITIES. A PRE-CONSTRUCTION MEETING WITH THE TOWN OF DRYDEN SHALL OCCUR PRIOR TO THE START OF ANY CONSTRUCTION ACTIVITIES.
- 6. TOPSOIL UPON COMPLETION OF THE STOCKPILE STRIPPING OPERATION, STOCKPILES SHALL BE STABILIZED IN ACCORDANCE TO NYSDEC REGULATIONS.
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- 8. DUST THE CONTRACTOR SHALL APPLY WATER AND/OR CALCIUM CHLORIDE, AS CONDITIONS WARRANT, TO CONTROL WIND BORN EROSION. THIS MEASURE APPLIES TO: HAUL ROADS, CUT AND FILL OPERATIONS, SUB-BASE AND ANY OTHER EXPOSED SURFACES.
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- 13. SUBSOIL RESTORATION ALL AREAS TO BE RESTORED AS LAWN SHALL BE RESTORED PER CHAPTER 5 (5.1.6) OF THE NEW YORK STATE STORMWATER DESIGN MANUAL AND THE SOIL RESTORATION TABLE (TABLE 5.3 -SOIL RESTORATION REQUIREMENTS) SHOWN ON THE PLANS. THE PROJECT SOILS ARE HYDROLOGIC SOIL GROUP \_ AND SHALL BE RESTORED AS SPECIFIED.
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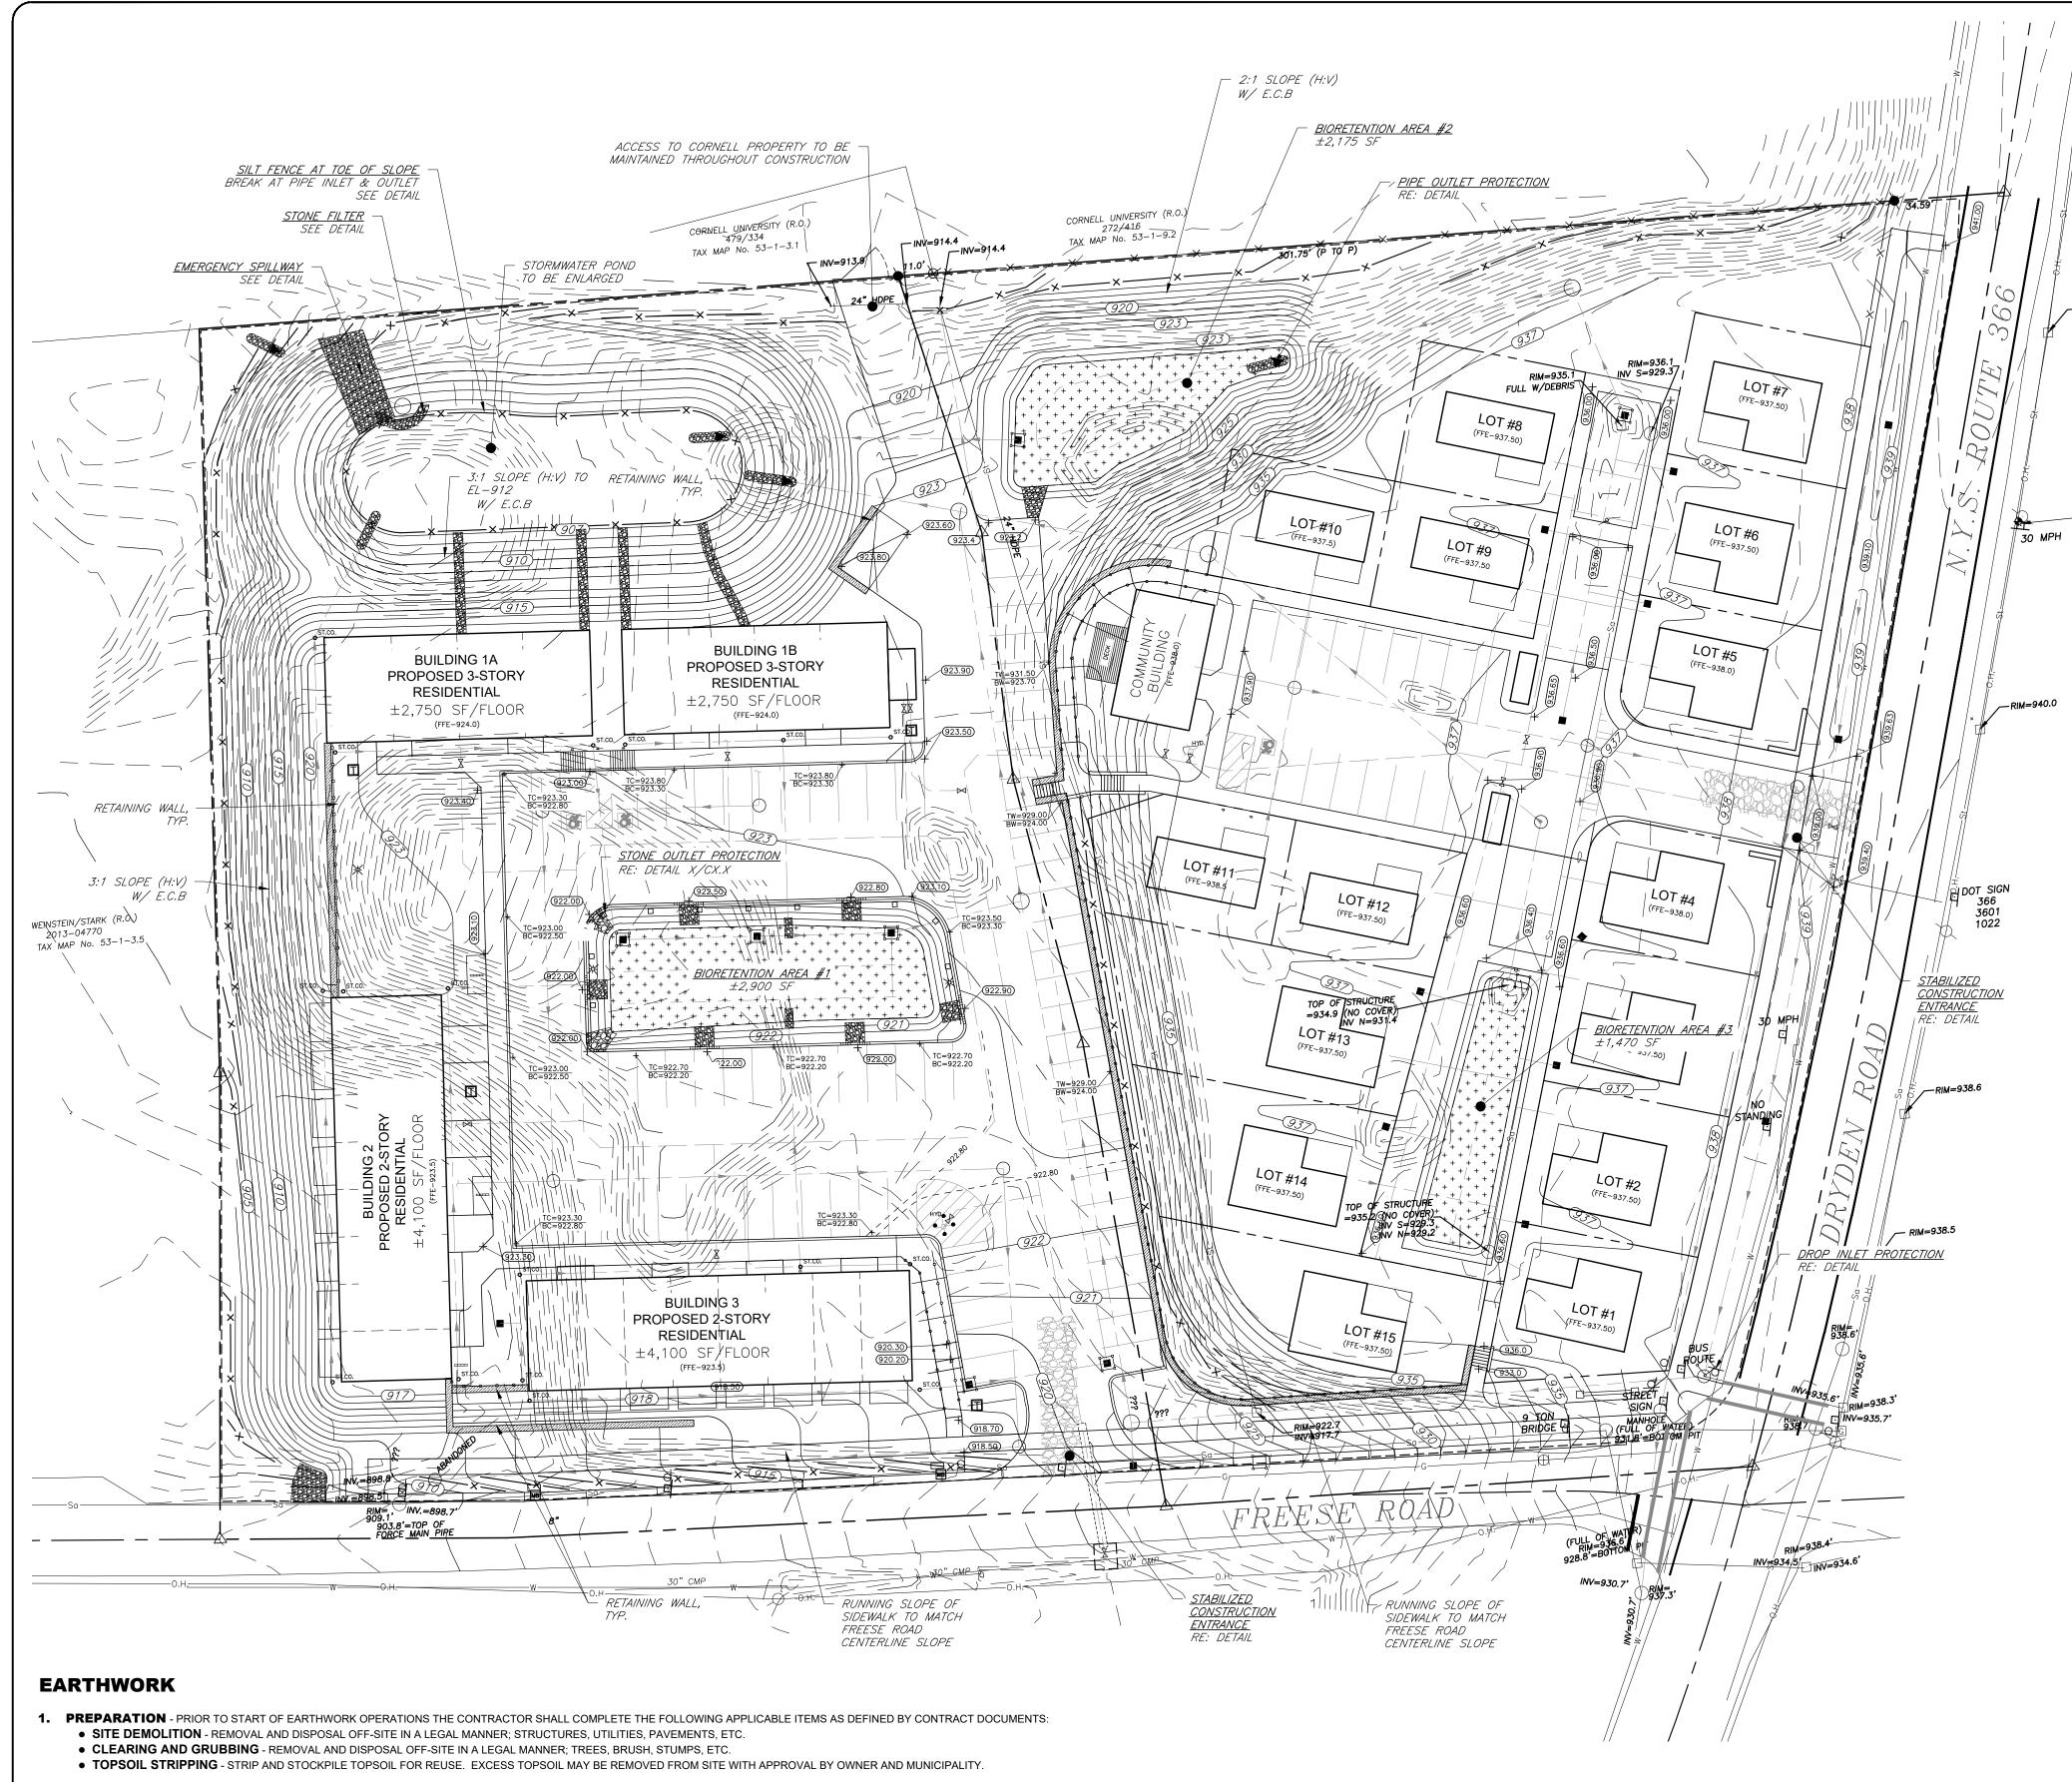
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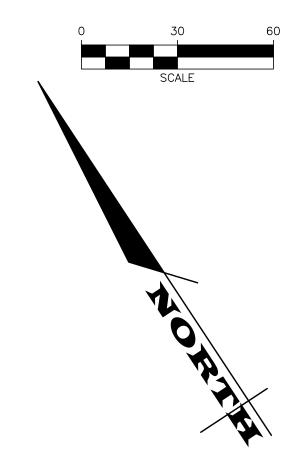
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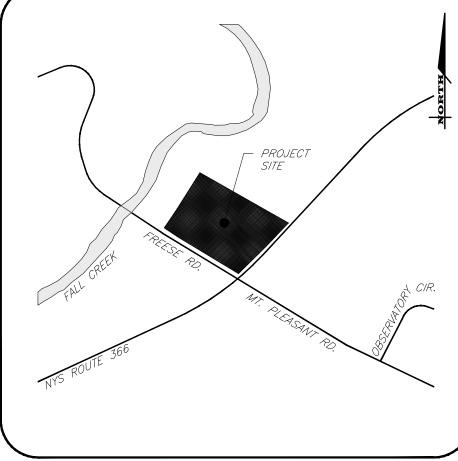
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DRAWING TITLE: Grading, Drainage & **Erosion Control Plan** (1 of 2)








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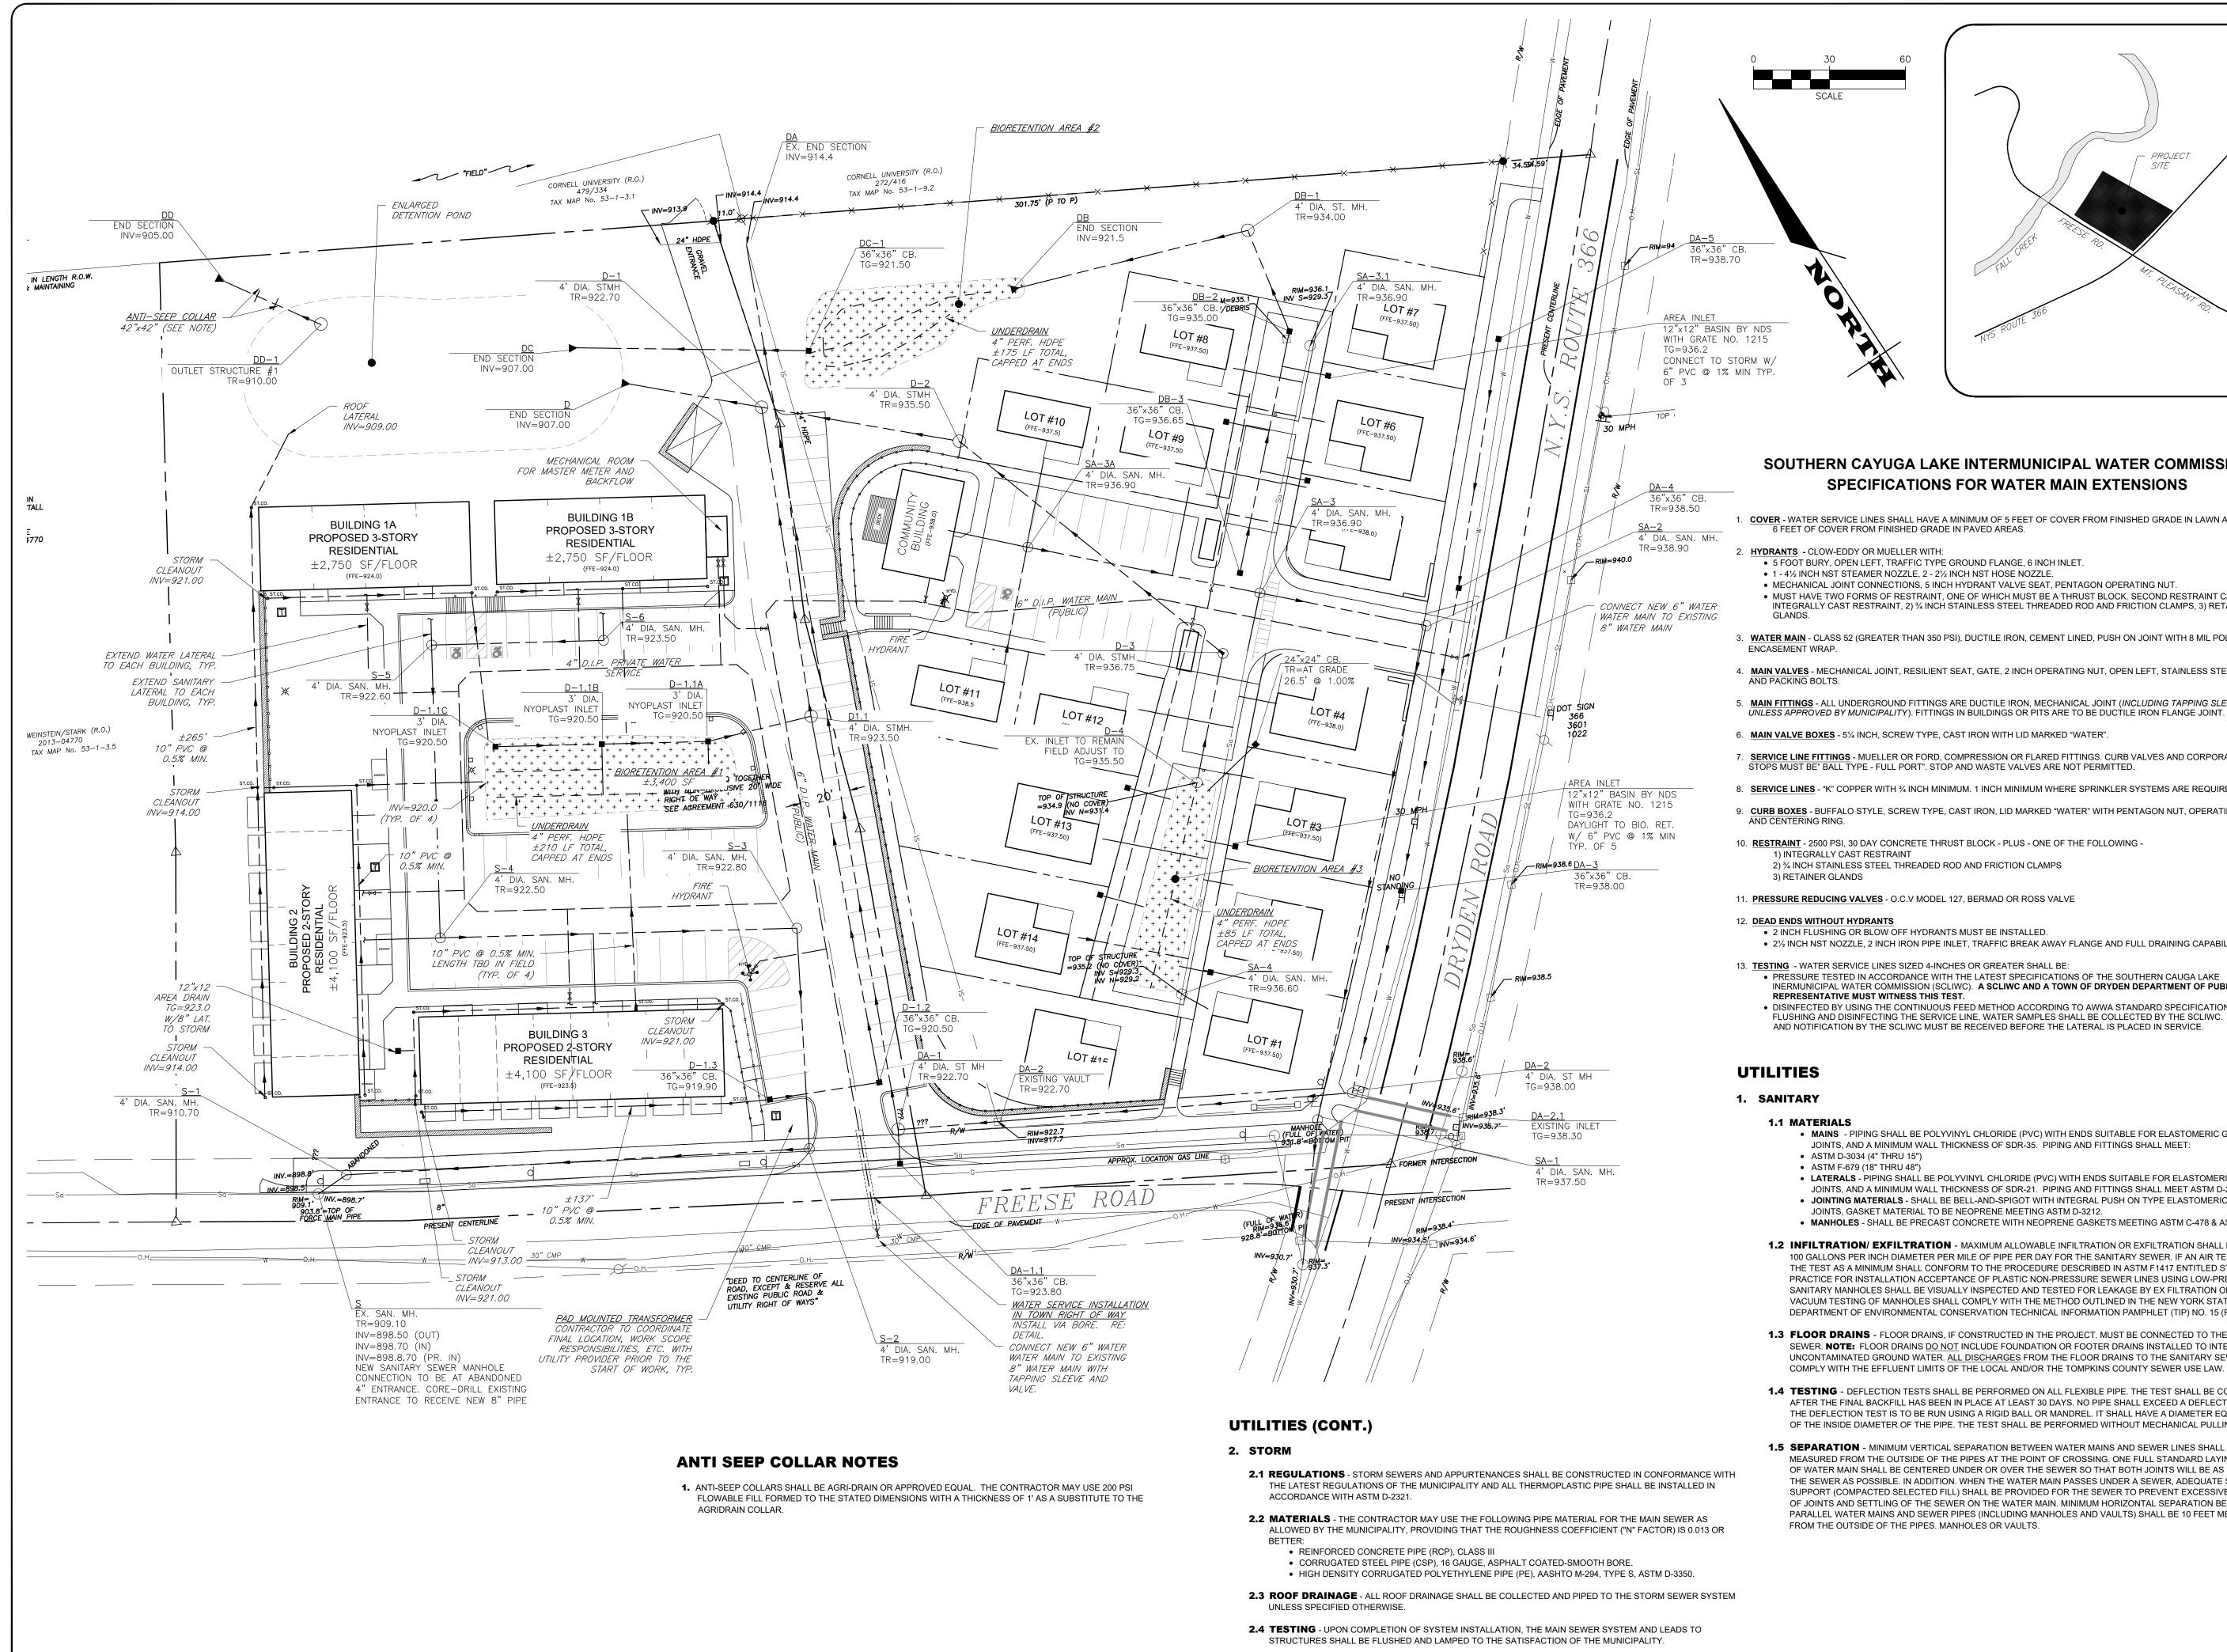
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DRAWING TITLE: Grading, Drainage & **Erosion Control Plan** (2 of 2)

- **2. RESPONSIBILITY** THE CONTRACTOR IS RESPONSIBLE FOR:
  - ESTIMATE COMPLETION OF A QUANTITY TAKEOFF TO DETERMINE THE VOLUME OF CUT, FILL, AND TOPSOIL. COMPARE AND COORDINATE WITH INFORMATION PROVIDED BY THE DESIGN ENGINEER. • GRADE TOLERANCES - ESTABLISHING DESIGN SUBGRADE ELEVATIONS TO WITHIN ONE TENTH OF ONE FOOT (0.10') IN PAVEMENT AREAS (INCLUDING WALKS) AND TO WITHIN THIRTY-THREE
  - HUNDREDTHS OF ONE FOOT (0.33') FOR ALL REMAINING AREAS.
  - COMPACTION ACHIEVING THE SPECIFIED MINIMUM COMPACTION VALUES FOR EMBANKMENT/FILL AREAS. THE TERMS "FILL" AND EMBANKMENT" ARE INTERCHANGEABLE
  - CUTS ONCE EXCAVATIONS ARE SHAPED TO THE DESIGN GRADES THE AREAS SHALL BE PROTECTED TO ASSURE THAT THE INTEGRITY OF MATERIAL IS NOT COMPROMISED BY CONSTRUCTION VEHICLES AND/OR IMPROPER DRAINAGE. AREAS DETERMINED BY CONTRACTOR TO BE NOT SUITABLE FOR SUBGRADE PLACEMENT SHALL BE IMMEDIATELY REPORTED WHEN THE SUBGRADE IS ESTABLISHED TO OWNER'S REPRESENTATIVE. STABILIZATION MEASURES FOR CUT AREAS MAY BE CONSIDERED BY OWNER'S REPRESENTATIVE AS A CHANGE TO THE BASE CONTRACT.
- 3. TESTING THE FOLLOWING MAXIMUM DRY DENSITIES SHALL BE ACHIEVED AS MEASURED BY THE MODIFIED PROCTOR METHOD ASTM D-1557:
- 95% UNDER PAVEMENTS, WALKS, AND IN STRUCTURAL FILL AREAS
- 85% IN REMAINING AREAS
- THE AGREEMENT BETWEEN THE OWNER AND CONTRACTOR SHALL DEFINE THE NUMBER OF TESTS AND RESPONSIBILITY. WE RECOMMEND IN EMBANKMENT AREAS ONE PER LIFT AND/OR ONE PER 1,000 CUBIC YARDS.
- 4. LIFT THICKNESS THE MAXIMUM LIFT THICKNESS UNDER PAVEMENTS, WALKS, AND STRUCTURAL FILLS SHALL BE 12 INCHES. HAND OPERATED COMPACTION FILLS SHALL NOT EXCEED 6 INCHES.
- 5. PROOF ROLLING THE OWNER'S REPRESENTATIVE MAY REQUEST A PROOF ROLL (I.E. LOADED TEN WHEELER) OF SUBGRADE AREAS PRIOR TO PLACEMENT OF SUBBASE MATERIALS. AREAS THAT "FAIL" SHALL BE REMOVED AND REPLACED TO ACHIEVE A PASSING SUBGRADE.

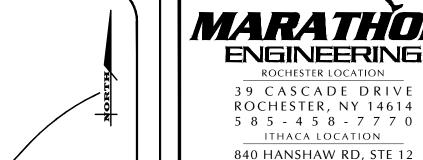



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1. COVER - WATER SERVICE LINES SHALL HAVE A MINIMUM OF 5 FEET OF COVER FROM FINISHED GRADE IN LAWN AREAS AND 6 FEET OF COVER FROM FINISHED GRADE IN PAVED AREAS.

### **HYDRANTS** - CLOW-EDDY OR MUELLER WITH:

- 5 FOOT BURY, OPEN LEFT, TRAFFIC TYPE GROUND FLANGE, 6 INCH INLET. • 1 - 41/2 INCH NST STEAMER NOZZLE, 2 - 21/2 INCH NST HOSE NOZZLE.
- MECHANICAL JOINT CONNECTIONS, 5 INCH HYDRANT VALVE SEAT, PENTAGON OPERATING NUT. • MUST HAVE TWO FORMS OF RESTRAINT, ONE OF WHICH MUST BE A THRUST BLOCK. SECOND RESTRAINT CAN BE - 1) INTEGRALLY CAST RESTRAINT, 2) ¼ INCH STAINLESS STEEL THREADED ROD AND FRICTION CLAMPS, 3) RETAINER
- 3. WATER MAIN CLASS 52 (GREATER THAN 350 PSI), DUCTILE IRON, CEMENT LINED, PUSH ON JOINT WITH 8 MIL POLY ENCASEMENT WRAP.
- 4. MAIN VALVES MECHANICAL JOINT, RESILIENT SEAT, GATE, 2 INCH OPERATING NUT, OPEN LEFT, STAINLESS STEEL BONNET
- 5. MAIN FITTINGS ALL UNDERGROUND FITTINGS ARE DUCTILE IRON, MECHANICAL JOINT (INCLUDING TAPPING SLEEVES, UNLESS APPROVED BY MUNICIPALITY). FITTINGS IN BUILDINGS OR PITS ARE TO BE DUCTILE IRON FLANGE JOINT.
- 7. SERVICE LINE FITTINGS MUELLER OR FORD, COMPRESSION OR FLARED FITTINGS. CURB VALVES AND CORPORATION STOPS MUST BE" BALL TYPE - FULL PORT". STOP AND WASTE VALVES ARE NOT PERMITTED.
- 8. SERVICE LINES "K" COPPER WITH ¾ INCH MINIMUM. 1 INCH MINIMUM WHERE SPRINKLER SYSTEMS ARE REQUIRED.
- 9. CURB BOXES BUFFALO STYLE, SCREW TYPE, CAST IRON, LID MARKED "WATER" WITH PENTAGON NUT, OPERATING ROD
- 10. RESTRAINT 2500 PSI, 30 DAY CONCRETE THRUST BLOCK PLUS ONE OF THE FOLLOWING -1) INTEGRALLY CAST RESTRAINT
- 2) ¾ INCH STAINLESS STEEL THREADED ROD AND FRICTION CLAMPS 3) RETAINER GLANDS
- 1. PRESSURE REDUCING VALVES O.C.V MODEL 127, BERMAD OR ROSS VALVE

### 12. **DEAD ENDS WITHOUT HYDRANTS**

- 2 INCH FLUSHING OR BLOW OFF HYDRANTS MUST BE INSTALLED. • 21/2 INCH NST NOZZLE, 2 INCH IRON PIPE INLET, TRAFFIC BREAK AWAY FLANGE AND FULL DRAINING CAPABILITIES.
- 13. **TESTING** WATER SERVICE LINES SIZED 4-INCHES OR GREATER SHALL BE: PRESSURE TESTED IN ACCORDANCE WITH THE LATEST SPECIFICATIONS OF THE SOUTHERN CAUGA LAKE
- INERMUNICIPAL WATER COMMISSION (SCLIWC). A SCLIWC AND A TOWN OF DRYDEN DEPARTMENT OF PUBLIC WORKS REPRESENTATIVE MUST WITNESS THIS TEST. • DISINFECTED BY USING THE CONTINUOUS FEED METHOD ACCORDING TO AWWA STANDARD SPECIFICATIONS. AFTER
- FLUSHING AND DISINFECTING THE SERVICE LINE, WATER SAMPLES SHALL BE COLLECTED BY THE SCLIWC. APPROVAL AND NOTIFICATION BY THE SCLIWC MUST BE RECEIVED BEFORE THE LATERAL IS PLACED IN SERVICE.

### UTILITIES

### 1. SANITARY

### 1.1 MATERIALS

- MAINS PIPING SHALL BE POLYVINYL CHLORIDE (PVC) WITH ENDS SUITABLE FOR ELASTOMERIC GASKET JOINTS, AND A MINIMUM WALL THICKNESS OF SDR-35. PIPING AND FITTINGS SHALL MEET:
- ASTM D-3034 (4" THRU 15")
- ASTM F-679 (18" THRU 48") • LATERALS - PIPING SHALL BE POLYVINYL CHLORIDE (PVC) WITH ENDS SUITABLE FOR ELASTOMERIC GASKET
- JOINTS, AND A MINIMUM WALL THICKNESS OF SDR-21. PIPING AND FITTINGS SHALL MEET ASTM D-2241. • JOINTING MATERIALS - SHALL BE BELL-AND-SPIGOT WITH INTEGRAL PUSH ON TYPE ELASTOMERIC GASKET
- JOINTS, GASKET MATERIAL TO BE NEOPRENE MEETING ASTM D-3212. • MANHOLES - SHALL BE PRECAST CONCRETE WITH NEOPRENE GASKETS MEETING ASTM C-478 & ASTM C-443.
- 1.2 INFILTRATION/ EXFILTRATION MAXIMUM ALLOWABLE INFILTRATION OR EXFILTRATION SHALL NOT EXCEED 100 GALLONS PER INCH DIAMETER PER MILE OF PIPE PER DAY FOR THE SANITARY SEWER. IF AN AIR TEST IS USED, THE TEST AS A MINIMUM SHALL CONFORM TO THE PROCEDURE DESCRIBED IN ASTM F1417 ENTITLED STANDARD PRACTICE FOR INSTALLATION ACCEPTANCE OF PLASTIC NON-PRESSURE SEWER LINES USING LOW-PRESSURE AIR. SANITARY MANHOLES SHALL BE VISUALLY INSPECTED AND TESTED FOR LEAKAGE BY EX FILTRATION OR VACUUM.
- VACUUM TESTING OF MANHOLES SHALL COMPLY WITH THE METHOD OUTLINED IN THE NEW YORK STATE DEPARTMENT OF ENVIRONMENTAL CONSERVATION TECHNICAL INFORMATION PAMPHLET (TIP) NO. 15 (REVISED). 1.3 FLOOR DRAINS - FLOOR DRAINS, IF CONSTRUCTED IN THE PROJECT. MUST BE CONNECTED TO THE SANITARY SEWER. NOTE: FLOOR DRAINS DO NOT INCLUDE FOUNDATION OR FOOTER DRAINS INSTALLED TO INTERCEPT UNCONTAMINATED GROUND WATER. ALL DISCHARGES FROM THE FLOOR DRAINS TO THE SANITARY SEWER MUST
- **1.4 TESTING** DEFLECTION TESTS SHALL BE PERFORMED ON ALL FLEXIBLE PIPE. THE TEST SHALL BE CONDUCTED AFTER THE FINAL BACKFILL HAS BEEN IN PLACE AT LEAST 30 DAYS. NO PIPE SHALL EXCEED A DEFLECTION OF 5%. IF THE DEFLECTION TEST IS TO BE RUN USING A RIGID BALL OR MANDREL. IT SHALL HAVE A DIAMETER EQUAL TO 95% OF THE INSIDE DIAMETER OF THE PIPE. THE TEST SHALL BE PERFORMED WITHOUT MECHANICAL PULLING DEVICES.
- 1.5 SEPARATION MINIMUM VERTICAL SEPARATION BETWEEN WATER MAINS AND SEWER LINES SHALL BE 18 INCHES MEASURED FROM THE OUTSIDE OF THE PIPES AT THE POINT OF CROSSING. ONE FULL STANDARD LAYING LENGTH OF WATER MAIN SHALL BE CENTERED UNDER OR OVER THE SEWER SO THAT BOTH JOINTS WILL BE AS FAR FROM THE SEWER AS POSSIBLE. IN ADDITION. WHEN THE WATER MAIN PASSES UNDER A SEWER, ADEQUATE STRUCTURAL SUPPORT (COMPACTED SELECTED FILL) SHALL BE PROVIDED FOR THE SEWER TO PREVENT EXCESSIVE DEFLECTION OF JOINTS AND SETTLING OF THE SEWER ON THE WATER MAIN. MINIMUM HORIZONTAL SEPARATION BETWEEN PARALLEL WATER MAINS AND SEWER PIPES (INCLUDING MANHOLES AND VAULTS) SHALL BE 10 FEET MEASURED FROM THE OUTSIDE OF THE PIPES. MANHOLES OR VAULTS.

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ROAD AND TOMPKINS (

INTERSECT OF DRYDEN

JOB NO: 1096-20 SCALE: 1"=30' DRAWN: **DESIGNED:** AMF DATE: 3/11/20 REVISIONS DATE BY REVISION 8/28/20 AMF RE SIONS PER PLANNING BOA COMMENTS 10/16/20 AMF REVISIONS PER PLANNING BOAR PERSON, UNLESS ACTING UNDER THE DIRECTION OF A LICENSFD PROFE ieer or land surveyor, to alter in any way, an item bearing the seal ssional engineer or land surveyor. If an item bearing the seal COPYRIGHT© 2020 MARATHON ENG.

ADAM M. FISHEL DRAWING TITLE: **Utility Plan** (1 of 2)

NOTFOR

CONSTRUCTION

STRUCTURE ID	STRUCTURE TYPE	TOP OF RIM	OUT	INVERT	LENGTH (FT)	PIPE DIA. & MAT'L	SLOPE (%
S-2.4 S-2.4 TO S-2.3	PROPOSED 4' DIA. MANHOLE	923.50	917.06	-	68	6" PVC.	0.75%
S-2.3 S-2.3 TO S-2.2	PROPOSED 4' DIA. MANHOLE	922.60	916.45	916.55	116	6" PVC.	0.75%
S-2.2 S-2.2 TO S-2.1	PROPOSED 4' DIA. MANHOLE	922.50	15.48	. 5.58	141	6" PVC.	0.75%
S-2.1 S-2.1 TO S-2	PROPOSED 4' DIA. MANHOLE	922.80	10 2	914.42	86	6" PVC.	0.75%
S-6 S-6 TO S-5	EXISTING SAN.MANHOLE	9 1 9	918	929.28	161	8" PVC. (EX)	0.65%
S-5A S-5A TO S-5	PROPOSED 4' DIA.  MANHOLE	9.5.90	129.76		93	6" PVC.	1.00%
S-5.1 S-5.1 TO S-5	EXISTING AV.  MAN DLE	93 90	929.02	-	100	8" PVC. (EX)	0.89%
S-5 S-5 TO S-4	PROPOSI 4' DI	936.30	928.03	928.13	67	8" PVC.	0.40%
S-4 S-4 TO S-3	MA HOL	938.90	927.66	927.76	198	8" PVC.	0.40%
S-3 S-3 TO S-2	PROPOS 0.4' L. A. MAN DLE	937.50	926.77	926.87	202	8" PVC.	6.50%
S-2 S-2 TO S-1	ROPOS D 4' DIA. M' HOLE	919.00	913.58	913.68	181	8" PVC.	7.50%
S-1 S-1 TO S	P) SED 4' DIA. MANHOLE	910.70	899.90	900.00	16	8" PVC.	7.50%
S	EXISTING SAN.	909.10	898.50	898.70	4	2	1

NOTES:

(1) INVERT ELEVATION OF EXISTING SANITARY SEWER SHOWN IS APPROXIMATE. CONTRACTOR TO CONFIRM PRIOR TO THE START OF WORK.

### DRAINAGE SCHEDULE (D)

STRUCTU	JRE DESIGN	IATIONS				
	FROM	то	DIA. (IN)	PIPE MAT'L	LENGTH (FT)	SLOPE (%)
INMH	D-4	D-3				
TG=	935.50					
INV=	930.89	929.89	18	HDPE	50	2.00%
MH4	D-3	D-2				
TR=	936.75					
INV=	929.89	927.21	18	HDPE	134	2.00%
MH6 DROP	D-2	D-1				
TR=	935.50					
INV=	919.21	912.89	18	HDPE	79	8.00%
24x24 CB	D-1.3	D-1.2				
TG=	919.90					
INV=	915.96	915.53	12	HDPE	43	1.00%
24x24 CB	D-1.2	D-1.1				
TG=	920.50					
INV=	915.53	914.12	12	HDPE	141	1.00%
INMH	D-1.1C	D-1.1B				
TG=	920.50					
INV=	915.06	914.75	12	HDPE	42	0.75%
INMH	D-1.1B	D-1.1A				
TG=	920.50					
INV=	914.75	914.43	12	HDPE	42	0.75%
INMH	D-1.1A	D-1.1				
TG=	920.50					
INV=	914.43	914.12	15	HDPE	41	0.76%
MH4	D-1.1	D-1	7.77			
TR=	923.50					
INV=	914.12	912.89	18	HDPE	124	1.00%
MH-4	D-1	D				
TR=	922.70					
INV=	912.89	910.00	18	HDPE	38	7.60%
ES	D					
INV=	910.00					

### **DRAINAGE SCHEDULE (DA)**

	FROM	TO	DIA. (IN)	PIPE MAT'L	LENGTH (FT)	SLOPE (%)
36x36CB	DA-5	DA-4				
TG=	938.70					
INV=	934.27	933.28	12	HDPE	100	1.00%
36x36CB	DA-4	DA-3				
TG=	938.50					
INV=	933.28	932.06	18	HDPE	122	1.00%
36x36CB	DA-3	DA-2				
TG=	938.00					
INV=	932.06	931.24	18	HDPE	82	1.00%
EX. CB	DA-2.1	DA-2				
TG=	938.30					
INV=	935.60	932.05	24	HDPE	44	8.00%
INMH4	DA-2	DA-1				
TG=	938.00					
INV=	928.24	917.00	24	HDPE	140	8.00%
36x36CB	DA-1.1	DA-1				
TG=	920.80					
INV=	917.12	917.00	18	HDPE	16	0.75%
MH4	DA-1	DA				
TR=	921.50					
INV=	916.50	914.40	30	HDPE	355	1.00%
ES	DA					

### **DRAINAGE SCHEDULE (DB)**

	FROM	TO	DIA. (IN)	PIPE MAT'L	LENGTH (FT)	SLOPE (%)
36x36CB	DB-3	DB-2				
TG=	936.65					
INV=	930.78	926.94	15	HDPE	96	4.00%
36x36CB	DB-2	DB-1				
TG=	935.00					
INV=	926.94	925.22	18	HDPE	43	4.00%
MH4	DB-1	DB				
TR=	934.00					
INV=	925.22	921.50	24	HDPE	93	4.00%
ES	DB					
INV=	921.50					

### **DRAINAGE SCHEDULE (DC)**

STRUCT	URE DESIGN	AHONS				
	FROM	TO	DIA. (IN)	PIPE MAT'L	LENGTH (FT)	SLOPE (%)
36x36 CB	DC-1	DC				
TG=	921.50					
INV=	911.50	907.00	24	HDPE	75	6.00%
ES	DC					
INV=	907.00					

### DRAINAGE SCHEDULE (DD)

	FROM	TO	DIA. (IN)	PIPE MAT'L	LENGTH (FT)	SLOPE (%)
OS1	DD-1	DD				
TR=	910.00					
INV=	906.01	905.00	12	HDPE	42	2.40%
ES	DD-1					
INV=	905.00					

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DEVELOPMENT

DE

JOB NO: 1096-20

SCALE: 1"=30'

DRAWN: AMF

DESIGNED: AMF

DATE: 3/11/20

REVISIONS

DATE BY REVISION

DATE BY REVISION

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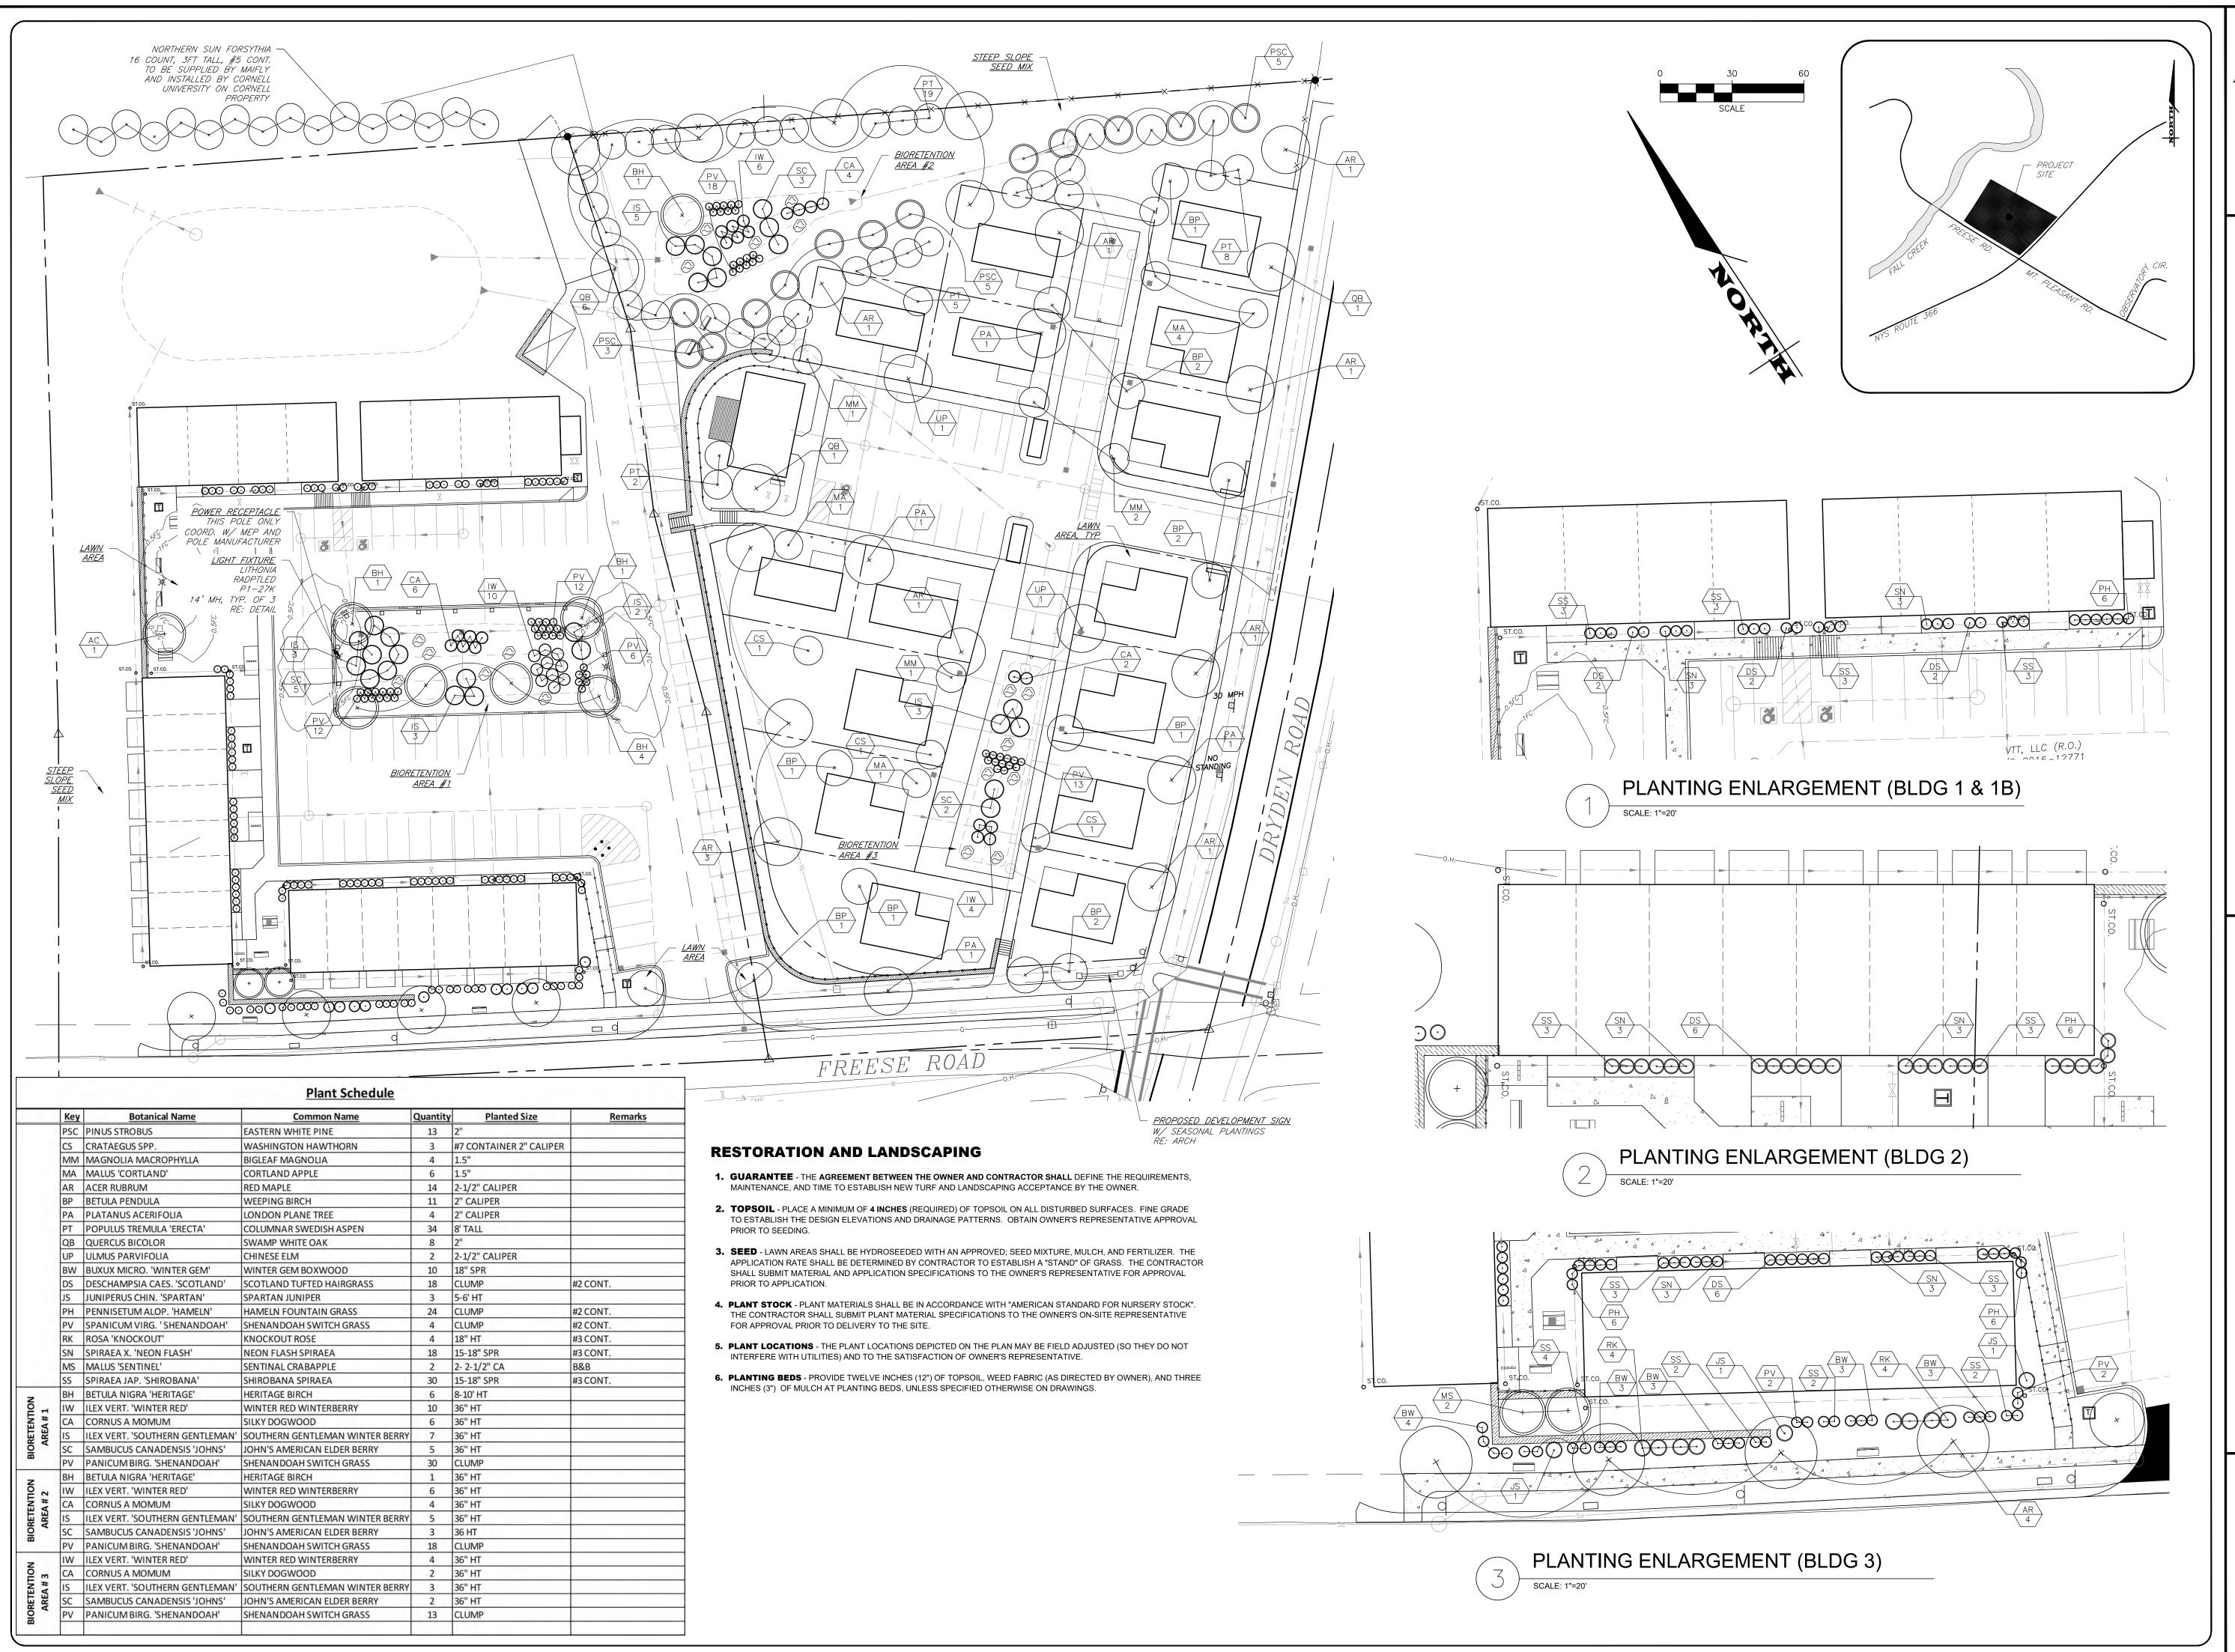
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INTERSECT OF DRYDEN

SITE DEVELOPMENT PLANS

AIFLY DEVELOPMENT

AIFLY DEVELOPMENT

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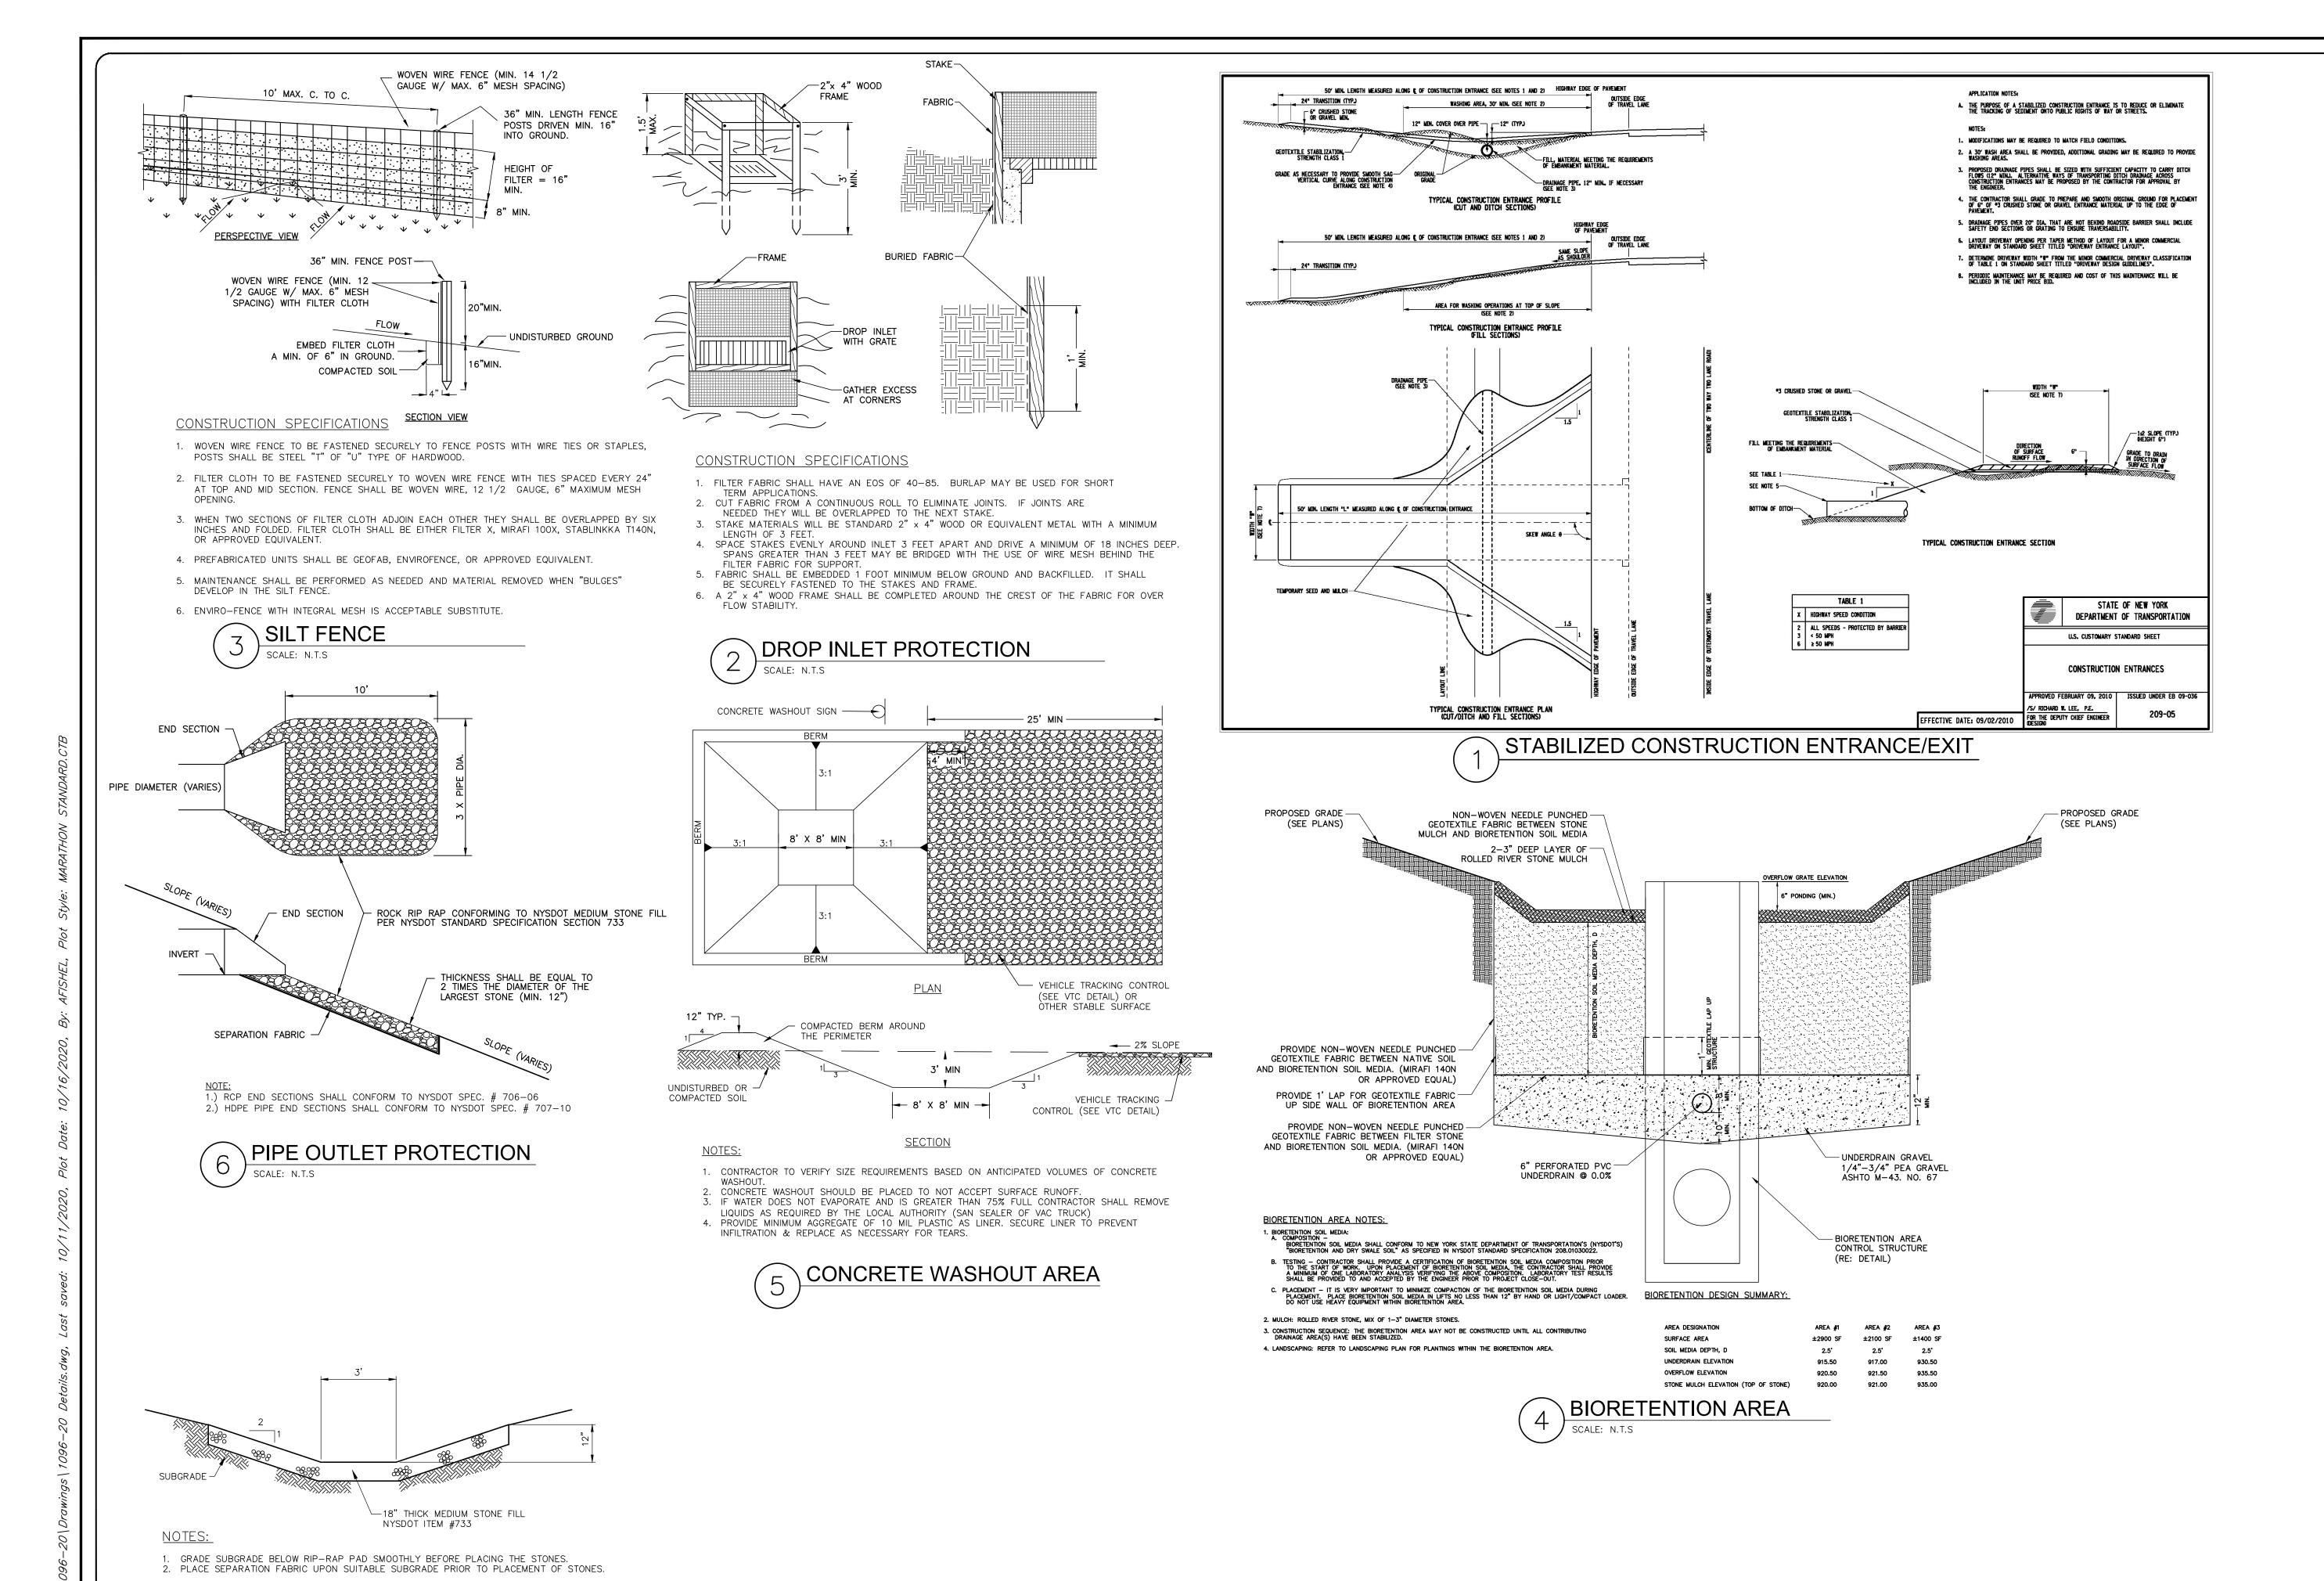
DRAWING TITLE:
Lighting &
Landscaping Plan

CONSTRUCTION

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STONE OUTLET PROTECTION

**ENGINEERING** ROCHESTER LOCATION

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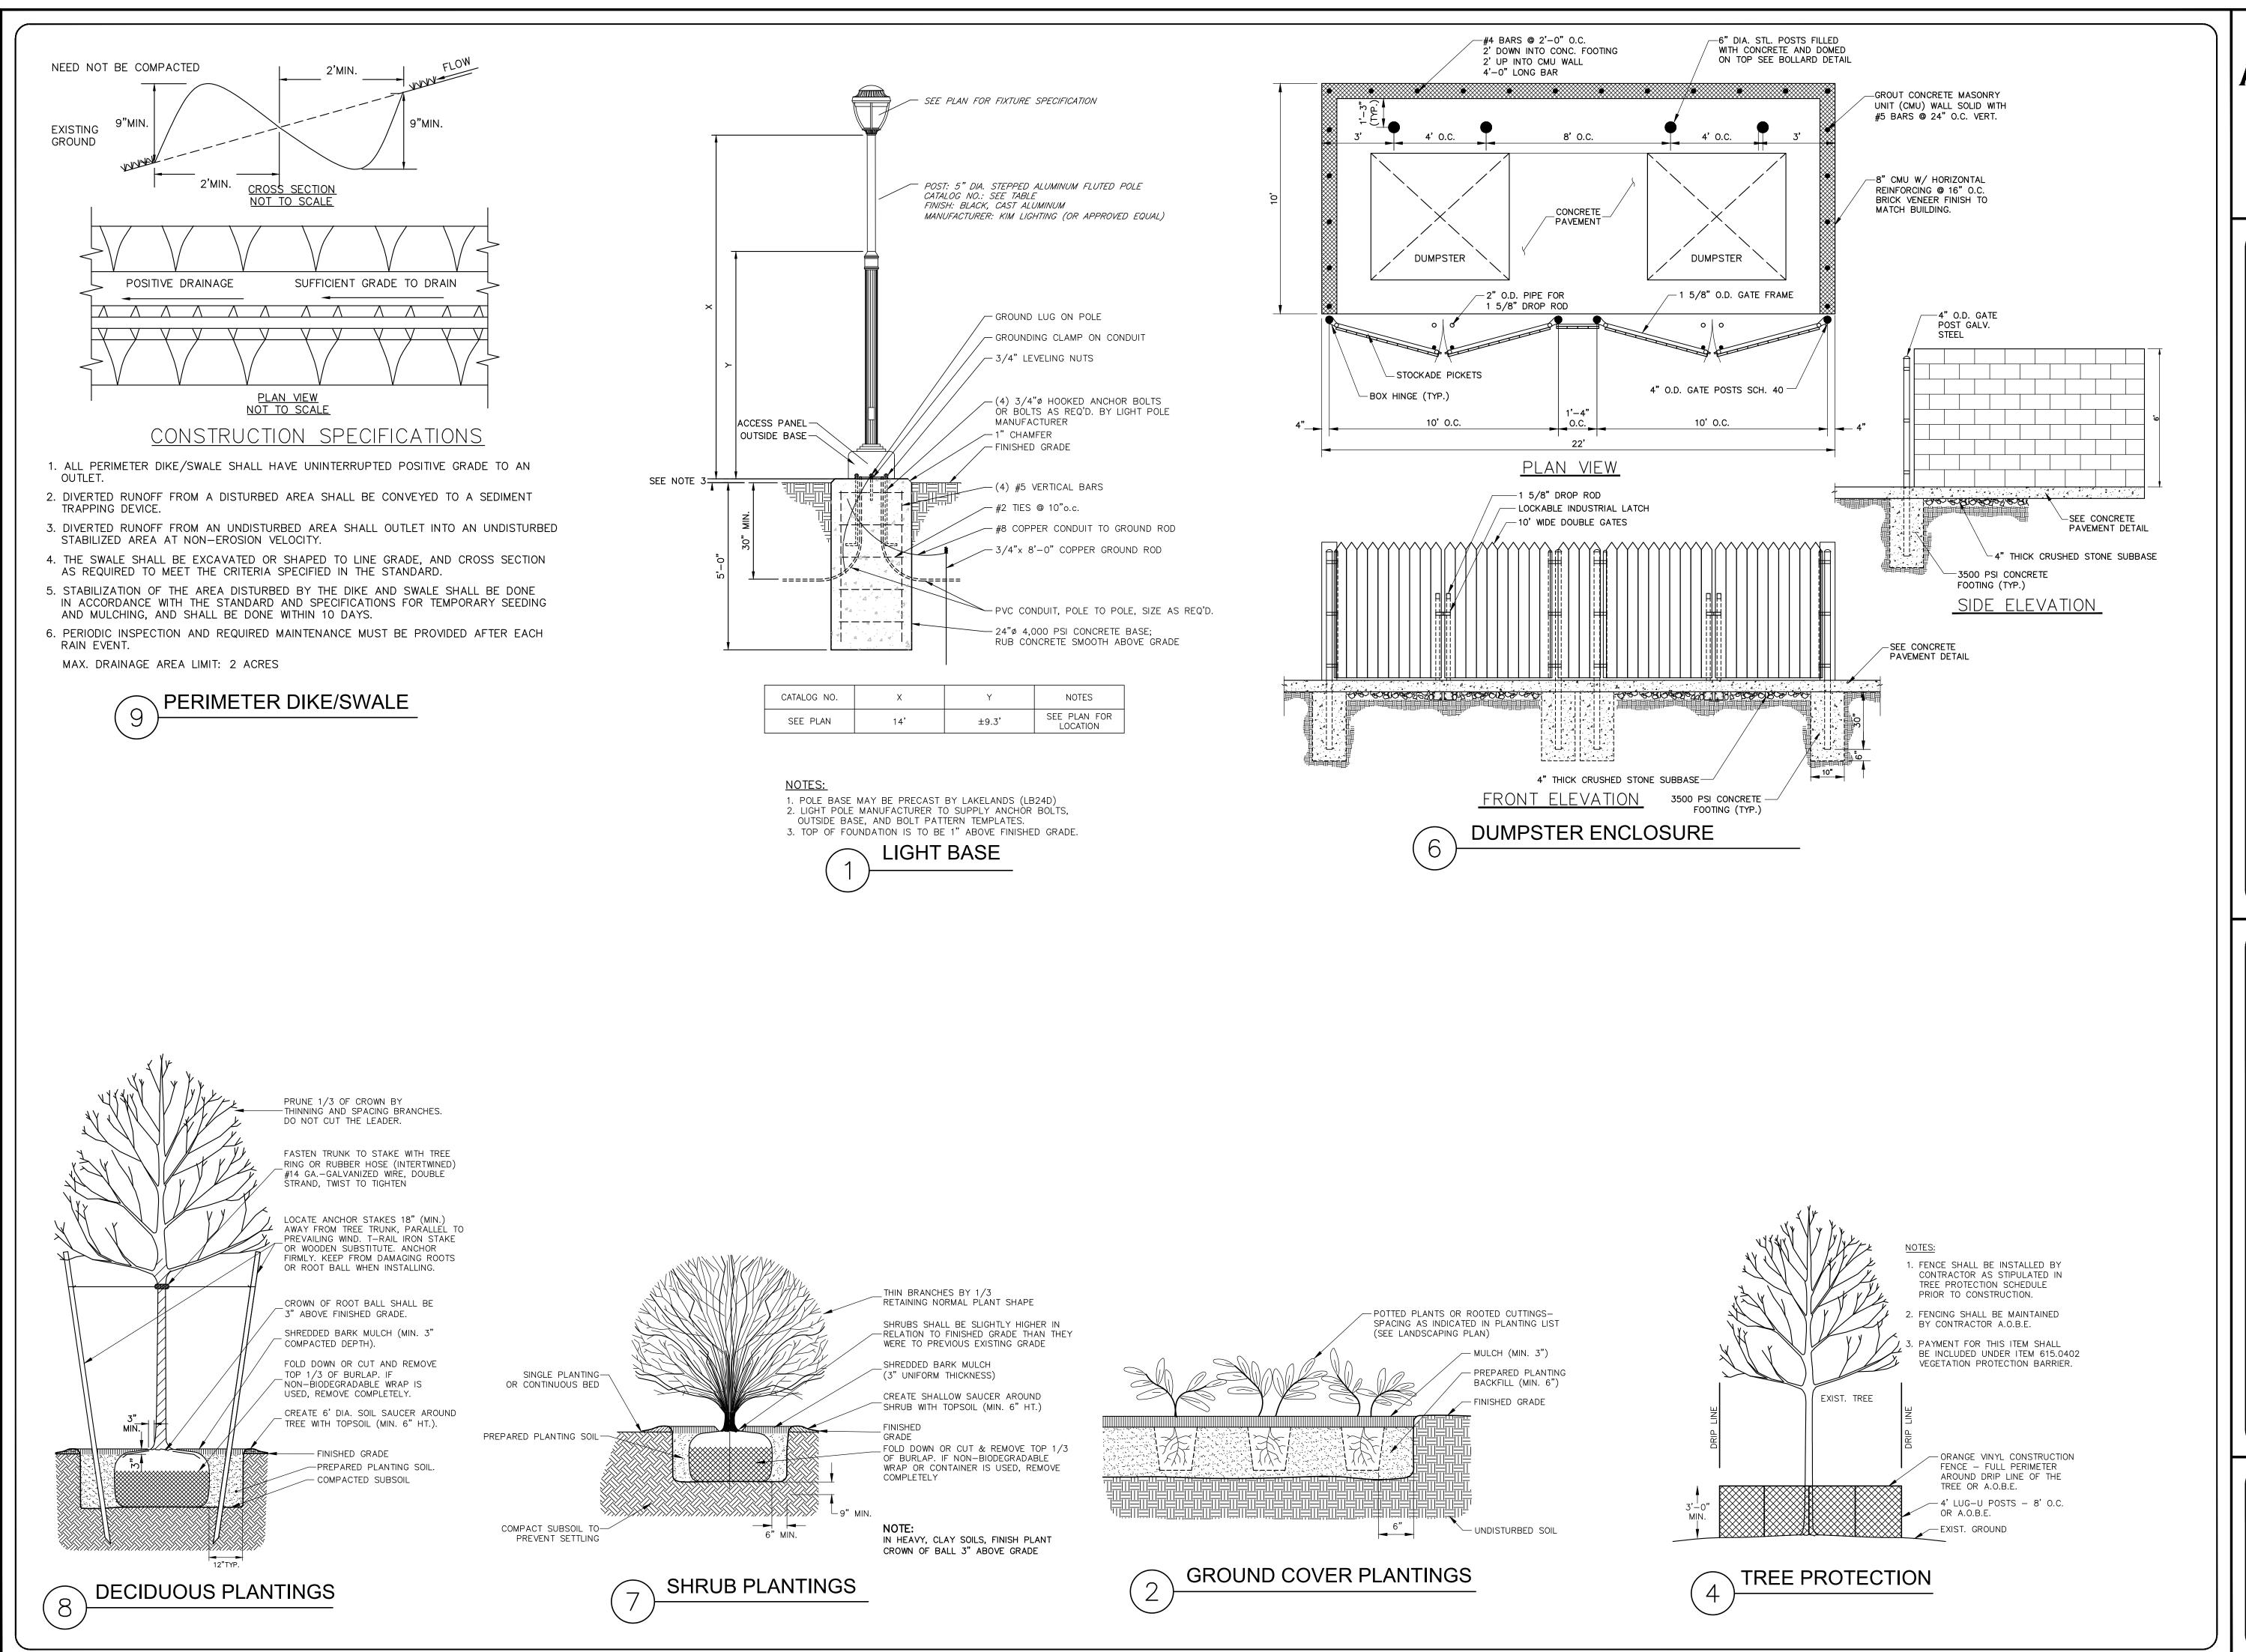
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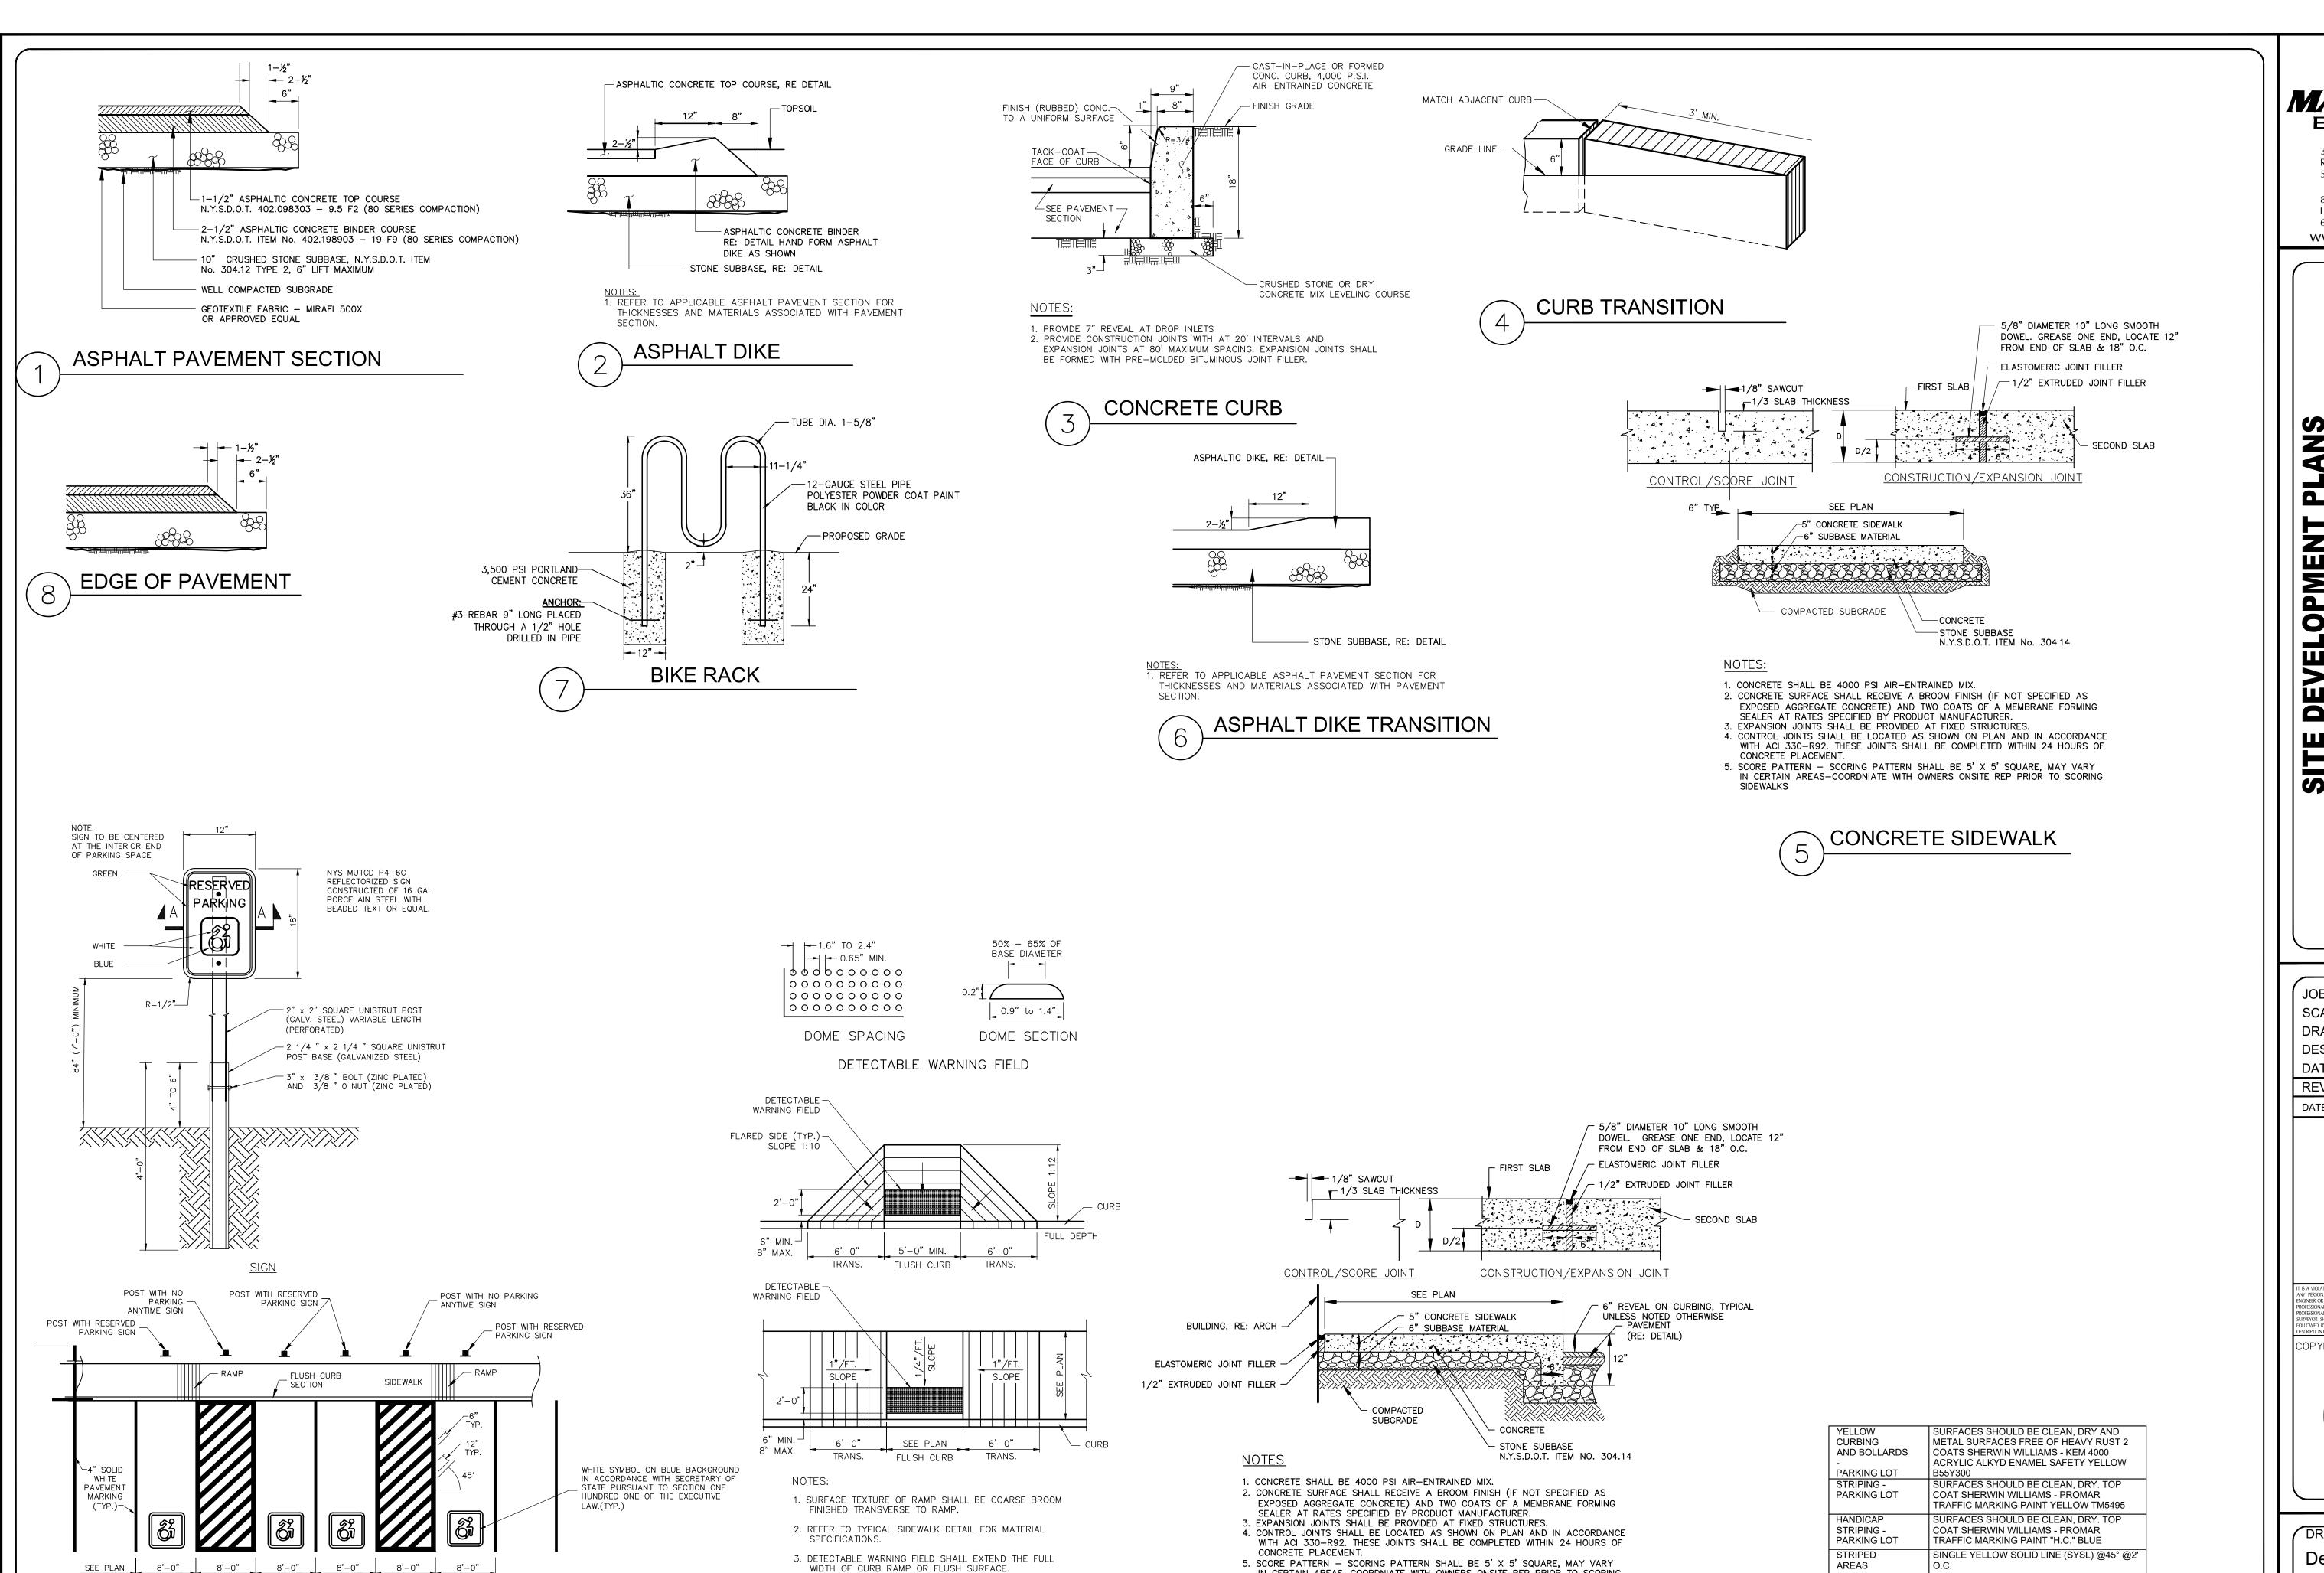
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4. DETECTABLE WARNING FIELD SHALL BE "CHARCOAL" IN

**ACCESS RAMP** 

COLOR, UNLESS OTHERWISE SPECIFIED IN THE

CONTRACT DOCUMENTS, OR AOBE.

TYP. FOR RESERVED PARKING STALLS

RESERVED PARKING AND SIGNAGE

<u>Parking</u>

IN CERTAIN AREAS-COORDNIATE WITH OWNERS ONSITE REP PRIOR TO SCORING

INTEGRAL CURBING

RAISED CONCRETE SIDEWALK WITH

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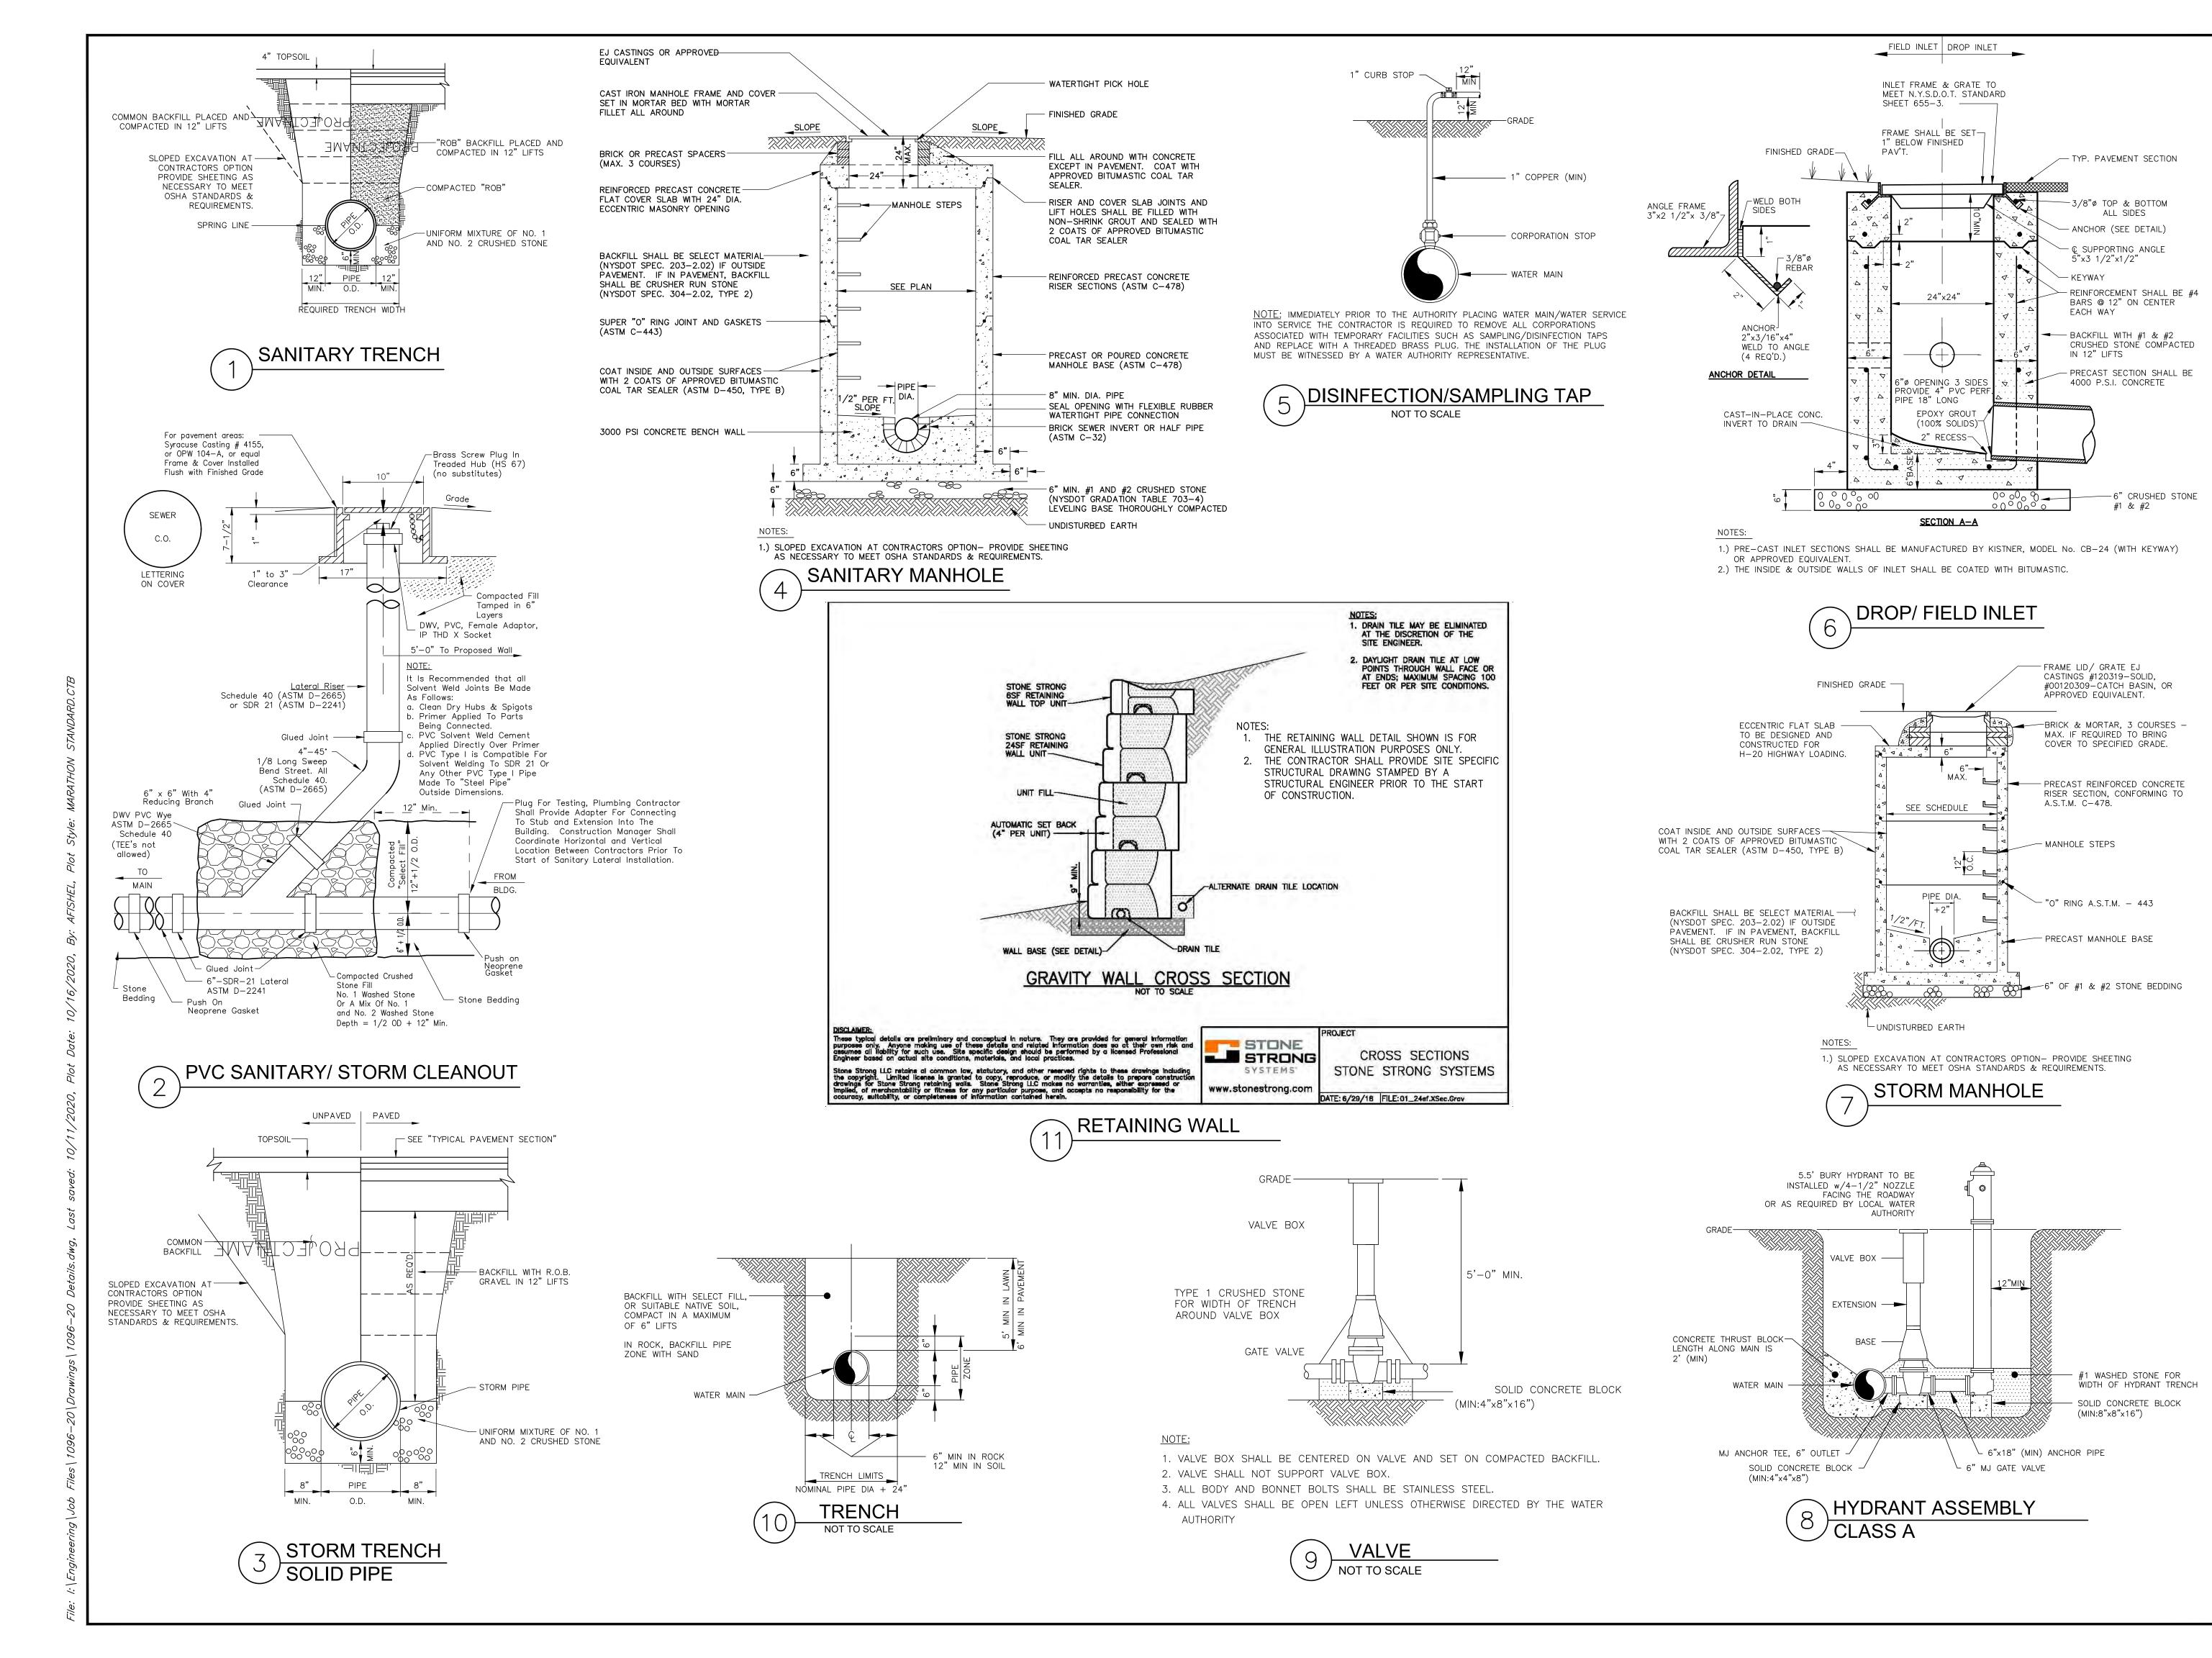
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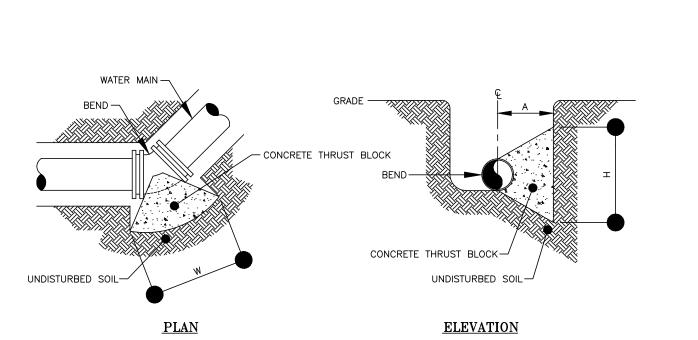
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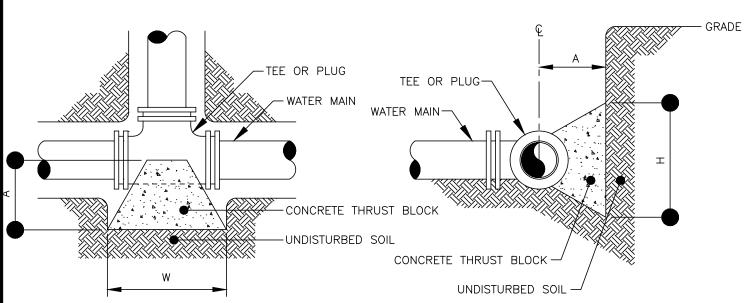
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## HORIZONTAL THRUST BLOCK FOR BENDS




## HORIZONTAL THRUST BLOCK TEES AND PLUGS

<u>PLAN</u>

**ELEVATION** 


MINIMUM HORIZONTAL THRUST BLOCK DIMENSIONS, IN FEET, TO BE POURED AGAINST UNDISTURBED SOIL				
FITTING *	Н	W	Α	
6" x 11-1/4° BEND	2.0	1.0	2.0	
6" x 22-1/2° BEND	2.0	1.0	2.0	
6" x 45° BEND	2.0	1.0	2.0	
6" x 90° BEND	2.0	1.3	2.4	
6" TEE OR PLUG	2.0	1.0	2.0	

NOTE: WIDTH (W) OF BLOCK SHALL NOT EXCEED TWICE THE HEIGHT (H).

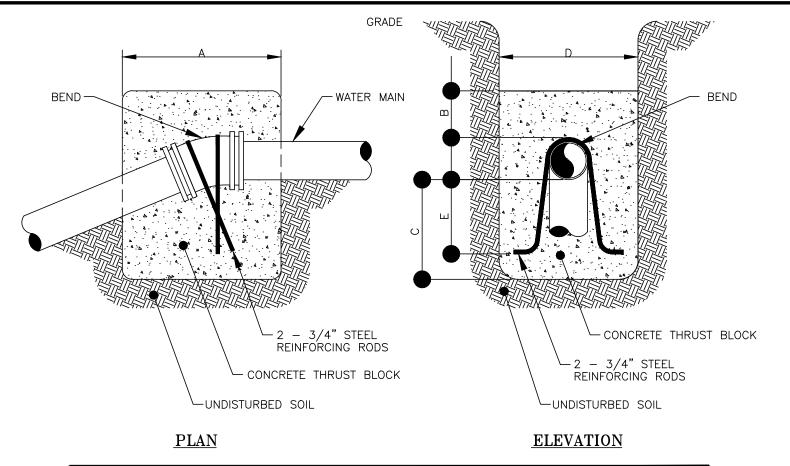

BEND *	MINIMUM VOLUME OF CONCRETE		IUM ALLO' FICAL THR			
	DIMENSIONS	Α	В	С	D	Е
6" x 11-1/4°	1.00 CY	3.0	1.0	1.3	3.0	1.0
6" x 22-1/2°	1.50 CY	4.0	1.0	1.8	3.0	1.5
6" x 45°	2.50 CY	6.0	1.5	2.0	3.0	1.7

VERTICAL THRUST BLOCK

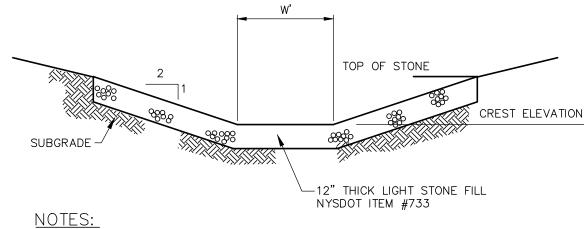

DETENTION POND #1

- 1. GRADE SUBGRADE BELOW RIP-RAP PAD SMOOTHLY BEFORE PLACING THE STONES. 2. PLACE SEPARATION FABRIC UPON SUITABLE SUBGRADE PRIOR TO PLACEMENT OF STONES.
- 3. ALL STONES TO BE SPACED 1"-3" APART AND PLACED BY HAND. 4. RIP-RAP SHALL BE GROUTED WITH LEAN GROUT SUCH THAT NO CAVITY OR VOID SHALL EXIST UNDER THE STONES


±910.00

±912.0

5. EXTEND GROUTED SPILLWAY DOWN THE INSIDE AND OUTSIDE OF THE POND. 4. CREST ELEVATION NOTED IN THIS DETAIL SHALL BE TOP OF STONE

8.0 FT

SPILLWAY ID CREST ELEVATION TOP OF STONE <u>WIDTH. W</u>

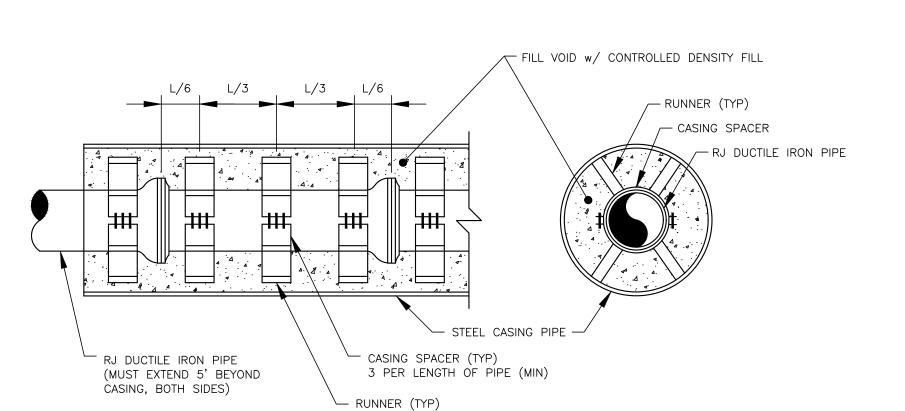

	CARRIER PIPE	CASING PIPE
CONTENTS	POTABLE WATER	N/A
NOMINAL PIPE SIZE	6"	12"
MATERIAL	DUCTILE IRON PIPE (DIP)	STEEL
SPECIFICATION	PER SPECIFICATIONS	ASTM A-139
GRADE OR CLASS	PER SPECIFICATIONS	(SEE NOTE 2)
JOINT	RESTRAINED JOINT (RJ)	WELDED
COATING	PER SPECIFICATIONS	COAL TAR EPOXY
METHOD OF INSTALLATION	SEE CASING DETAIL	JACK & BORE
CASING ENDS	N/A	AS DETAILED
SUPPORT SPACING	½ LENGTH	N/A

- 1.) EXTEND RJ PIPE 5' (MIN) BEYOND END OF CASING PIPE, BOTH SIDES. RESTRAINED JOINTS WITHIN CASING SHALL BE FIELD LOK 350 GASKETS OR APPROVED EQUAL. 2.) STEEL CASING PIPE SHALL BE CONTINUOUSLY WELDED STEEL PIPE PER
- THICKNESS OF % INCH. 3.) CONTROLLED DENSITY FILL (CDF) SHALL BE K-KRETE (OR APPROVED EQUAL) WITH A COMPRESSIVE STRENGTH OF 50 TO 100 PSI. FLY ASH OR OTHER POZZOLAN-CONTAINING MATERIALS ARE NOT ACCEPTABLE IN THE MIX DESIGN. THE CONSISTENCY SHALL BE SUITABLE FOR PUMPING OR FLOWING INTO THE ANNULAR SPACE BETWEEN A CASING PIE AND CARRIER PIPE. FILL INTO CASING SPACE FROM ONE END OF CASING. PUMP UNTIL CDF IS EVIDENT AT OTHER END OF CASING AND ALL VOIDS ARE FILLED.

A MINIMUM TENSILE STRENGTH OF 60,000 PSI, AND A MINIMUM WALL


ASTM A-139 GRADE B WITH A MINIMUM YIELD STRENGTH OF 36,000 PSI,

4.) CONTRACTOR SHALL CONTACT ENGINEER IF AN ALTERNATE CASING PIPE SIZING IS REQUIRED BASED ON RUNNER SIZE AND SPECIFIED CLEARANCES.

- **CASING RUNNER NOTES:** 1.) CASING RUNNERS SHALL BE FURNISHED, ASSEMBLED, AND INSTALLED BY THE CONTRACTOR DURING INSTALLATION OF THE WATER SERVICE IN THE
- CASING SLEEVE. 2.) CASING RUNNER BANDS AND ASSEMBLY HARDWARE SHALL BE STAINLESS STEEL. BANDS SHALL BE A MINIMUM OF 14 GAUGE 304 STAINLESS STEEL STEEL RISER SHALL BE HIGH GRADE 304 STAINLESS STEEL. MINIMUM 10 GAUGE THICKNESS AND SHALL BE FABRICATED TO SUPPORT THE CARRIER PIPE AND ITS LIQUID LOAD.
- 3.) CASING SPACERS SHALL HAVE AMPLE RISER HEIGHT TO LIMIT VERTICAL MOVEMENT OF THE CARRIER PIPE WITHIN THE CASING PIPE. CASING PIPE SHALL BE AS NOTED ON THIS PLAN OR SIZED SUCH THAT 1 INCH MINIMUM CLEARANCE SHALL BE PROVIDED BETWEEN THE TOP RUNNER AND THE INSIDE DIAMETER OF THE CASING PIPE.
- 4.) RUNNERS SHALL BE A HIGH-PRESSURE MOLDED GLASS REINFORCED POLYMER WITH A MINIMUM COMPRESSIVE STRENGTH OF 18,000 PSI, 2 INCHES IN WIDTH AND A MINIMUM OF 8 INCHES LONG, OR AS APPROVED BY THE AUTHORITY HAVING JURISDICTION. 5.) THE RUNNER SHALL BE ATTACHED TO THE BAND OR RISER BY % INCH

WELDED STAINLESS STEEL STUDS AND LOCK NUTS, WHICH SHALL BE

RECESSED ADEQUATELY BELOW THE WEARING SURFACE ON THE RUNNER. 6.) THE BAND SECTION SHALL BE BOLTED TOGETHER WITH 304 STAINLESS STEEL STUD, NUTS AND WASHERS. HARDWARE SHALL BE 3/6 INCH. 7.) A MINIMUM OF 3 CASING RUNNERS SHALL BE PROVIDED FOR EACH LENGTH OF CARRIER PIPE PLACED WITHIN THE CASING PIPE. SPACING SHALL NOT BE GREATER THAN 5 FEET.

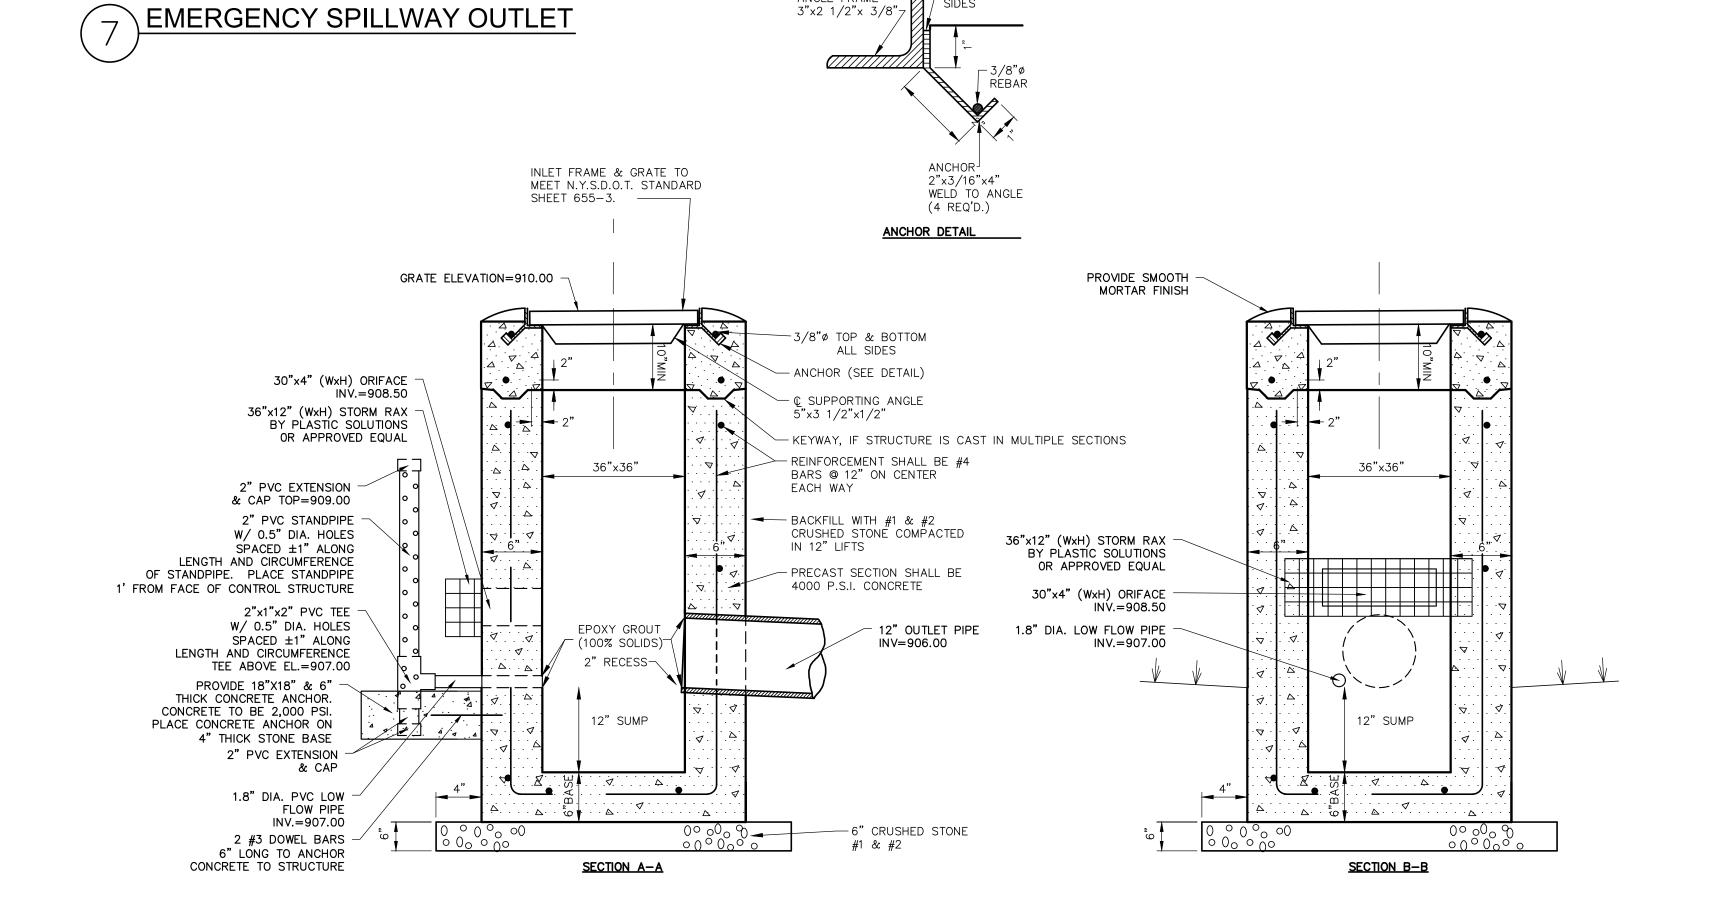

FLOW

1.) PRE-CAST INLET SECTIONS SHALL BE MANUFACTURED BY KISTNER, MODEL No. CB-24 (WITH KEYWAY) OR APPROVED EQUIVALENT. 2.) THE INSIDE & OUTSIDE WALLS OF INLET SHALL BE COATED WITH BITUMASTIC. CONTROL STRUCTURE #1 (OS#1)

*MARATHON* **ENGINEERING** ROCHESTER LOCATION 39 CASCADE DRIVE

6" THICK LAYER OF PEA GRAVEL. REMOVE SEDIMENT AND/OR REMOVE AND REPLACE WITH FRESH PEA GRAVEL AS

1. MAX HEIGHT OF STONE FILTER SHALL NOT EXCEED 18" OR AN ELEVATION

TEMPORARY STONE FILTER

EQUAL TO 6" LOWER THAN THE ELEVATION OF THE RESPECTIVE POND'S EMERGENCY SPILLWAY.

NECESSARY.

ROCHESTER, NY 14614 5 8 5 - 4 5 8 - 7 7 7 0 ITHACA LOCATION

UNIFORM MIX OF

SIZE 1 & 2 STONE

- MEDIUM STONE FILL

WRAPPED AROUND

- FILTER FABRIC

STONE

840 HANSHAW RD, STE 12 ITHACA, NY 14850 6 0 7 - 2 4 1 - 2 9 1 7 www.marathoneng.com

Z W Z  $\mathbf{\Sigma}$ 0 INTERSECT OF DRYDEN


1096-20 JOB NO: SCALE: DRAWN: AXA DESIGNED: AMF DATE: 07/30/20 REVISIONS DATE BY REVISION COPYRIGHT<sup>©</sup> 202<u>0</u> MARATHON ENG ADAM M. FISHEL


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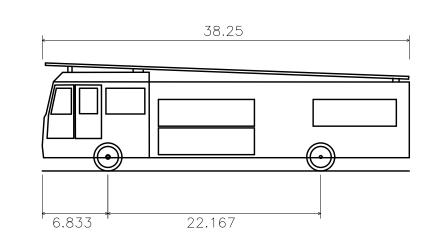
DRAWING No:

1096-20

WATER SERVICE CASING



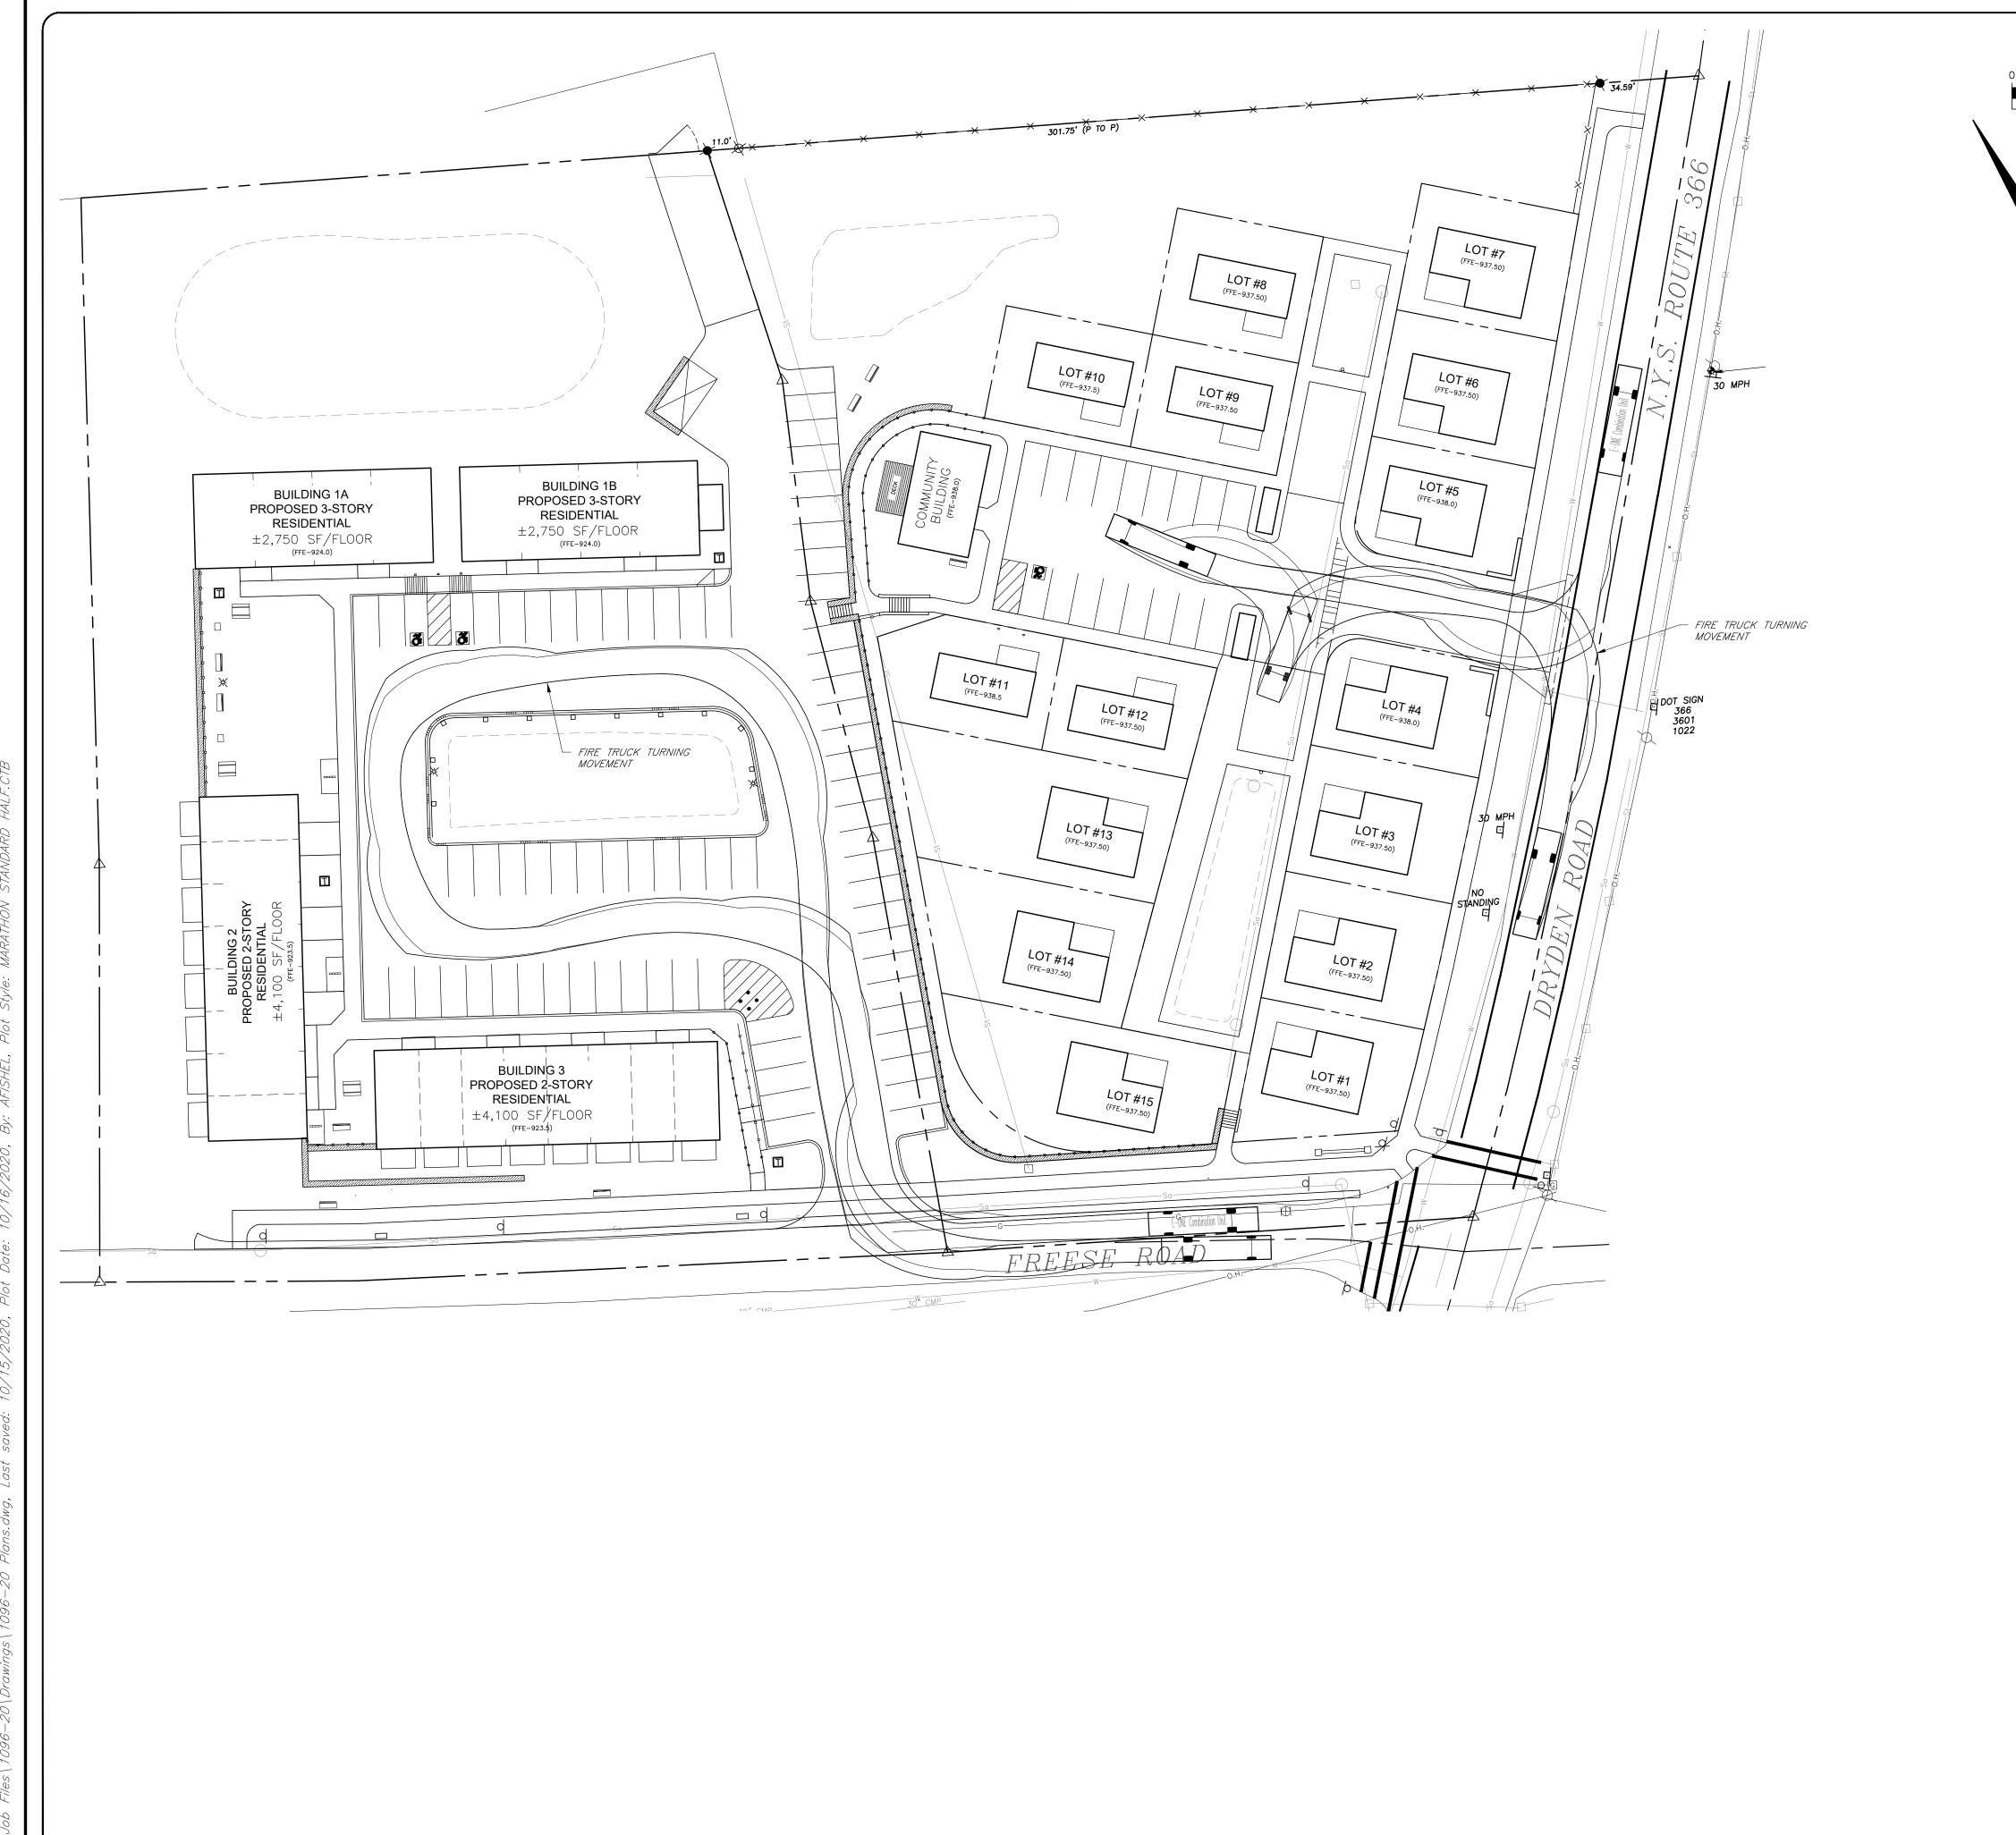

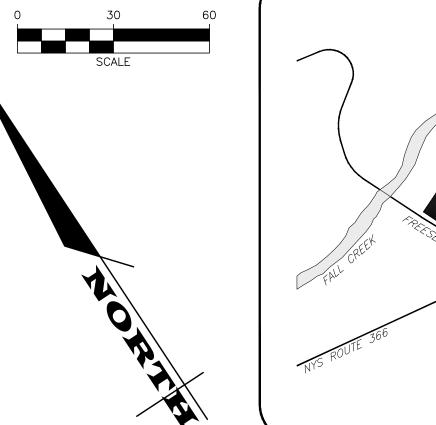

Fire Truck Overall Length
Overall Width
Overall Body Height
Min Body Ground Clearance
Track Width
Lock—to—lock time
Max Wheel Angle

PROJECT SITE





3 9 CASCADE DRIVE ROCHESTER, NY 14614 5 8 5 - 4 5 8 - 7 7 7 0 ITHACA LOCATION 840 HANSHAW RD, STE 12 ITHACA, NY 14850 6 0 7 - 2 4 1 - 2 9 1 7

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