

August 31, 2023

Town of Dryden 93 East Main Street Dryden, NY 13053

Attn: Ray Burger - Director of Planning

Re: Town Board Submittal – Planned Unit Development (PUD) Amendment

Evergreen Apartments

1061 Dryden Road (Tax ID: 55.-1-16)

Dryden, NY

Dear Ray,

On behalf of our client, Park Grove Realty, we are pleased to submit this letter and enclosed information to initiate the Town Board's review of the requested amendment to the previously approved Planned Unit Development (PUD) for this project.

As you know, the PUD was originally approved by the Town Board on May 30th, 2017 and subsequently received approval for an amendment on May 19, 2022. Since the project was last amended, the project and parcel have been acquired by Park Grove Realty. Under this design, the Project team obtained construction pricing and determined the site and buildings were infeasible of being built given the current construction climate. As a result, Park Grove Realty determined that it did not make sense to proceed with the project as proposed in the previously amended PUD.

Over the last few months, the project team has worked to refine the site and building drawing package for issuance to bidding contractors with the intent to start construction this fall. They have invested a significant amount of resources to create a design that was feasible of being built and improved living experience for individuals and families.

Park Grove Realty is proposing an alternative development plan consisting of four (4), ten (10) unit apartment buildings and one ranch style tri-plex townhome building. The resulting development produces a net reduction in the total number of beds versus that provided in the amended PUD, more dedicated recreational space, less impervious cover which increases overall greenspace as well as an increase in the number of parking spaces. The ten unit apartment buildings have a number of improved amenities, including open floor plans, private entry ways, and patios and decks for families. The revised layout also maintains pedestrian connectivity to the Dryden Rail Trail and Dryden Road as well as visual buffering with screen fencing and existing vegetation.

The ten-unit apartment building is one that Park Grove Realty is familiar with constructing locally and in the Rochester, NY market. A local example can be seen at Park Grove Realty's East Pointe Apartments located on Bomax Drive in Lansing. Park Grove Realty considers the building's interior and exterior materials and finishes included in these updated drawings as an improvement from that originally included in the amended PUD. The finishes proposed at 1061 Dryden will be high-end market rate finishes.

The project team has experience with the tri-plex as well. While the information enclosed, represents a single unit, the architect is able to configure the same unit footprint into the overall tri-plex layout illustrated on the enclosed

Town Board Submittal Evergreen Apartments 1061 Dryden Road

Site Plan. We will provide colored elevations of the tri-plex unit for discussion at the meeting noted below but the intent is to match the interior and exterior materiality as the 10-plex apartment units.

By incorporating these changes, the development team considers the revised project an overall improvement from that originally approved. A side-by-side comparison of the key features between the two projects is as follows:

Design Features	Original Design	Revised Design
Impervious Surface	±2.4 acres	±2.0 acres
Number of Bedrooms	90	82 bedrooms
Dedicated Recreational Space	±5,700 SF	±12,000 SF
Garage Parking	7 per building, 42 total	11 per building, 3 at townhomes
		for a total of 47
Site Parking	95 total (11 onsite & 84 in	108 total (14 onsite, 88 in
	driveway)	apartment driveways/garages & 6
		in townhome driveway/garages)
Snow Storage	Minimal	Increased opportunities for snow
		storage
Stormwater	Not as centralized	Centralized Stormwater Design
Sprinklers	No	Yes
Accessible Units	No	First floor units could be accessible
Patios and Balconies	Yes	Yes, with increased privacy
1 bedroom units	No	Yes
Bathrooms in 2 bedroom units	1	2
Green Energy Certified	No	Yes, HUD

Our team recently met with the Town Planning Board on August 24, 2023 to solicit feedback on these proposed changes. While the Planning Board did pass a resolution expressing support for the revised changes, one item in particular they asked us to review was the separation of two nearest buildings to the eastern property line. It should be noted that the Site Plan included in the original PUD approval had the nearest building situated approximately 15' from the eastern property line. The Site Plan reflected in the previous amendment to the PUD provided a smaller building which expanded that setback to approximately 30'. The Site Plan currently proposed has the nearest building approximately 21' from the eastern property line which is further than that provided in the original PUD approval.

It is Park Grove Realty's opinion that these revisions produce a significant improvement from the previous design by providing a number of benefits, including less impactful site design, more greenspace, higher-end buildings with greater amenities to residents, greater accessibility, and green building features. In addition, Park Grove believes this design is much more financially feasible than the previous design, and is hopeful to begin construction this fall. As such, we respectfully request the Town Board's approval of the requested amendment to PUD associated with this project.

So the Town of Dryden may consider the enclosed PUD amendment request, we are providing the following:


- This Letter 10 copies
- Site Plans (2 sheets), Full Size 1 set
- Site Plans (2 sheets), Reduced Size 10 sets
- 10 Unit Apartment Building Floor Plans and Elevations, Full Size 1 set
- 10 Unit Apartment Building Floor Plans and Elevations, Reduced Site 10 sets
- Tri-Plex Floor Plan and Elevation, Full Size 1 set
- Tri-Plex Floor Plan and Elevation, Reduced Size 10 sets
- 10 Unit Apartment Building Front Elevation Color Rendering, 11x17 10 copies
- 10 Unit Apartment Building Rear Elevation Representative Photographs 10 copies

We respectfully request that this project be placed on the September 14th, 2023, Town Board agenda where we will discuss the specifics surrounding the requested PUD amendment discussed above. Please do not hesitate to contact our office if you have any questions or need additional information.

Respectfully submitted,

Adam M. Fishel, PE Marathon Engineering

CC - Tim Crilly - Park Grove Realty

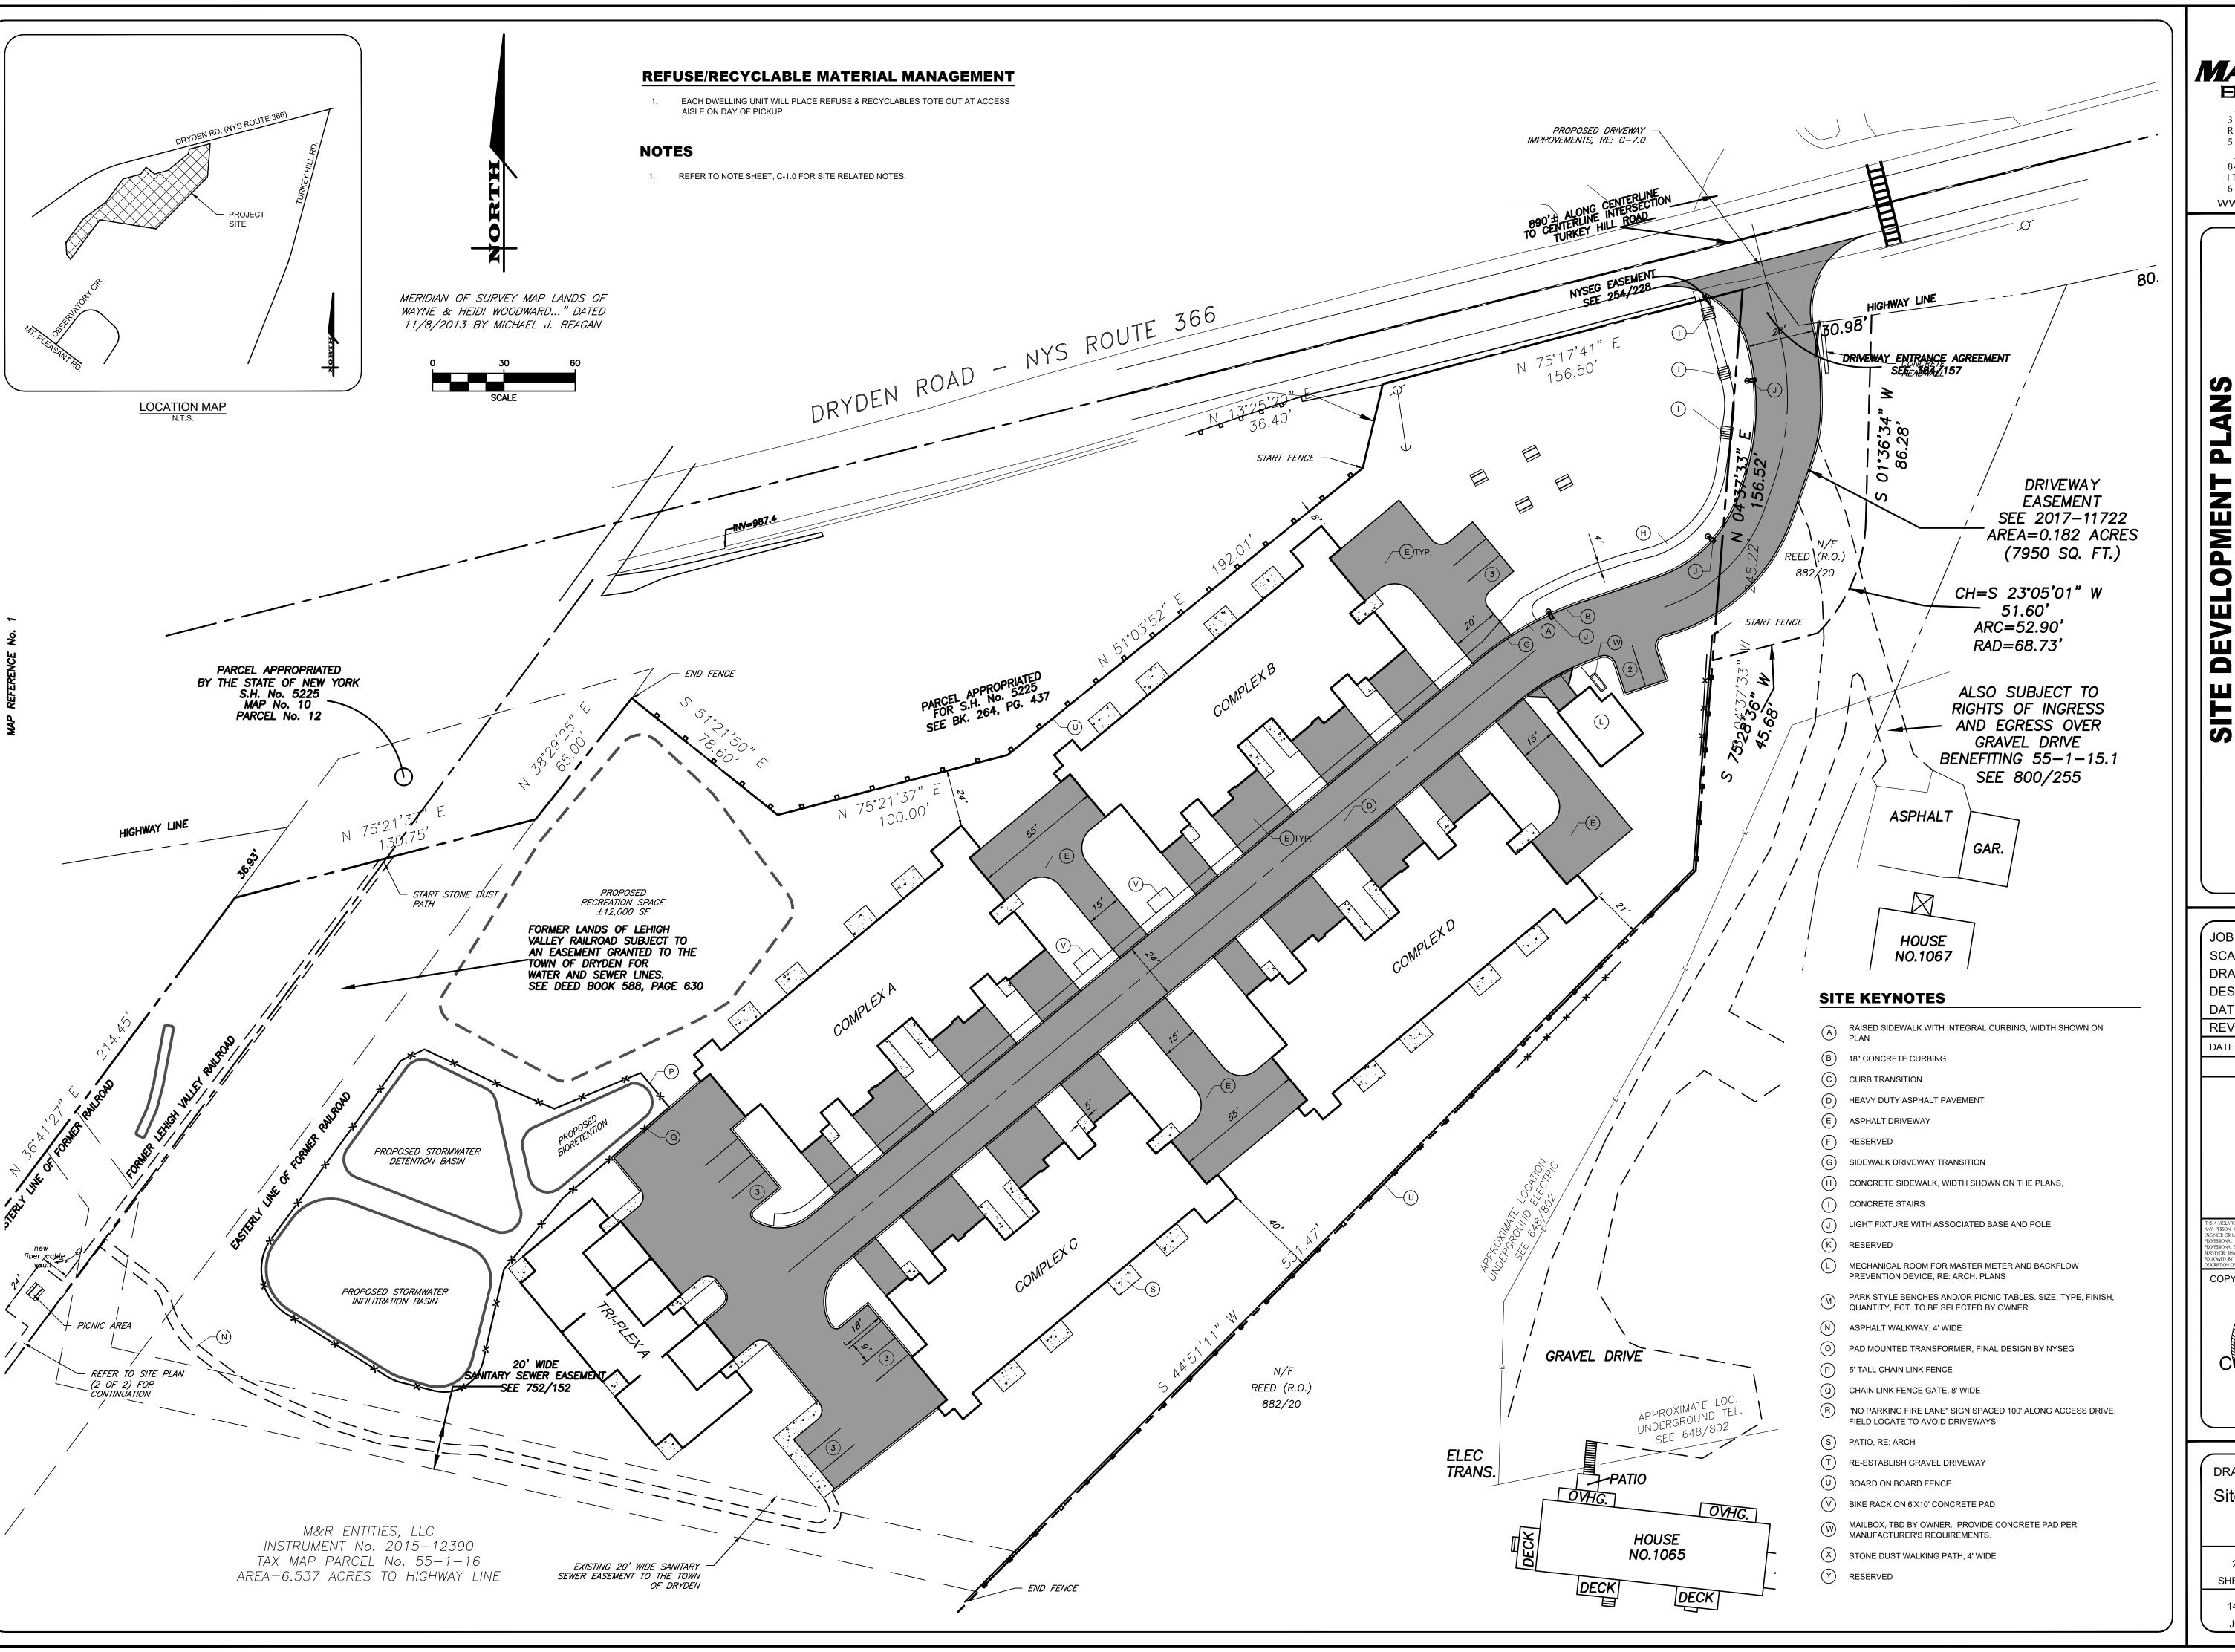

MARATHON ENGINEERING

3 9 CASCADE DRIVE ROCHESTER, NY 14614 5 8 5 - 4 5 8 - 7 7 7 0 ITHACA LOCATION 840 HANSHAW RD, STE 6 ITHACA, NY 14850 6 0 7 - 2 4 1 - 2 9 1 7

6 0 7 - 2 4 1 - 2 9 1 7 www.marathoneng.com

F NEW YORK

366)

DRYDEN, LLC

JOB NO: 1495-22

SCALE: 1"=30'

DRAWN: RLJ

DESIGNED: AMF

DATE: 8/30/23

REVISIONS

DATE BY REVISION

TI IS A VIOLATION OF NEW YORK STATE EDUCATION LAW ARTICLE 145, SECTION 7209 FOR ANY PERSON, UNLESS ACTING UNDER THE DIRECTION OF A LICENSED PROFESSIONAL ENGINEER OR LAND SURVEYOR, IF AN ITEM BEARING THE SEAL OF A PROFESSIONAL ENGINEER OR LAND SURVEYOR. IF AN ITEM BEARING THE SEAL OF A PROFESSIONAL ENGINEER OR LAND SURVEYOR. IF AN ITEM BEARING THE SEAL OF A PROFESSIONAL ENGINEER OR LAND SURVEYOR IS ALTERED, THE ALTERING ENGINEER OR LAND SURVEYOR SHALL AFTIX TO THE ITEM THEIR SEAL AND THE NOTATION "ALTERED BY FOLLOWED BY THEIR SIGNANDER AND THE DATE OF SUCH ALTERATION, AND A SPECIFIC DESCRIPTION OF THE ALTERATION.

COPYRIGHT® 2023 MARATHON ENG.

DRAWING TITLE:
Site Plan

2 of 16
SHEET No:
1495-22


C-2.0

DRAWING No:

JOB No:

CONSTRUCTION

ADAM M. FISHEL

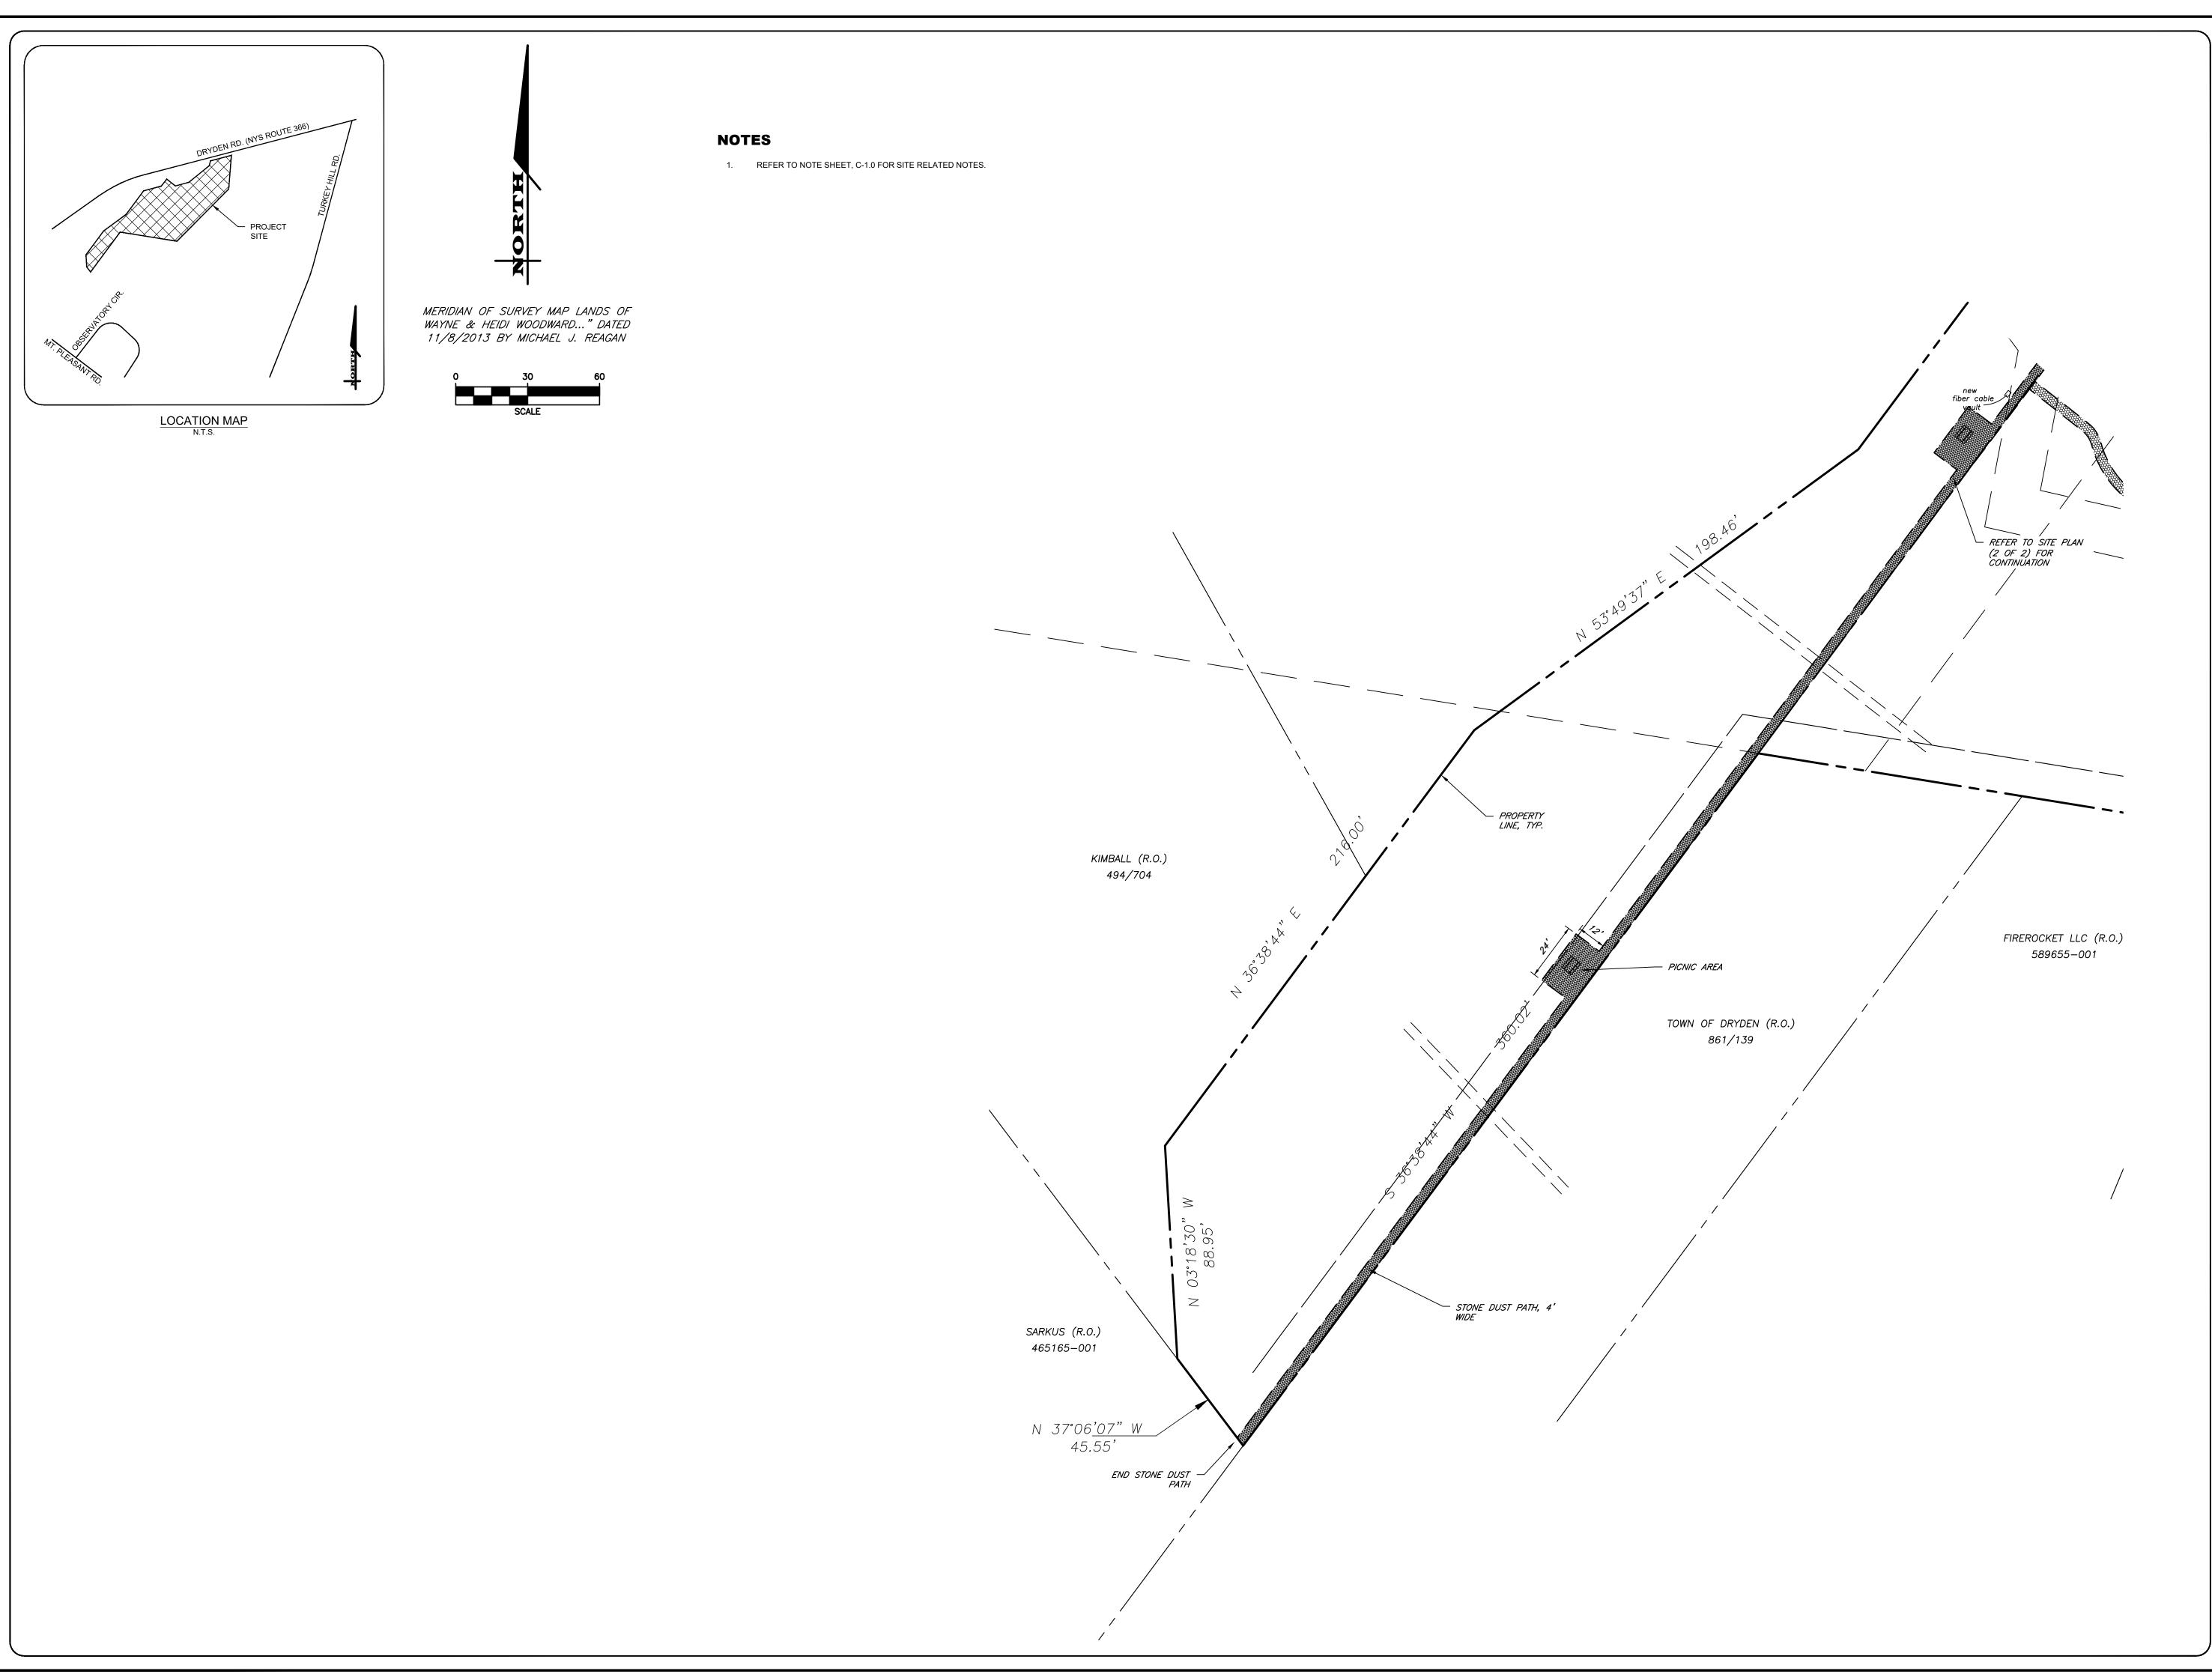

MARATHON ENGINEERING
ROCHESTER LOCATION

3 9 CASCADE DRIVE ROCHESTER, NY 14614 5 8 5 - 4 5 8 - 7 7 7 0 ITHACA LOCATION 840 HANSHAW RD, STE 6 ITHACA, NY 14850 6 0 7 - 2 4 1 - 2 9 1 7

www.marathoneng.com

ATE OF NEW YORK

DRYDEN, LLC

TOWN OF DRYDE

JOB NO: 1495-22

SCALE: 1"=30'

DRAWN: RLJ

DESIGNED: AMF

DATE: 8/30/23

REVISIONS

DATE BY REVISION

T IS A VIOLATION OF NEW YORK STATE EDUCATION LAW ARTICLE 145, SECTION 7209 FOR ANY PERSON, UNILESS ACTING UNDER THE DIRECTION OF A LICENSED PROFESSIONAL ENGINEER OR LAND SURVEYOR, TO ALTER IN ANY WAY, AN ITEM BEARING THE SEAL OF A PROFESSIONAL ENGINEER OR LAND SURVEYOR. IF AN ITEM BEARING THE SEAL OF A PROFESSIONAL ENGINEER OR LAND SURVEYOR IS ALTERED, THE ALTERING FORICHER OR LAND SURVEYOR SHALL AFFIX TO THE ITEM THERE SEAL AND THE NOTATION "ALTERED BY FOLLOWED BY THEIR SIGNATURE AND THE DATE OF SUCH ALTERATION, AND A SPECIFIC DESCRIPTION OF THE ALTERATION.

COPYRIGHT© 2023 MARATHON ENG.

COPYRIGHT© 2023 MARATHON ENG.

OF NEW

CONSTRUCTION

NO. 086648

ADAM M. FISHEL

DRAWING TITLE:
Site Plan (2 of 2)

3 of 16
SHEET No:

1495-22
JOB No: DRAWING No:



ELEVATION SPECIFICATION NOTES:

2.0 SITE WORK 2.1 GRADE VARIES (REFER TO SITE ENGINEERS GRADING PLAN)

2.2 BUILDING STEP VERIFY STEP HT. AND LOCATION W/ SITE PLAN (STEPPED BUILDINGS ONLY)

3.0 CONCRETE

- 3.1 CONCRETE SPREAD FOOTING. REFER TO FOUNDATION PLAN FOR SIZING
- 3.2 CONCRETE PORCH, FLUSH WITH INTERIOR FLOOR. SLOPE AWAY FROM BUILDING
- 3.3 SLOPE SIDEWALK TO PORCH 1/12 MAX. SLOPE 3.4 STEP FTG. AS REQ. TO MAINTAIN 3'-6" MIN. FROST DEPTH

SEE DETAIL '3 I' SHT. A-7. I (STEPPED BUILDINGS ONLY)

4.1 CONCRETE BLOCK FOUNDATION WALL

4.2 LIGHT WEIGHT STONE VENEER MFR., STYLE & COLOR T.B.D 4.3 PRECAST STONE SILL

5.0 METALS 5.1 1x2 OVER 2x8 ALUMINUM WRAPPED RAKES 5.2 2x6 ALUMINUM WRAPPED FASCIA WITH METAL DRIP EDGE W/ 5" ALUMINUM 'K' GUTTER WITH DOWNSPOUTS.

FINAL LOCATION BY CONTRACTOR IN FIELD.

6.1 6" VINYL CORNER BOARDS

6.2 Ix6 PVC GABLE FRIEZE 6.3 IX6 PVC FRIEZE AT EAVE, 2X8 AT SECOND FLR. BAND 6.4 IX8 PVC CROSSHEAD AT WINDOWS, DOORS AND

OVERHEAD GARAGE DOORS. 6.5 Ix6 PVC SIDE CASING AT WINDOWS \$ DOORS 6.6 I x4 PVC SIDE CASING AT OVERHEAD GARAGE DOORS

6.7 Ix4 PVC SILL AT WINDOWS 6.8 Ix PVC WRAPPED BOX BEAMS AND RING JOIST FASCIA. TYPICAL AT ALL PORCH AND DECK LOCATIONS

6.9 G" x 6" P.T. POST W/ PVC WRAP, BASE & CAP MOLDING TYPICAL AT ALL PORCH AND DECK LOCATIONS 6.10 42"H METAL REINFORCED PVC GUARD RAIL SYSTEM. SEE

DETAILS SHEET A-7.2 6.11 PVC PANEL

6.12 5/4 x 6 P.T. DECKING MATERIAL AS SELECTED P.T. DECK JOISTS 6.13 PRIVACY FENCE, SEE DETAIL 36, SHEET A-7.2

6.14 4x8 PVC BOARD BEHIND GAS & ELEC. METERS. LOCATION TO BE DETERMINED ON SITE

7.0 THERMAL \$ MOISTURE PROTECTION 7.1 25 YEAR MIN. ARCHITECTURAL FIBERGLASS / ASPHALT SHINGLES.

MFR., TYPE & COLOR T.B.D. 7.2 5" T.W. VINYL SIDING. MFR., TYPE & COLOR T.B.D.

7.3 RIDGE VENTS. BREAK VENTS AT DRAFT STOPPING, SEE SHT. A-5 7.4 SADDLE (SEE ROOF FRAMING PLAN)

7.5 VINYL SHAKE SIDING

8.0 WINDOWS AND DOORS

8.1 SILVERLINE (VI) SERIES LOW-E WARGON SINGLE HUNG WINDOWS WITH GRILLES AS SHOWN. (U VALUE .30/ SHGC .27,

AIR INFILTRATION RATE ≤ 0.3CFM/FT.2 OR EQUAL) 8.2 THERMA TRU S93 ENTRY DOORS (W/ SIDLITES PER ELEVATION) 8.3 9/0 x 7/0 (ONE CAR GARAGE) OR 16/0 x 7/0 (TWO CAR GARAGE) WAYNE DALTON 8000 SERIES OVERHEAD INSULATED

STEEL DOORS. 8.4 SILVERLINE, 5800 SERIES WHITE SLIDING DRS. (W/ GRILLS AS SHOWN) (LOW-E W/ ARGON U-.28/ SHGC .26 OR EQUAL) W/ ADA COMPLIANCE HARDWARE \$ THRESHOLD KIT

(LOWER UNITS ONLY) 8.5 SILVERLINE, 5800 SERIES WHITE SLIDING DRS. (W/ GRILLS AS SHOWN) (LOW-E W/ ARGON U-.28/ SHGC .26 OR EQUAL)

(UPPER UNITS ONLY) 8.6 NOT USED

8.7 KOLBE, LATITUDE SERIES WHITE FRENCH DR. (W/ GRILLES AS SHOWN) (LOW-E W/ ARGON U-.28/ SHGC .26 OR EQUAL)

8.8 SILVERLINE (VI) SERIES LOW-E WARGON CASEMENT WINDOWS

I 6.0 ELECTRICAL I G. I PROVIDE WALL MOUNTED LIGHTING AT OVERHEAD GARAGE DOOR LOCATIONS AND SURFACE MOUNTED DOWN LIGHTS AT

WINDOW MEETS REQUIREMENTS FOR WINDOWS NEEDING WINDOW FALL PROTECTION PER 2020 BCNYS SECTION 1015.8

UNIT ENTRY CEILINGS 16.2 SINGLE VRP OUTDOOR UNIT - HEAT PUMP (10 LOCATIONS)

WINDOW MEETS OR EXCEEDS THE EGRESS REQUIREMENTS PER 2020 BCNYS SECTION 1030

WINDOW MEETS REQUIREMENTS FOR HAZARDOUS LOCATIONS NEEDING SAFETY GLAZING PER 2020 BCNYS SECTION 2406

THESE PLANS ARE PROTECTED UNDER FEDERAL COPYRIGHT LAWS BY JAMES FAHY DESIGN. ANY REPRODUCTION, OR MODIFICATION OF THESE PLANS, IN WHOLE OR IN PART, WITHOUT THE EXPRESS WRITTEN CONSENT OF JAMES FAHY DESIGN IS A VIOLATION OF COPYRIGHT LAWS. CLIENT RIGHTS ARE LIMITED TO ONE-TIME USE FOR CONSTRUCTION OF THESE PLANS.

UNAUTHORIZED ALTERATIONS OR ADDITIONS TO THIS DRAWING IS A VIOLATION OF THE NEW YORK STATE EDUCATION LAW, ARTICLE 145, SECTION

Copyright © 2022 James Fahy, P.E., P.C. All rights reserved.

REV	ISIONS:		
NO.	DATE	BY	DESCRIPTION
1	10-6-22	ART	WDW. \$ DR. CROSSHEADS FULL STONE TO HALF

PROJECT: GENESEE POINTE APTS. IO-UNIT APARTMENT HENRIETTA, NEW YORK

BUILDINGS 1, 7, 8 \$ 11

CLIENT:


PG RIVERTON PARCEL E LLC

DRAWING TITLE:

FRONT ELEVATION

CONSTRUCTION DOCUMENTS

JOB NO. A22-101	PROJECT NO. APARTMENTS
DRAWN BY: ART	DRAWING NO:
CHECKED BY: AQR	
DATE: 10-4-2022] / \

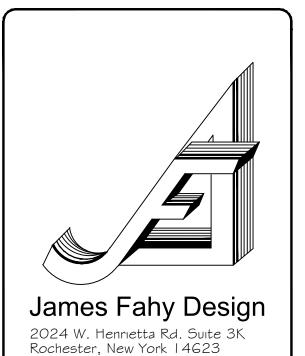

tel: 585-272-1650

e-mail: info@jamesfahy.com website: www.jamesfahy.com



ELEVATION SPECIFICATION NOTES:

2.0 SITE WORK

2.1 GRADE VARIES (REFER TO SITE ENGINEERS GRADING PLAN) 2.2 BUILDING STEP VERIFY STEP HT. AND LOCATION W/ SITE PLAN (STEPPED BUILDINGS ONLY)

3.0 CONCRETE

- 3.1 CONCRETE SPREAD FOOTING. REFER TO FOUNDATION PLAN FOR SIZING
- 3.2 CONCRETE PORCH, FLUSH WITH INTERIOR FLOOR. SLOPE AWAY FROM BUILDING
- 3.3 SLOPE SIDEWALK TO PORCH 1/12 MAX. SLOPE 3.4 STEP FTG. AS REQ. TO MAINTAIN 3'-6" MIN. FROST DEPTH SEE DETAIL '3 I' SHT. A-7. I (STEPPED BUILDINGS ONLY)

4.1 CONCRETE BLOCK FOUNDATION WALL

4.2 LIGHT WEIGHT STONE VENEER MFR., STYLE & COLOR T.B.D 4.3 PRECAST STONE SILL

5.0 METALS

5.1 1x2 OVER 2x8 ALUMINUM WRAPPED RAKES 5.2 2x6 ALUMINUM WRAPPED FASCIA WITH METAL DRIP EDGE W/ 5" ALUMINUM 'K' GUTTER WITH DOWNSPOUTS. FINAL LOCATION BY CONTRACTOR IN FIELD.

6.0 WOODS & PLASTICS

6.1 6" VINYL CORNER BOARDS

6.2 Ix6 PVC GABLE FRIEZE 6.3 IXG PVC FRIEZE AT EAVE, 2X8 AT SECOND FLR. BAND 6.4 IX8 PVC CROSSHEAD AT WINDOWS, DOORS AND OVERHEAD GARAGE DOORS.

6.5 Ix6 PVC SIDE CASING AT WINDOWS \$ DOORS 6.6 Ix4 PVC SIDE CASING AT OVERHEAD GARAGE DOORS

6.7 Ix4 PVC SILL AT WINDOWS 6.8 Ix PVC WRAPPED BOX BEAMS AND RING JOIST FASCIA. TYPICAL AT ALL PORCH AND DECK LOCATIONS

6.9 6" x 6" P.T. POST W/ PVC WRAP, BASE & CAP MOLDING TYPICAL AT ALL PORCH AND DECK LOCATIONS 6.10 42"H METAL REINFORCED PVC GUARD RAIL SYSTEM. SEE

DETAILS SHEET A-7.2 6.11 PVC PANEL

6.12 5/4 x 6 P.T. DECKING MATERIAL AS SELECTED P.T. DECK JOISTS 6.13 PRIVACY FENCE, SEE DETAIL 36, SHEET A-7.2

6.14 4x8 PVC BOARD BEHIND GAS & ELEC. METERS. LOCATION TO BE DETERMINED ON SITE

7.0 THERMAL \$ MOISTURE PROTECTION
7.1 25 YEAR MIN. ARCHITECTURAL FIBERGLASS / ASPHALT SHINGLES. MFR., TYPE & COLOR T.B.D.

7.2 5" T.W. VINYL SIDING. MFR., TYPE \$ COLOR T.B.D. 7.3 RIDGE VENTS. BREAK VENTS AT DRAFT STOPPING, SEE SHT. A-5

7.4 SADDLE (SEE ROOF FRAMING PLAN)

8.0 WINDOWS AND DOORS

7.5 VINYL SHAKE SIDING

8.1 SILVERLINE (VI) SERIES LOW-E WARGON SINGLE HUNG WINDOWS WITH GRILLES AS SHOWN. (U VALUE .30/ SHGC .27,

AIR INFILTRATION RATE ≤ 0.3CFM/FT.2 OR EQUAL) 8.2 THERMA TRU S93 ENTRY DOORS (W/ SIDLITES PER ELEVATION) 8.3 9/0 x 7/0 (ONE CAR GARAGE) OR 16/0 x 7/0 (TWO CAR GARAGE) WAYNE DALTON 8000 SERIES OVERHEAD INSULATED

STEEL DOORS. 8.4 SILVERLINE, 5800 SERIES WHITE SLIDING DRS. (W/ GRILLS AS SHOWN) (LOW-E W/ ARGON U-.28/ SHGC .26 OR EQUAL) W/ ADA COMPLIANCE HARDWARE \$ THRESHOLD KIT

(LOWER UNITS ONLY) 8.5 SILVERLINE, 5800 SERIES WHITE SLIDING DRS. (W/ GRILLS AS SHOWN) (LOW-E W/ ARGON U-.28/ SHGC .26 OR EQUAL)

(UPPER UNITS ONLY) 8.6 NOT USED

8.7 KOLBE, LATITUDE SERIES WHITE FRENCH DR. (W/ GRILLES AS SHOWN) (LOW-E W/ ARGON U-.28/ SHGC .26 OR EQUAL)

8.8 SILVERLINE (VI) SERIES LOW-E WARGON CASEMENT WINDOWS

16.1 PROVIDE WALL MOUNTED LIGHTING AT OVERHEAD GARAGE DOOR LOCATIONS AND SURFACE MOUNTED DOWN LIGHTS AT UNIT ENTRY CEILINGS

16.2 SINGLE VRP OUTDOOR UNIT - HEAT PUMP (10 LOCATIONS)

© WINDOW MEETS OR EXCEEDS THE EGRESS REQUIREMENTS PER 2020 BCNYS SECTION 1030

WINDOW MEETS REQUIREMENTS FOR HAZARDOUS WINDOW MEETS REQUIREMENTS FOR HAZARDOUS

LOCATIONS NEEDING SAFETY GLAZING PER 2020 BCNYS SECTION 2406

MINDOW MEETS REQUIREMENTS FOR WINDOWS NEEDING WINDOW FALL PROTECTION PER 2020 BCNYS SECTION 1015.8

COPYRIGHT NOTICE: THESE PLANS ARE PROTECTED UNDER FEDERAL COPYRIGHT LAWS BY JAMES FAHY DESIGN. ANY REPRODUCTION, OR MODIFICATION OF THESE PLANS, IN WHOLE OR IN PART, WITHOUT THE EXPRESS WRITTEN CONSENT OF JAMES FAHY DESIGN IS A VIOLATION OF COPYRIGHT LAWS.
CLIENT RIGHTS ARE LIMITED TO ONE-TIME USE
FOR CONSTRUCTION OF THESE PLANS.

UNAUTHORIZED ALTERATIONS OR ADDITIONS TO THIS DRAWING IS A VIOLATION OF THE NEW YORK STATE EDUCATION LAW, ARTICLE 145, SECTION

Copyright © 2022 James Fahy, P.E., P.C. All rights reserved.

REV	ISIONS:		
NO.	DATE	BY	DESCRIPTION
I	10-6-22	ART	WDW. \$ DR. CROSSHEADS FULL STONE TO HALF
			TOLL STONE TO TIALI
igcup			
•	•		

PROJECT: GENESEE POINTE APTS. IO-UNIT APARTMENT HENRIETTA, NEW YORK

BUILDINGS 1, 7, 8 \$ 11


CLIENT:

PG RIVERTON PARCEL E LLC

DRAWING TITLE: REAR ELEVATION

CONSTRUCTION DOCUMENTS


JOB NO. A22-101	PROJECT NO. APARTMENTS
DRAWN BY: ART	DRAWING NO:
CHECKED BY: AQR	A_
DATE: 10-4-2022	

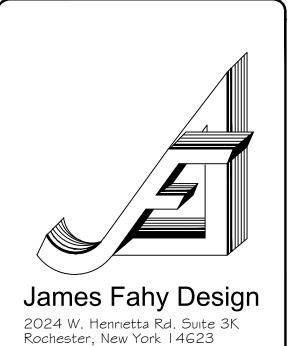

tel: 585-272-1650

e-mail: info@jamesfahy.com website: www.jamesfahy.com



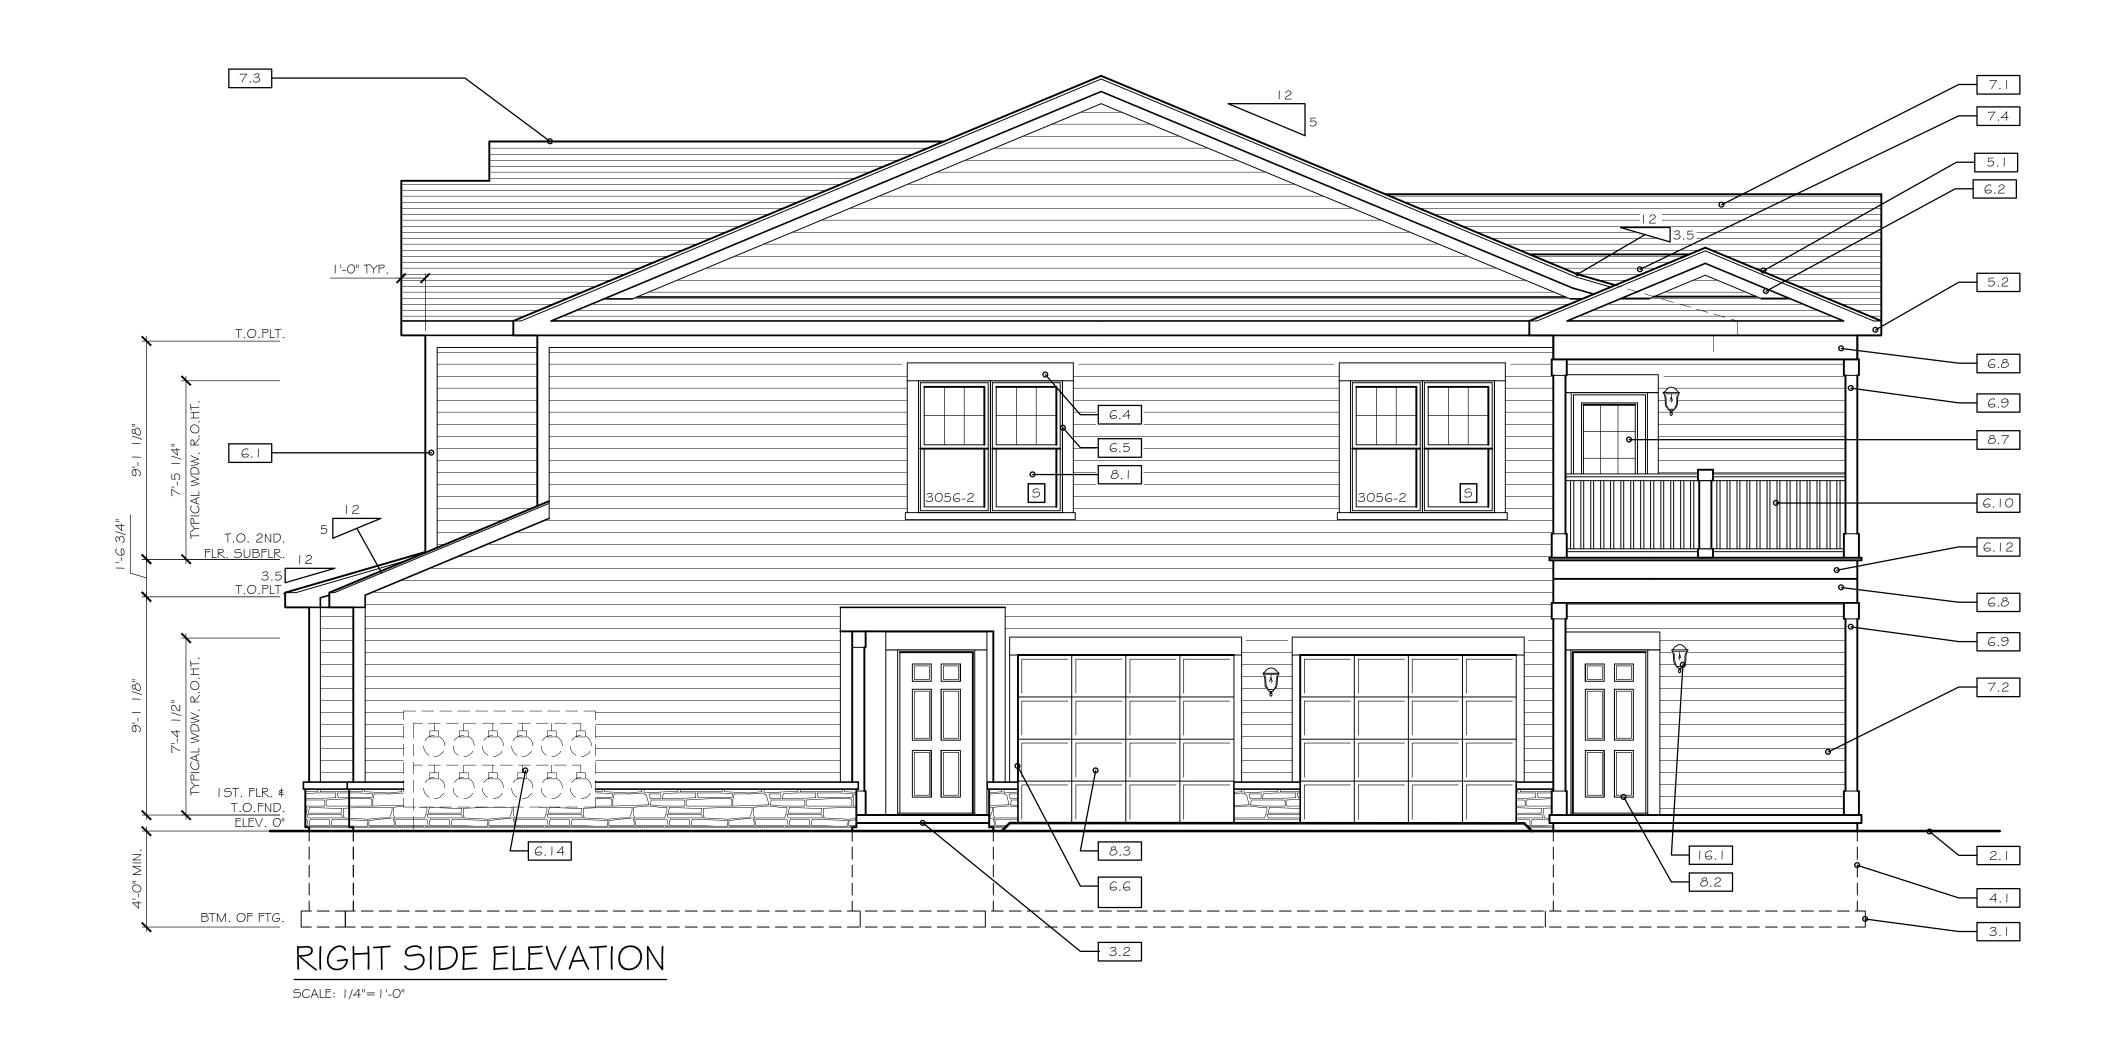

ELEVATION SPECIFICATION NOTES:

2.0 SITE WORK

(STEPPED BUILDINGS ONLY)

PLAN FOR SIZING

3.2 CONCRETE PORCH, FLUSH WITH INTERIOR FLOOR.

4.0 MASONRY

4.2 LIGHT WEIGHT STONE VENEER MFR., STYLE & COLOR T.B.D

5.1 1x2 OVER 2x8 ALUMINUM WRAPPED RAKES
5.2 2x6 ALUMINUM WRAPPED FASCIA WITH METAL DRIP EDGE W/ 5" ALUMINUM 'K' GUTTER WITH DOWNSPOUTS.

6.0 WOODS & PLASTICS

OVERHEAD GARAGE DOORS.

6.6 I x4 PVC SIDE CASING AT OVERHEAD GARAGE DOORS

6.9 6" x 6" P.T. POST W/ PVC WRAP, BASE & CAP MOLDING

6.10 42"H METAL REINFORCED PVC GUARD RAIL SYSTEM. SEE

DETAILS SHEET A-7.2

6.13 PRIVACY FENCE, SEE DETAIL 36, SHEET A-7.2

6.14 4x8 PVC BOARD BEHIND GAS & ELEC. METERS. LOCATION TO BE DETERMINED ON SITE

MFR., TYPE & COLOR T.B.D.

7.2 5" T.W. VINYL SIDING. MFR., TYPE \$ COLOR T.B.D.

7.4 SADDLE (SEE ROOF FRAMING PLAN)

8.1 SILVERLINE (VI) SERIES LOW-E W/ARGON SINGLE HUNG

8.4 SILVERLINE, 5800 SERIES WHITE SLIDING DRS. (W/ GRILLS AS SHOWN) (LOW-E W/ ARGON U-.28/ SHGC .26 OR EQUAL) W/ ADA COMPLIANCE HARDWARE \$ THRESHOLD KIT

8.5 SILVERLINE, 5800 SERIES WHITE SLIDING DRS. (W/ GRILLS AS SHOWN) (LOW-E W/ ARGON U-.28/ SHGC .26 OR EQUAL)

8.6 NOT USED

SHOWN) (LOW-E W/ ARGON U-.28/ SHGC .26 OR EQUAL)

I 6.0 ELECTRICAL
I 6.1 PROVIDE WALL MOUNTED LIGHTING AT OVERHEAD GARAGE DOOR LOCATIONS AND SURFACE MOUNTED DOWN LIGHTS AT

16.2 SINGLE VRP OUTDOOR UNIT - HEAT PUMP (10 LOCATIONS)

WINDOW MEETS REQUIREMENTS FOR WINDOWS NEEDING

WINDOW FALL PROTECTION PER 2020 BCNYS SECTION 1015.8

2. I GRADE VARIES (REFER TO SITE ENGINEERS GRADING PLAN) 2.2 BUILDING STEP VERIFY STEP HT. AND LOCATION W/ SITE PLAN

3.1 CONCRETE SPREAD FOOTING. REFER TO FOUNDATION

SLOPE AWAY FROM BUILDING 3.3 SLOPE SIDEWALK TO PORCH 1/12 MAX. SLOPE 3.4 STEP FTG. AS REQ. TO MAINTAIN 3'-6" MIN. FROST DEPTH SEE DETAIL '3 I' SHT. A-7. I (STEPPED BUILDINGS ONLY)

4.1 CONCRETE BLOCK FOUNDATION WALL

4.3 PRECAST STONE SILL

FINAL LOCATION BY CONTRACTOR IN FIELD.

6. I 6" VINYL CORNER BOARDS 6.2 Ix6 PVC GABLE FRIEZE

6.3 I x 6 PVC FRIEZE AT EAVE, 2X8 AT SECOND FLR. BAND ↑6.4 Ix8 PVC CROSSHEAD AT WINDOWS, DOORS AND

6.5 I x6 PVC SIDE CASING AT WINDOWS \$ DOORS

6.7 Ix4 PVC SILL AT WINDOWS

6.8 Ix PVC WRAPPED BOX BEAMS AND RING JOIST FASCIA. TYPICAL AT ALL PORCH AND DECK LOCATIONS

TYPICAL AT ALL PORCH AND DECK LOCATIONS

6.11 PVC PANEL 6.12 5/4 x 6 P.T. DECKING MATERIAL AS SELECTED P.T. DECK JOISTS

7.0 THERMAL & MOISTURE PROTECTION 7.1 25 YEAR MIN. ARCHITECTURAL FIBERGLASS / ASPHALT SHINGLES.

7.3 RIDGE VENTS. BREAK VENTS AT DRAFT STOPPING, SEE SHT. A-5

7.5 VINYL SHAKE SIDING

8.0 WINDOWS AND DOORS

WINDOWS WITH GRILLES AS SHOWN. (U VALUE .30/ SHGC .27,

AIR INFILTRATION RATE ≤ 0.3CFM/FT.2 OR EQUAL) 8.2 THERMA TRU S93 ENTRY DOORS (W/ SIDLITES PER ELEVATION) 8.3 9/0 x 7/0 (ONE CAR GARAGE) OR 1 6/0 x 7/0 (TWO CAR GARAGE) WAYNE DALTON 8000 SERIES OVERHEAD INSULATED

(LOWER UNITS ONLY)

(UPPER UNITS ONLY)

8.7 KOLBE, LATITUDE SERIES WHITE FRENCH DR. (W/ GRILLES AS

8.8 SILVERLINE (VI) SERIES LOW-E WARGON CASEMENT WINDOWS

UNIT ENTRY CEILINGS

WINDOW MEETS OR EXCEEDS THE EGRESS REQUIREMENTS PER 2020 BCNYS SECTION 1030

WINDOW MEETS REQUIREMENTS FOR HAZARDOUS LOCATIONS NEEDING SAFETY GLAZING PER 2020 BCNYS SECTION 2406

THESE PLANS ARE PROTECTED UNDER FEDERAL COPYRIGHT LAWS BY JAMES FAHY DESIGN. ANY REPRODUCTION, OR MODIFICATION OF THESE PLANS, IN WHOLE OR IN PART, WITHOUT THE EXPRESS WRITTEN CONSENT OF JAMES FAHY DESIGN IS A VIOLATION OF COPYRIGHT LAWS.

CLIENT RIGHTS ARE LIMITED TO ONE-TIME USE FOR CONSTRUCTION OF THESE PLANS. UNAUTHORIZED ALTERATIONS OR ADDITIONS TO THIS DRAWING IS A VIOLATION OF THE NEW YORK STATE EDUCATION LAW, ARTICLE 145, SECTION

Copyright © 2022 James Fahy, P.E., P.C. All rights reserved.

REVISIONS: NO. DATE BY DESCRIPTION 10-6-22 ART WDW. \$ DR. CROSSHEADS FULL STONE TO HALF

PROJECT: GENESEE POINTE APTS. IO-UNIT APARTMENT

BUILDINGS 1, 7, 8 \$ 11

HENRIETTA, NEW YORK

CLIENT:

PG RIVERTON PARCEL E LLC

SIDE ELEVATIONS

DRAWING TITLE:

10-4-2022


PROJECT NO. APARTMENTS A22-101 DRAWN BY: DRAWING NO: CHECKED BY:

CONSTRUCTION DOCUMENTS



tel: 585-272-1650

e-mail: info@jamesfahy.com website: www.jamesfahy.com

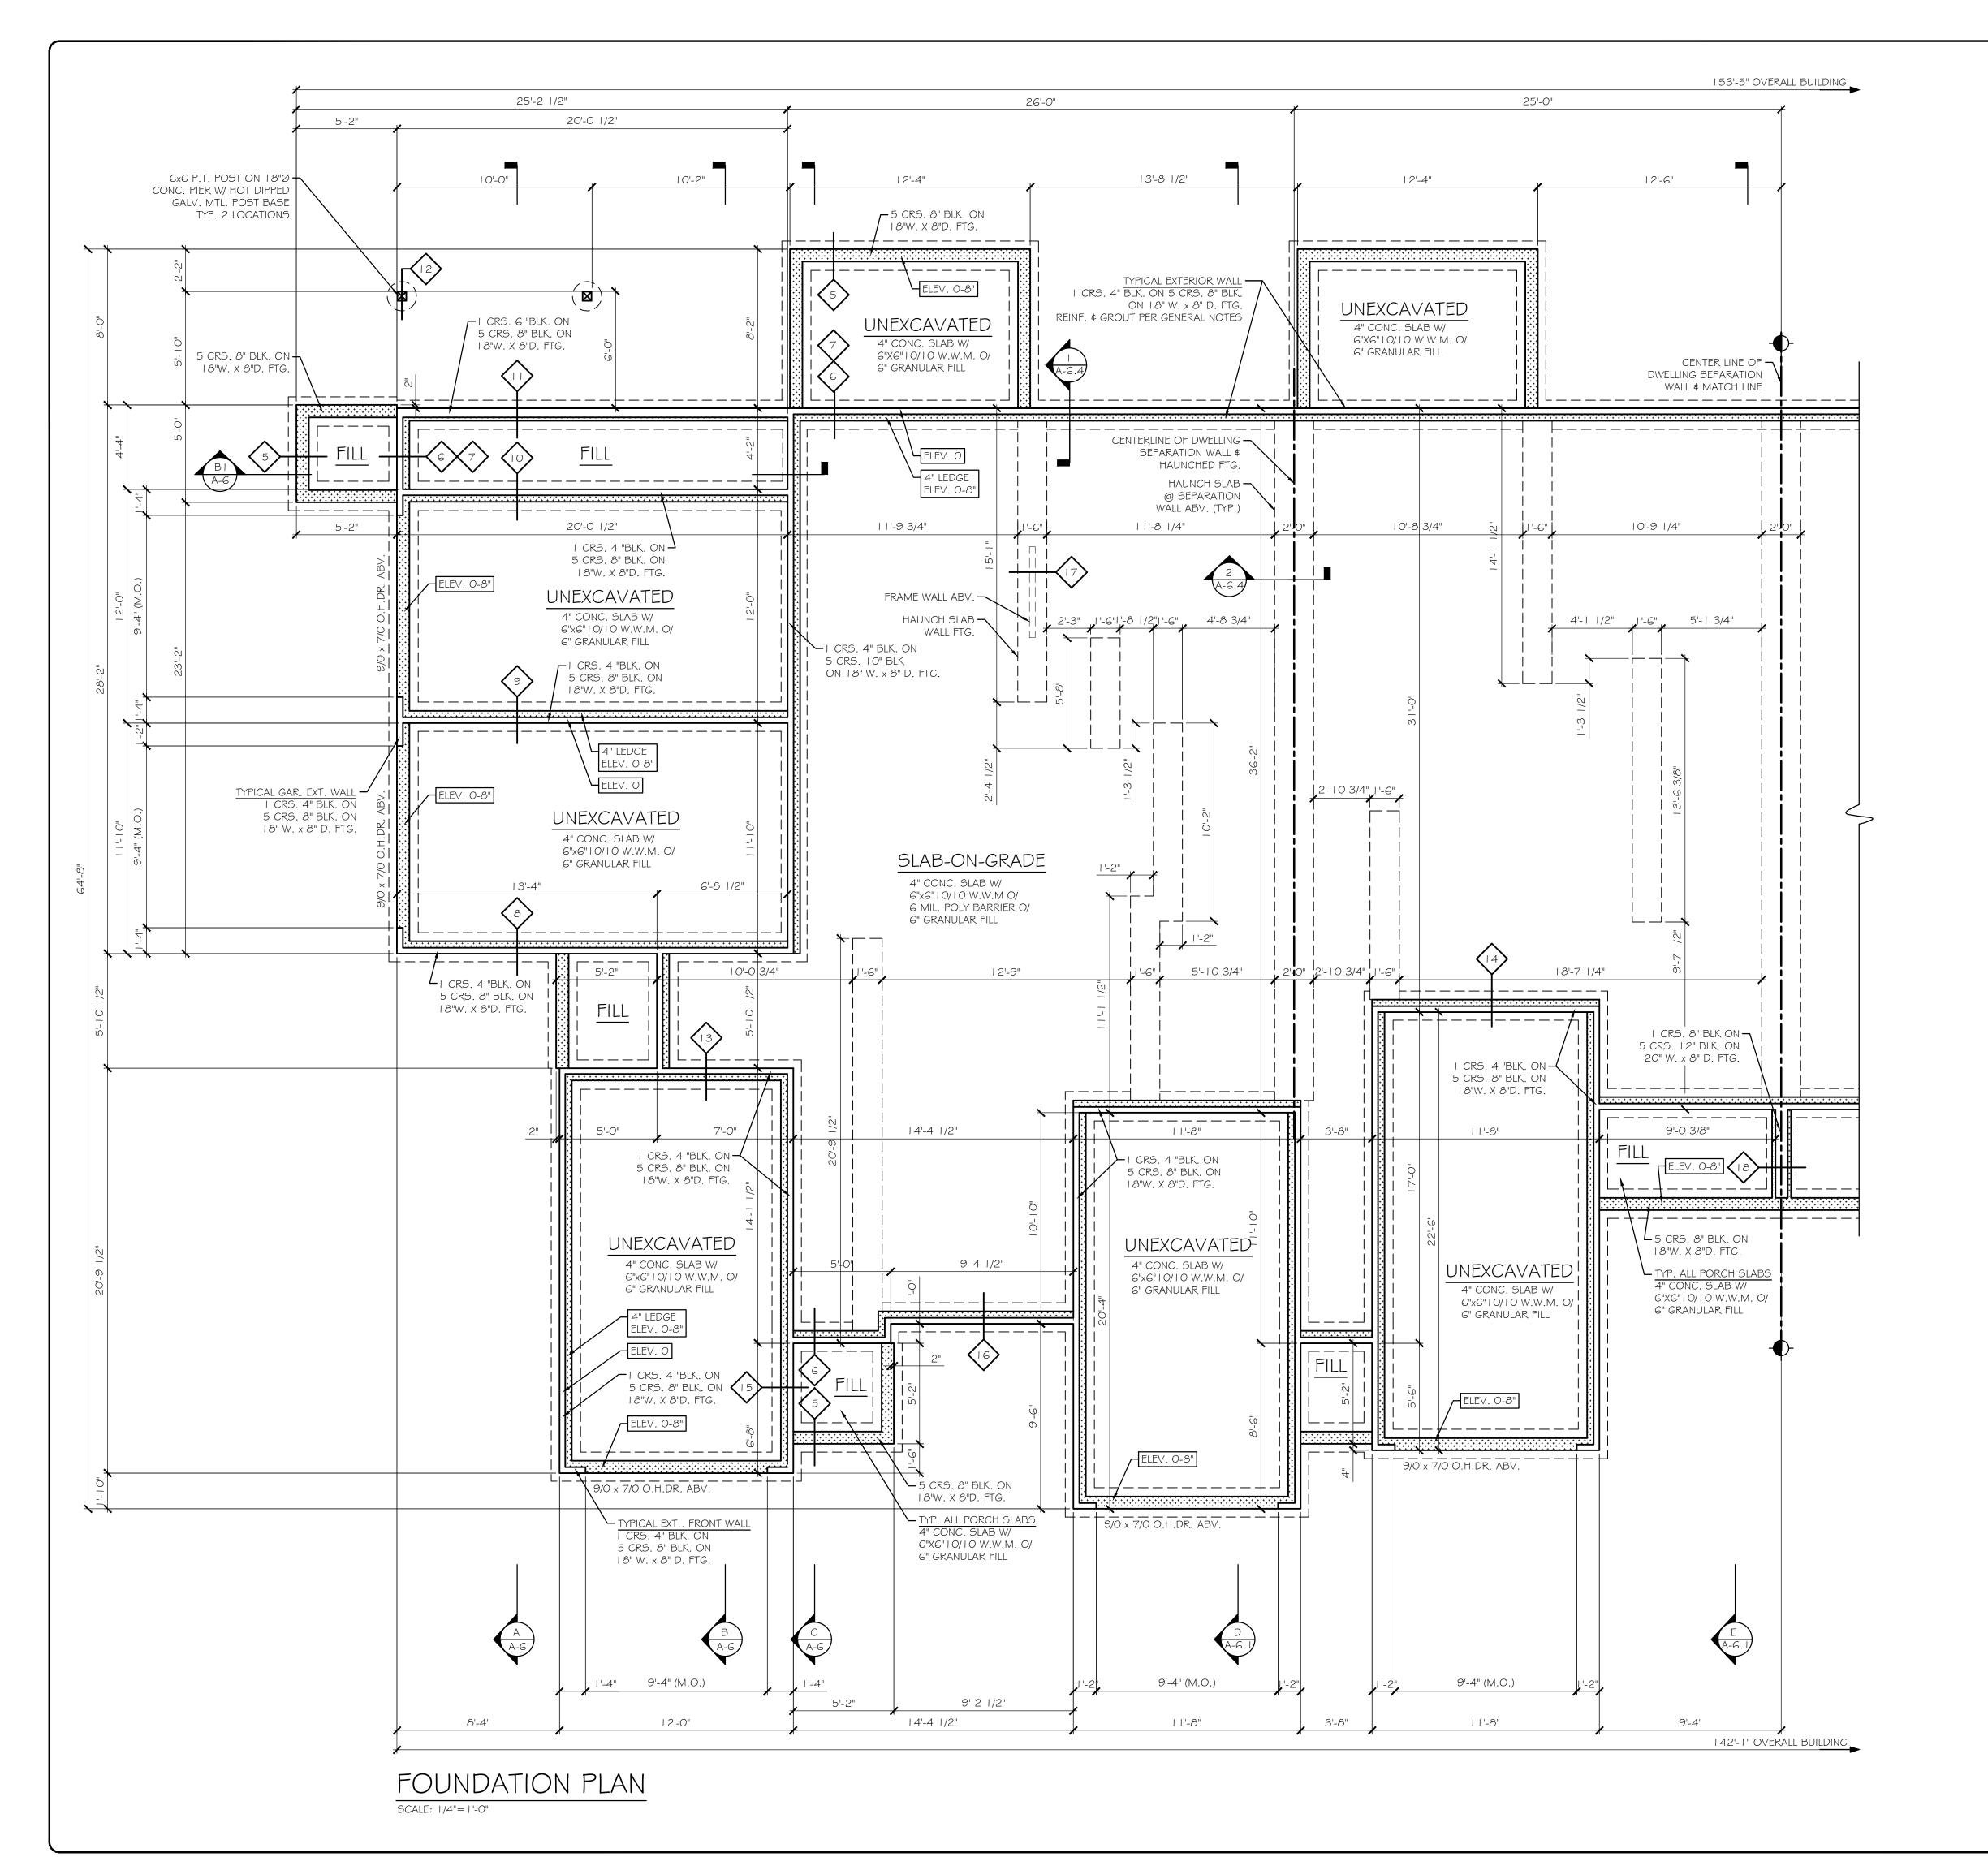

GENERAL NOTES: UNLESS OTHERWISE NOTED

CONSTRUCTION NOTES

300 S.F. ±

• SLABS AT PATIOS, PORCHES, WALWAYS AND GARAGES TO BE 3500 PSI MIN., AIR ENTRAINED. • INTERIOR SLABS SHALL BE 2500 PSI MIN. AND SHALL BE AIR

ENTRAINED IF SUBJECT TO FREEZING AND THAWING DURING CONSTRUCTION. WALLS AND SPREAD FOOTING TO BE 3000 PSI MIN. W/

REINFORCING AS NOTED AND SHALL BE AIR ENTRAINED IF SUBJECT TO FREEZING AND THAWING DURING CONSTRUCTION. • INSTALL I" DEEP x 1/4" WIDE CONTROL JOINTS IN SLAB EVERY

• GROUT CORES SOLID @ ALL 4" \$ 6" BLK. LOCATIONS AND IN THE STARTING COURSE ON FOUNDATION WHERE ADJACENT CELLS OR CAVITIES ARE TO BE GROUTED.

 GROUT CORES SOLID AT ALL LOCATIONS RECEIVING VERTICAL REINFORCING.

 ALL SLABS TO BE REINFORCED WITH WIRE MESH AS NOTED ALL CONCRETE WORK SHALL CONFORM TO THE REQUIREMENTS OF ACI 3 18 AND CHAPTER 2020 BCNYS

 CONCRETE MASONRY SHALL CONFORM TO THE REQUIREMENTS OF ACI AND CHAPTER 21 2020 BCNYS

• CONCRETE MASONRY UNITS SHALL CONFORM TO ASTM C-90 TYPE I, GRADE N, MOISTURE CONTROLLED UNITS. MORTAR SHALL BE TYPE M OR S GROUT SHALL CONFORM TO ASTM C476 WITH A MINIMUM

COMPRESSIVE STRENGTH OF 2000 PSI AT 28 DAYS. GROUT SHALL BE PLACED IN LIFTS NOT EXCEEDING 7 COURSES IN HEIGHT UNLESS OTHERWISE APPROVED BY THE ARCHITECT.

 COORDINATE LOCATION OF ALL MASONRY WALLS, PARTITIONS AND OPENINGS WITH ARCHITECTURAL DRAWINGS.

 ALL FOOTINGS (INCLUDING HAUNCHED SLAB SHALLOW WALL FOOTINGS) MUST BEAR ON FIRM, UNDISTURBED NATIVE SOILS OR ENGINEERED FILL. (SEE NOTE BELOW) ON SITE SOIL USED AS ENGINEERED FILL SHALL BE FREE OF

DELETERIOUS MATERIALS WITH NO PARTICLES GREATER THAN 3 INCHES. IMPORTED MATERIALS USED AS ENGINEERED FILL SHALL BE CLOSE IN GRADATION TO N.Y.S. D.O.T. ITEM 203.07 (SELECT GRANULAR FILL). FILL SHALL BE PLACED IN LOOSE LIFTS NOT TO EXCEED 8 INCHES IN DEPTH AND COMPACTED TO 95% MAXIMUM DRY DENSITY PER ASTM D | 557 AT MOISTURE CONTENTS WITHIN 3% OF OPTIMUM.

 PROVIDE CHEMICAL HARDENER AND SEALER TO ALL TROWEL FINISHED INTERIOR FLOORS WHICH ARE TO BE LEFT EXPOSED

 PROVIDE A NON SKID FINISH TO ALL CONCRETE WALKWAYS AND PITCH TO AVOID PONDING.

TYPICAL REINFORCING:

 ALL WALL FOOTINGS TO HAVE 2 NO. 5 BARS CONTINUOUS • REINFORCE ALL FOUNDATION WALLS W/ NO. 4 BAR 48" O.C.

VERTICAL, TIED TO FOOTING W/ 3" HOOK ALL HAUCHED FOOTINGS TO HAVE 2 NO. 5 BARS CONTINUOUS

ALL ANGLES TO BE 12/12

LEGEND:

ELEV. = O''

ELEV. = 0 - 8"

CONSTRUCTION DETAIL

ALL DETAILS SHOWN ON SHEETS A-7 TO A-7.2

THESE PLANS ARE PROTECTED UNDER FEDERAL COPYRIGHT LAWS BY JAMES FAHY DESIGN. AN REPRODUCTION. OR MODIFICATION OF THESE PLANS, IN WHOLE OR IN PART, WITHOUT THE EXPRESS WRITTEN CONSENT OF JAMES FAHY DESIGN IS A VIOLATION OF COPYRIGHT LAWS. CLIENT RIGHTS ARE LIMITED TO ONE-TIME USE FOR CONSTRUCTION OF THESE PLANS.

UNAUTHORIZED ALTERATIONS OR ADDITIONS TO THIS DRAWING IS A VIOLATION OF THE NEW YORK STATE EDUCATION LAW, ARTICLE 145, SECTION

Copyright © 2022 James Fahy, P.E., P.C. All rights reserved.

REV	ISIONS:		
NO.	DATE	BY	DESCRIPTION
I	10-6-22	ART	WDW. \$ DR. CROSSHEADS FULL STONE TO HALF

GENESEE POINTE APTS. I O-UNIT APARTMENT HENRIETTA, NEW YORK

BUILDINGS 1, 7, 8 \$ 11


PG RIVERTON PARCEL E LLC

DRAWING TITLE:

FOUNDATION PLAN


CONSTRUCTION DOCUMENTS

	JOB NO. A22-101	PROJECT NO. APARTMENTS
	DRAWN BY: ART	DRAWING NO:
	CHECKED BY: AQR	A-2
	DATE: 10-4-2022	

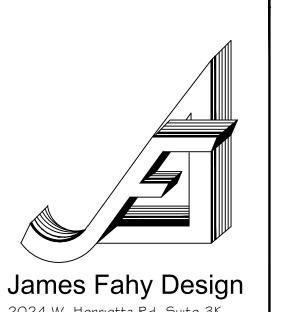


2024 W. Henrietta Rd. Suite 3K Rochester, New York 14623 tel: 585-272-1650

e-mail: info@jamesfahy.com website: www.jamesfahy.com

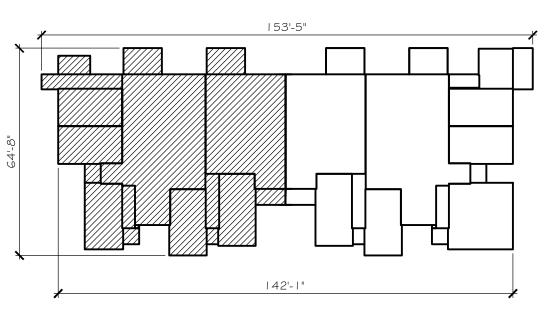

KEY PLAN

SCALE: | "=30'-0"

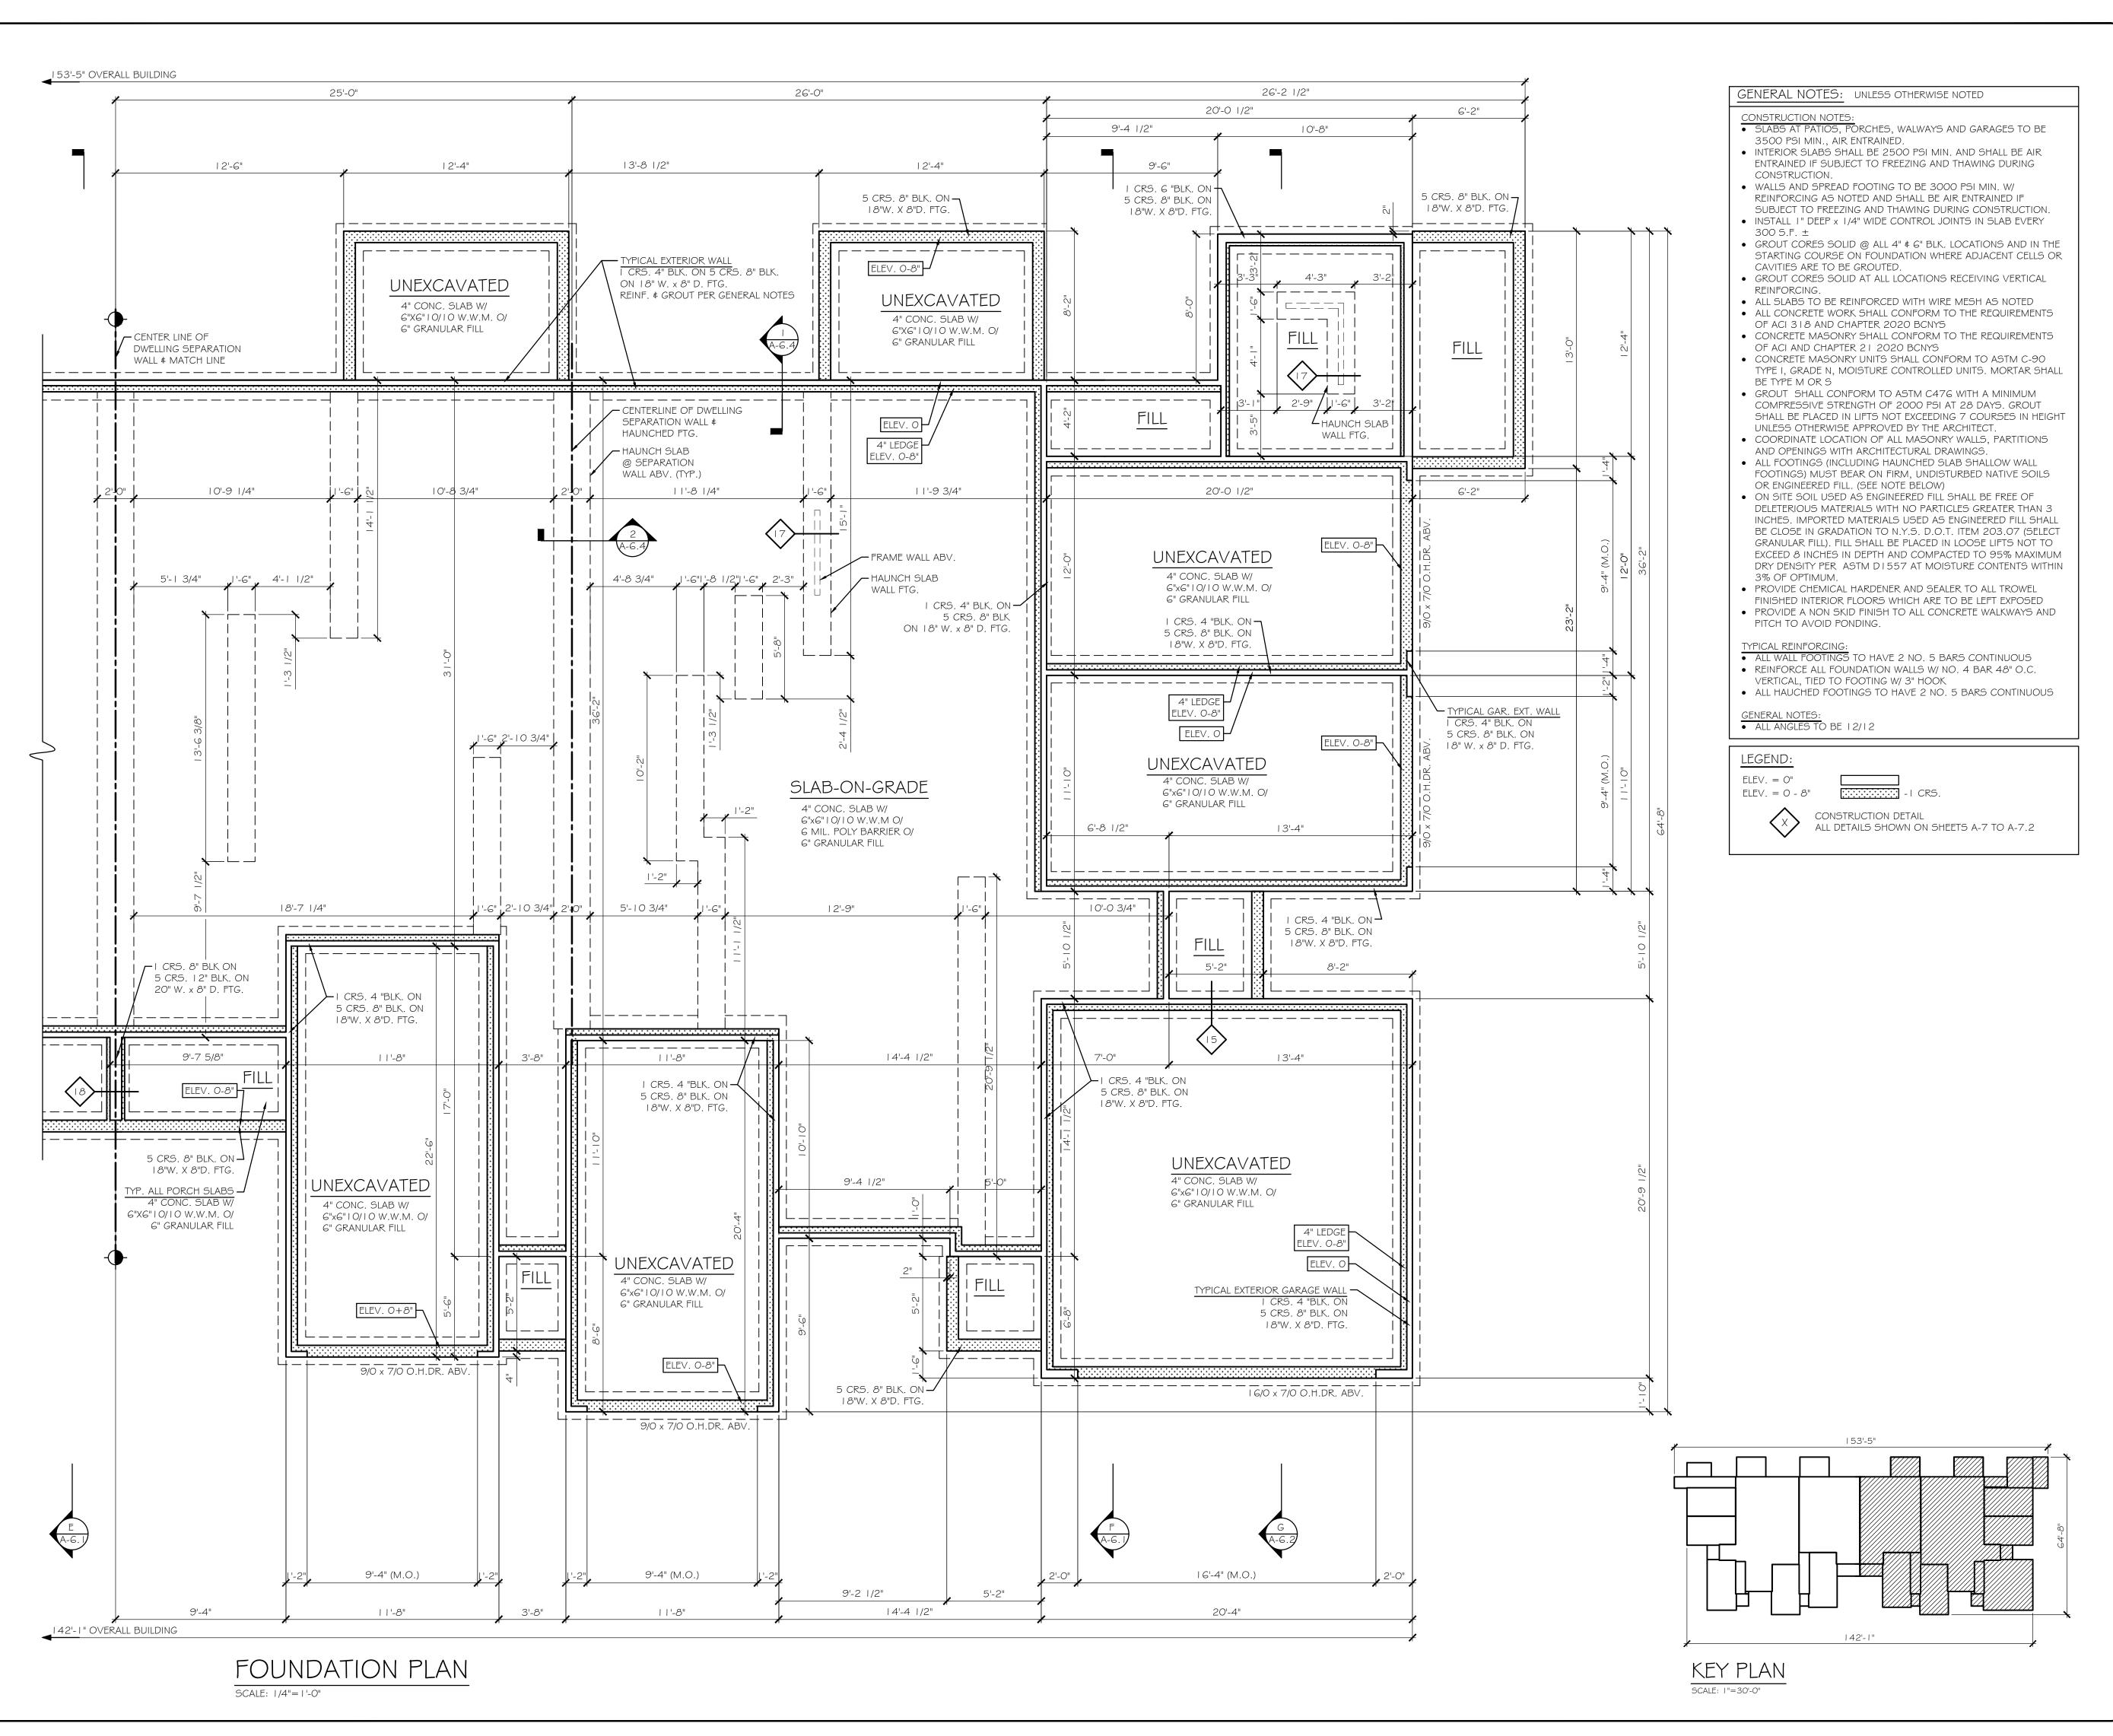

THESE PLANS ARE PROTECTED UNDER FEDERAL COPYRIGHT LAWS BY JAMES FAHY DESIGN. ANY REPRODUCTION, OR MODIFICATION OF THESE PLANS, IN WHOLE OR IN PART, WITHOUT THE EXPRESS WRITTEN CONSENT OF JAMES FAHY DESIGN IS A VIOLATION OF COPYRIGHT LAWS.

CLIENT RIGHTS ARE LIMITED TO ONE-TIME USE FOR CONSTRUCTION OF THESE PLANS.

UNAUTHORIZED ALTERATIONS OR ADDITIONS TO THIS DRAWING IS A VIOLATION OF THE NEW YORK STATE EDUCATION LAW, ARTICLE 145, SECTION

Copyright © 2022 James Fahy, P.E., P.C. All rights reserved.

NO.	DATE	BY	DESCRIPTION
l	10-6-22	ART	WDW. \$ DR. CROSSHEAD FULL STONE TO HALF

PROJECT:

GENESEE POINTE APTS.

I O-UNIT APARTMENT

HENRIETTA, NEW YORK

BUILDINGS 1, 7, 8 \$ 11

`LIENIT.


PG RIVERTON PARCEL E LLC

DRAWING TITLE:

FOUNDATION PLAN

CONSTRUCTION DOCUMENTS

JOB NO. A22-101	PROJECT NO. APARTMENTS
DRAWN BY: ART	DRAWING NO:
CHECKED BY: AQR	A-2 I
DATE: 10-4-2022	/ \

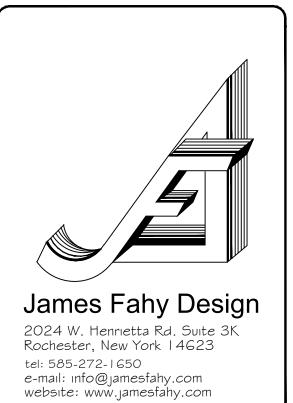





Project Name: Evergreen Apartments, Dryden NY

Date: August 31, 2023


Representative Rear Elevation Photos (Taken from East Pointe Apartments, Bomax Drive, Lansing, NY)










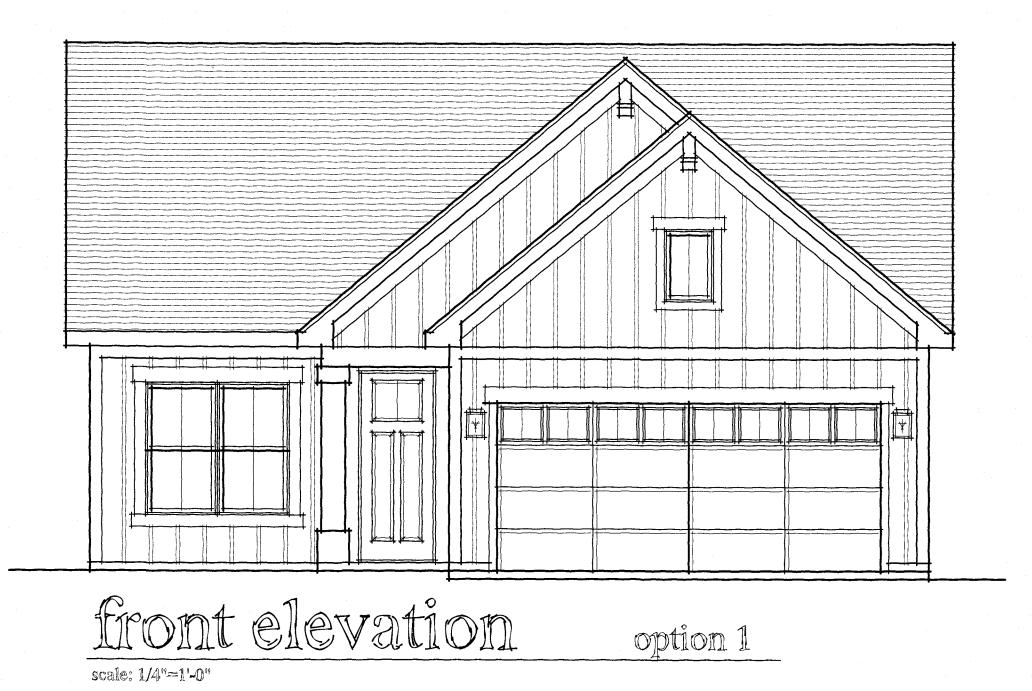




front elevation scale: 1/4"=1'-0"

option 2

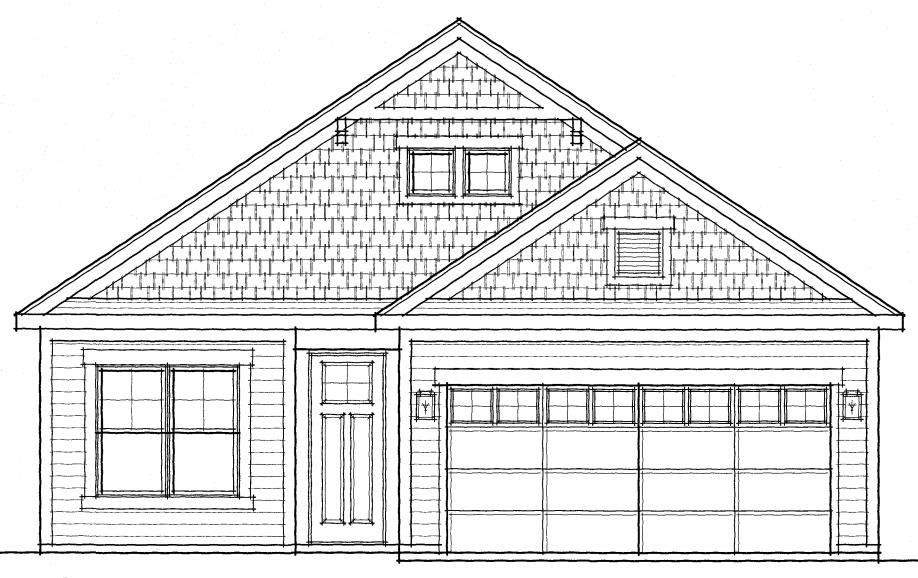

front elevation scale: 1/4"=1'-0"

option 3

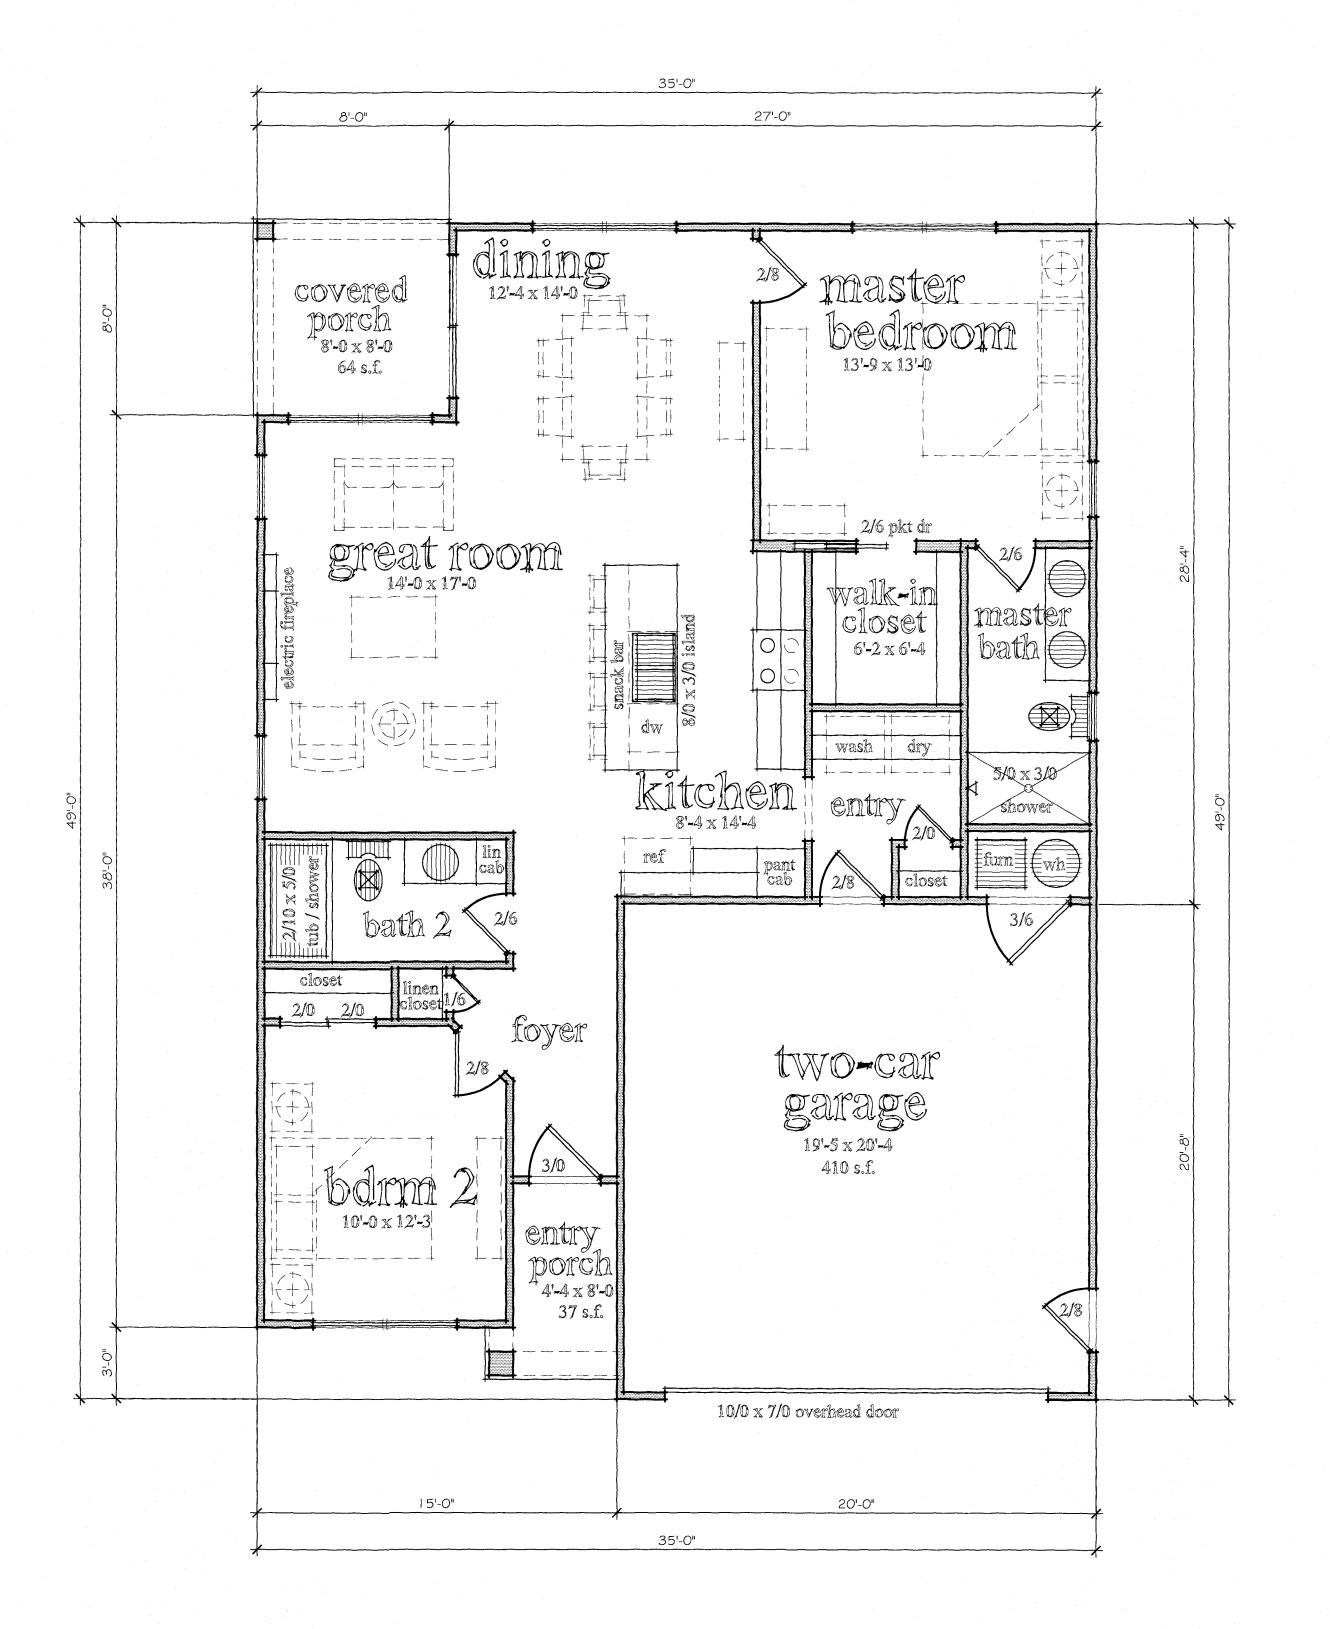

main floor plan

1170 s.f.

-ceiling height to be 9'-1 1/8" - all dimensions noted are interior and approximate COPYRIGHT NOTICE:
THESE PLANS ARE PROTECTED UNDER FEDERAL
COPYRIGHT LAWS BY JAMES FAHY DESIGN. ANY
REPRODUCTION, OR MODIFICATION OF THESE
PLANS, IN WHOLE OR IN PART, WITHOUT THE
EXPRESS WRITTEN CONSENT OF JAMES FAHY
DESIGN IS A VIOLATION OF COPYRIGHT LAWS.
CLIENT RIGHTS ARE LIMITED TO ONE-TIME USE
FOR CONSTRUCTION OF THESE PLANS. UNAUTHORIZED ALTERATIONS OR ADDITIONS TO THIS DRAWING IS A VIOLATION OF THE NEW YORK STATE EDUCATION LAW, ARTICLE 145, SECTION 7200

Copyright © 2023 James Fahy, P.E., P.C. All rights reserved.

NO.	DATE	BY	DESCRIPTION
\neg			


PROJECT: THE COTTAGES GATES MULTIFAMILY PROJECT GATES, NEW YORK

WHITESTONE DEVELOPMENT

DRAWING TITLE: FRONT ELEVATIONS \$ MAIN FLOOR PLAN

PHASE: PRELIMINARY PLAN

JOB NO. A23-059	PROJECT NO. 10-1170-2
DRAWN BY: KAD	DRAWING NO:
CHECKED BY: JRF	
DATE: 6-16-2023	/ / / / /

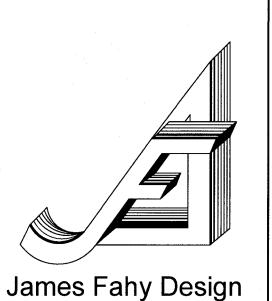

2024 W. Henrietta Rd. Suite 3K Rochester, New York 14623 tel: 585-272-1650 e-mail: info@jamesfahy.com website: www.jamesfahy.com