

# SITE DEVELOPMENT PLANS for PLANTATIONS RESTAURANT RECONSTRUCTION 1285 DRYDEN ROAD SITUATE IN: TOWN OF DRYDEN - TOMPKINS COUNTY - STATE OF NEW YORK NYS RT 13 PROJECT SITE LOCATION MAP N.T.S. MARATHON ENGINEERING ROCHESTER LOCATION 39 CASCADE DRIVE ROCHESTER, NY 14614 5 8 5 - 4 5 8 - 7 7 7 0 ITHACA LOCATION 840 HANSHAW RD, STE 6 ITHACA, NY 14850 6 0 7 - 2 4 1 - 2 9 1 7

COPYRIGHT © 2022 MARATHON ENGINEERING

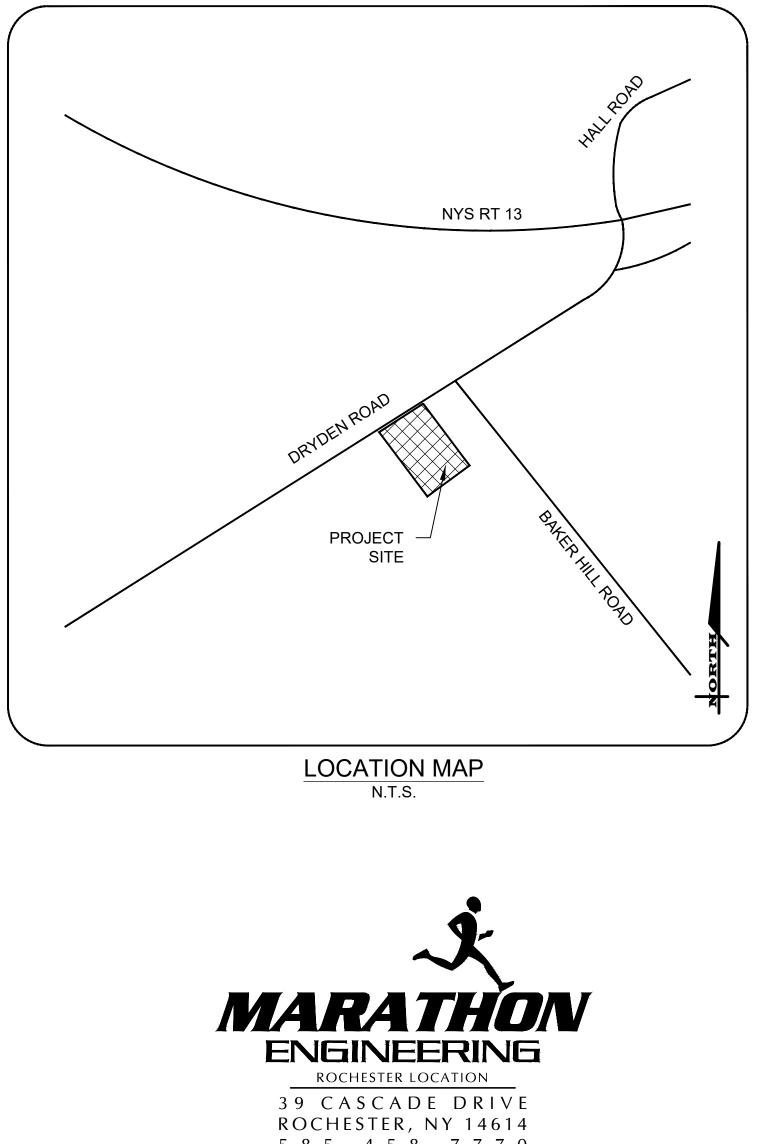



www.marathoneng.com

DWG. NO.	DESCRIPTION COVER SHEET	
_	COVER SHEET	
—	TOPOGRAPHIC MAP	
C-1.0	DEMOLITION PLAN	
C-2.0	SITE PLAN	
C-3.0	GRADING DRAINAGE & EROSION CONTROL PLAN	
C-4.0	UTILITY PLAN	
C-5.0	LIGHTING & LANDSCAPING PLAN	
C-6.0	DETAIL SHEET (1 OF 3)	
C-6.1	DETAIL SHEET (2 OF 3)	
C-6.2	DETAIL SHEET (3 OF 3)	
C-7.0	TRUCK TURN PLAN	
	C-2.0 C-3.0 C-4.0 C-5.0 C-6.0 C-6.1 C-6.2	

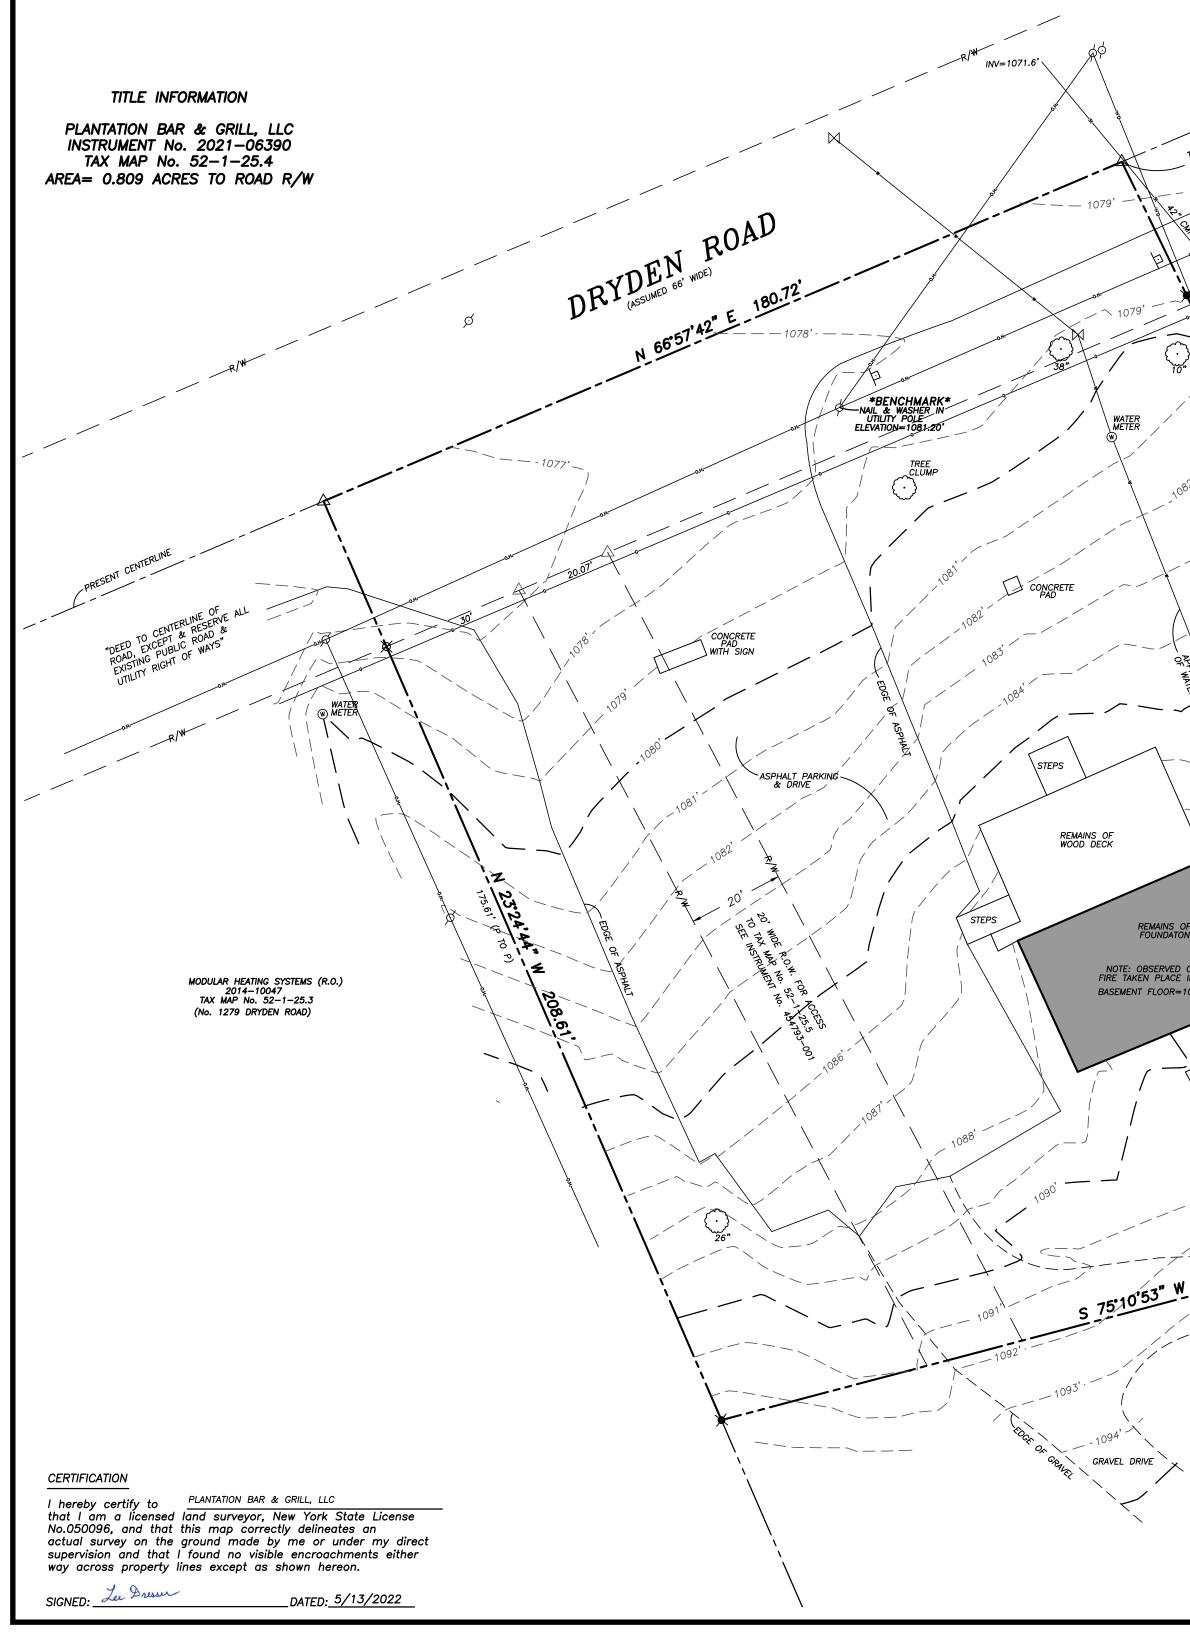

TIE=93.15'± ALONG & TO TIE=93.15'± ALONG & TO REALER HILL ROAD			MAGNETIC 1946
R/N -	LEGEND		
APPROX. LOCATION OF GAS PIPLINE	О.н SaSa 	- OVERHEAD WIRES - SANITARY SEWER MAIN - WATER MAIN - GAS MAIN	٩
		- STORM SEWER MAIN	
10"		– EXISTING DITCH – PROPERTY LINE	
		WATER VALVE	
	-0-	FIRE HYDRANT	
	⊙ <i>C.O</i> .	CLEANOUT	
SIX BAKER HILL ASSOC. LLC (R.O.)	Ø	UTILITY POLE	
SIX BAKER HILL ASSOC. LLC (R.O.) 2017-04562 TAX MAP No. 52-1-25.2 (No. 16 BAKER HILL ROAD)	(	GUY WIRE	
	$\odot$	DECIDUOUS TREE	
108 <sup>4</sup>	No. 1	CONIFEROUS TREE	
	<u> </u>	SIGN	
APPROX	×	IRON PIN FOUND	
	⊙ ∆	IRON PIPE FOUND CALCULATED POINT	
NOTE: RECENT EXCAVATING IN THIS AREA	NOTES:		
39.5'± 39.5'± 1088'- 1088'- 1088'- 1088'- 1092'- 1093'- 1094'- 1094'- 1094'-	REFERENCE STATIONS. 3.) UNDERGROUND UTILI FIELD LOCATIONS OF AB PROVIDED BY THE UTILIT BE CONSIDERED APPROX UTILITIES AND/OR STRUC NOT PRESENTLY KNOWN. UNDERGROUND UTILITIES ABOVE. VERIFY ALL UTIL 4.) IN THE EVENT THAT OF THE SIGNED AND SE DIGITAL DRAWING FILE, T SIGNATURE SHALL BE TH 5.) OUTLINE OF BUILDIN	VAVD88 PER THE NYSNET CONT TIES HAVE BEEN LOCATED FROM OVE GROUND STRUCTURES AND Y AUTHORITY. THEREFORE, THES IMATE. THERE MAY BE OTHER O TURES, THE LOCATION AND EXI LOCATIONS, SIZES AND MATER ARE BASED ON BEST AVAILABL THES PRIOR TO DESIGN OR COI THERE IS A DISCREPANCY BET ALED HARD COPY DRAWING AND HE HARD COPY WITH AN ORIGII IE CONTROLLING DOCUMENT. GS SHOWN HEREON ARE THE A JILDING DIMENSIONS PRIOR TO	A AVAILABLE RECORDS, ANY MARKINGS SE LOCATIONS MUST UNDERGROUND STENCE OF WHICH IS IALS OF E EVIDENCE AS NOTED NSTRUCTION. WEEN THE CONTENTS O THE CORRESPONDING NAL STAMP AND IT GRADE FOOTPRINT.
W GRAVEL DRIVE		N.	
/			
	`\		
WESTERLING (R.O.) 2021–03265 TAX MAP No. 52–1–25.5 (No. 1285 DRYDEN ROAD)			ALTERATION OF THIS MAP NOT CONFORMING TO SECTION 7209, SUBDIVISION 2, NEW YORK STATE EDUCATION LAW, ARE PROHIBITED BY LAW. ALL CERTIFICATIONS HEREOM ARE VALID FOR THIS MAP AND COPIES THEREOF ONLY IF SAID MAP OR COPIES BEAR THE IMPRESSION SEAL OF THE LICENSED LAND SURVEYOR WHOSE SIGNATURE APPEARS HEREON.
$\times$ $\square$		REVISED	OFNEM
T.G. MILLER, P.C. TOPOGRAPHIC	<b>&amp; BOUNDARY MAP</b> 5 DRYDEN ROAD TOMPKINS COUNTY, NEW YORK		ATE DRESSED OR STEEL DRESSED OR THE DRESSED OR THE DRESSED OR THE DRESSED OR THE
ITHACA, NEW YORK 14850	SCALE:		LAND SUP
WWW.TGMILLERPC.COM 607–272–6477 DATE: 5/13/2022	S22388 <b>3CALE. 1"=20'</b>		

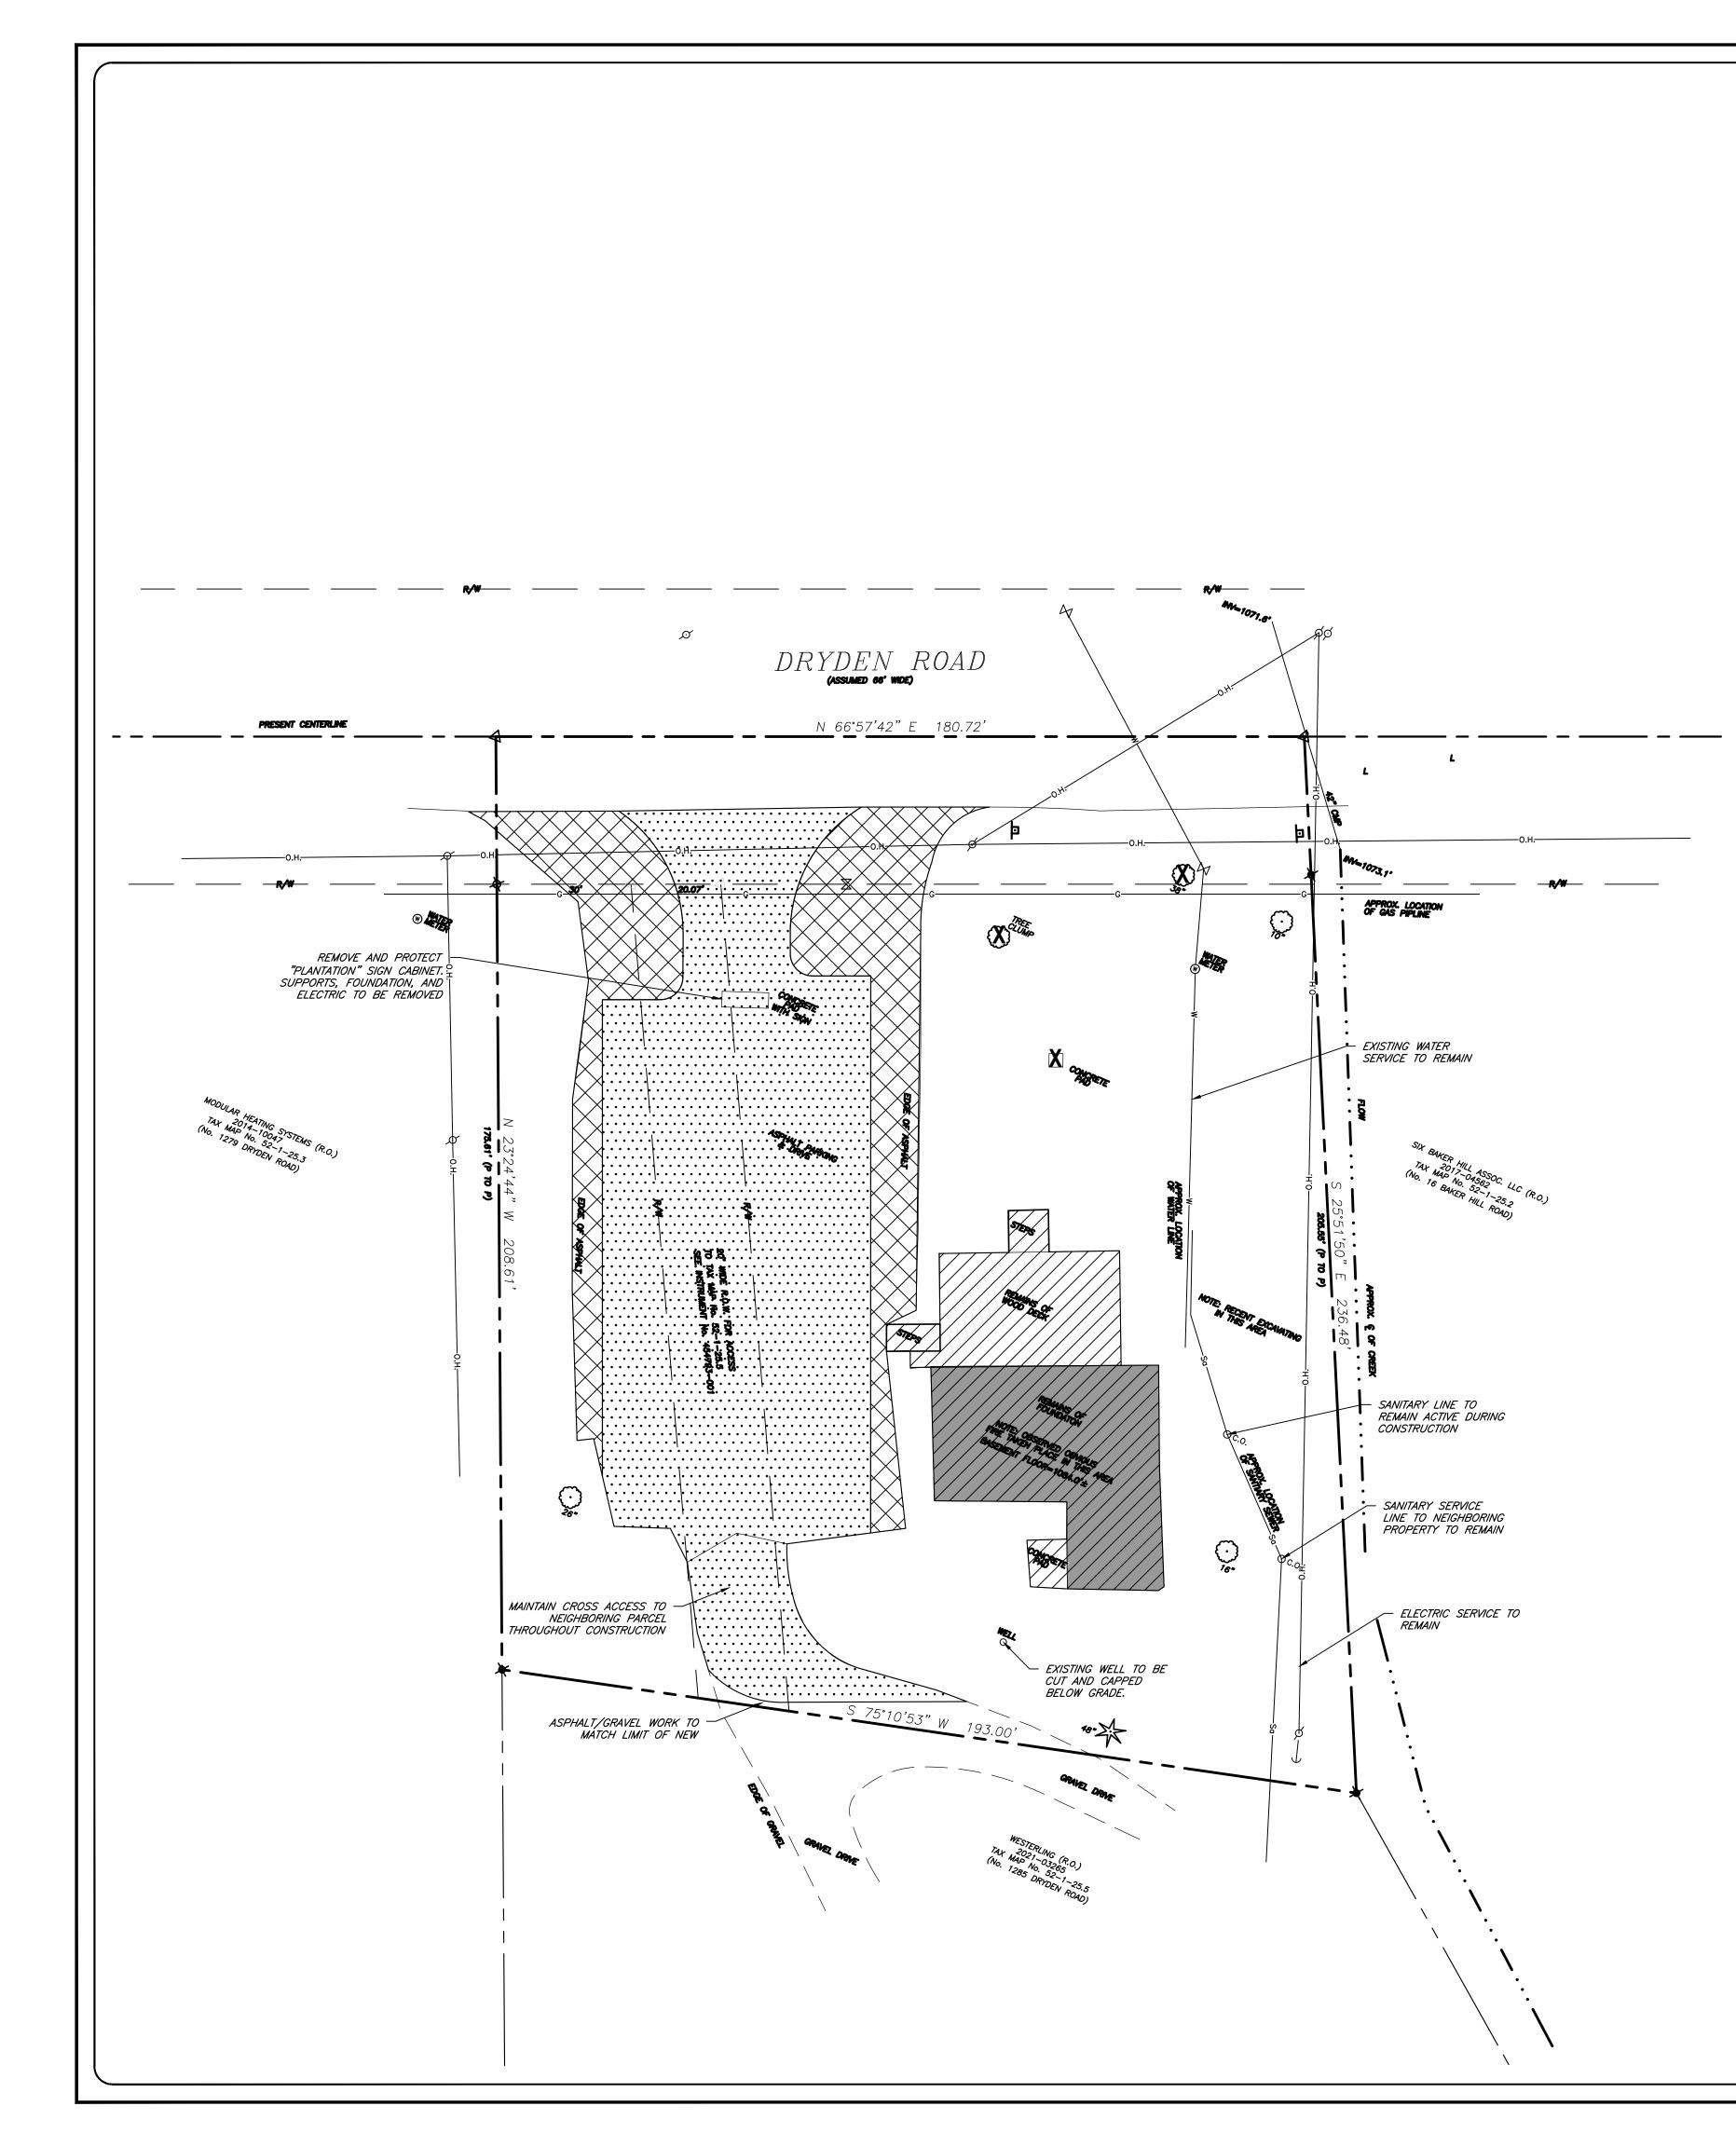

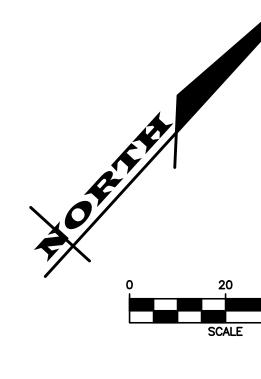



# **DEMOLITION NOTES**


- 1. THE CONTRACTOR IS RESPONSIBLE FOR THE DEMOLITION, REMOVAL, AND DISPOSAL (IN LOCATION APPROVED BY ALL GOVERNING AUTHORITIES) OF ALL STRUCTURES, PADS, WALLS, FLUMES, FOUNDATIONS, PARKING, DRIVES PIPES, STRUCTURES, UTILITIES, ETC. SUCH THAT THE IMPROVEMENTS SHOWN ON THE REMAINING PLANS CAN BE CONSTRUCTED. ALL FACILITIES TO BE REMOVED SHALL BE UNDERCUT TO A SUITABLE MATERIAL AND BROUGHT TO GRADE WITH SUITABLE COMPACTED FILL PER THE FOLLOWING RECOMMENDATIONS:
  - A. AREAS WITHIN NEW BUILDING FOOTPRINT (INCLUDING SIDEWALKS): IMPORTED STRUCTURAL FILL (NYSDOT 304.14 SHALL BE USED TO BACKFILL THESE AREAS PLACED IN LOOSE LIFTS NOT EXCEEDING 12" AND COMPACTED TO THE MAXIMUM DRY DENSITIES NOTED IN THE EARTHWORK NOTES.
  - B. AREAS OUTSIDE NEW BUILDING FOOTPRINT: THESE AREAS MAY BE BACKFILLED WITH SUITABLE ON-SITE MATERIAL PLACED IN LOOSE LIFTS NOT EXCEEDING 12" AND COMPACTED TO THE MAXIMUM DRY DENSITIES NOTED IN THE EARTHWORK NOTES. IN LIEU OF USING SUITABLE ONSITE MATERIAL IN AREAS OUTSIDE THE BUILDING FOOTPRINT AS FILL, NYSDOT ITEM 203.07 (SELECT GRANULAR) FILL MAY BE USED.

THE USE OF ALTERNATE BACKFILL/FILL MATERIALS SHALL BE EVALUATED ON A CASE-BY-CASE BASIS BY THE PROJECT'S GEOTECHNICAL ENGINEER PRIOR TO USE.

- 2. THE CONTRACTOR IS RESPONSIBLE FOR REMOVING ALL DEBRIS FROM THE SITE AND\ DISPOSING OF IT IN A LEGAL MANNER. THE CONTRACTOR IS RESPONSIBLE FOR OBTAINING ALL PERMITS REQUIRED FOR DEMOLITION AND DISPOSAL.
- 3. THE CONTRACTOR SHALL MAINTAIN ALL UTILITY SERVICES TO ANY EXISTING BUILDING/FACILITY TO REMAIN AT ALL TIMES.
- 4. THE CONTRACTOR SHALL COORDINATE WITH THE RESPECTIVE UTILITY COMPANIES PRIOR TO THE REMOVAL AND RELOCATION OF ANY UTILITIES. THE CONTRACTOR SHALL COORDINATE WITH THE UTILITY COMPANY CONCERNING PORTIONS OF WORK WHICH MAY BE PERFORMED BY THE UTILITY COMPANY AND ANY FEES WHICH ARE TO BE PAID TO THE UTILITY COMPANY FOR SUCH SERVICES. THE CONTRACTOR IS RESPONSIBLE FOR PAYING ALL FEES AND CHARGES.
- 5. THIS PLAN DOES NOT SHOW ALL ITEMS TO BE DEMOLISHED, ABANDONED AND/OR REMOVED. EXISTING STRUCTURES WITHIN THE CONSTRUCTION LIMITS ARE TO BE ABANDONED, REMOVED, OR RELOCATED AS NECESSARY, UNLESS SPECIFIED OTHERWISE. ALL COSTS SHALL BE INCLUDED IN BASE BID.
- 6. THE CONTRACTOR ACCEPTS ALL RESPONSIBILITY OF SALVAGED MATERIALS.
- 7. THE CONTRACTOR SHALL BE RESPONSIBLE FOR THE DISCONNECTION OF UTILITY SERVICES TO THE EXISTING BUILDING PRIOR TO DEMOLITION.
- 8. ALL UTILITIES WITHIN PROPOSED BUILDING FOOTPRINTS (INCLUDING 5 FEET BEYOND THE PERIMETER) SHALL BE REMOVED AND THE EXCAVATION AREA SHALL BE BACKFILLED AND COMPACTED PER THE CONSTRUCTION DOCUMENTS.
- 9. THE CONTRACTOR SHALL FILL ALL ABANDONED UTILITY PIPES AND STRUCTURES WITH CONTROL DENSITY FILL. ALL ABANDONED PIPES AND STRUCTURES WITHIN 2' OF PROPOSED FINISHED GRADE SHALL BE REMOVED UNLESS SPECIFIED OTHERWISE. AT MANHOLES AND STRUCTURES TO REMAIN, ABANDONED PIPES SHALL BE CUT AND PLUGGED AND THE REMAINING OPENING IN THE MANHOLE/STRUCTURE SHALL BE FILLED SO TO MATCH THE REMAINING STRUCTURE/MANHOLE. THE CONTRACTOR HAS THE OPTION TO REMOVE THOSE UTILITIES TO BE ABANDONED AT NO ADDITIONAL COST TO THE OWNER.
- 10. REMOVAL OR ABANDONMENT OF UTILITIES, DRIVEWAYS, STRUCTURES, ETC. SHALL ONLY BE PERFORMED AFTER CRITICAL NEW OR TEMPORARY INFRASTRUCTURE IS IN PLACE AND OPERATIONAL (I.E. UTILITIES, DRAINAGE, PAVING, ACCESSIBLE PARKING, ETC.). THE CONTRACTOR IS RESPONSIBLE FOR PROVIDING PROPER AND SAFE SEQUENCING.
- 11. THE CONTRACTOR IS RESPONSIBLE FOR ALL RELOCATIONS, INCLUDING BUT NOT LIMITED TO ALL UTILITIES, STORM DRAINAGE, SIGNS, ETC. AS REQUIRED. ALL WORK SHALL BE IN ACCORDANCE WITH THE GOVERNING AUTHORITY'S SPECIFICATIONS AND SHALL BE APPROVED BY THE AUTHORITY PRIOR TO THE START OF WORK. COSTS FOR SUCH RELOCATIONS SHALL BE INCLUDED IN THE BASE BID.
- 12. THE CONTRACTOR SHALL VERIFY OVERHEAD UTILITY ELEVATIONS TO AVOID CONFLICTS.
- 13. CONTRACTOR IS RESPONSIBLE FOR COORDINATING WITH THE ELECTRICAL, TELEPHONE, CABLE, WATER, FIBER OPTIC, AND/OR GAS LINES NEEDING RELOCATION OR REMOVAL. ADEQUATE TIME SHALL BE PROVIDED FOR RELOCATION AND CLOSE COORDINATION WITH THE UTILITY COMPANY IS NECESSARY IN AN EFFORT TO PROVIDE A SMOOTH TRANSITION IN UTILITY SERVICE.
- 14. THE CONTRACTOR IS RESPONSIBLE FOR ALL TEMPORARY SERVICES INCLUDING BUT NOT LIMITED TO: GAS, ELECTRIC, TELEPHONE, STORM DRAINAGE, SANITARY SEWAGE, COMMUNICATIONS, HEAT, ETC. THROUGHOUT ALL PHASES OF CONSTRUCTION. COSTS FOR SUCH TEMPORARY SERVICES SHALL BE INCLUDED IN THE BASE BID.
- 15. THE CONTRACTOR MUST PROTECT THE PUBLIC AT ALL TIMES WITH FENCING, BARRICADES, ENCLOSURES, ETC. AS REQUIRED BY THE OWNER, TOWN OF DRYDEN, AND/OR THE ENGINEER.
- 16. THE CONTRACTOR SHALL MAINTAIN ACCESS TO THE SURROUNDING PROPERTIES AT ALL TIMES DURING DEMOLITION OF EXISTING FACILITIES AND CONSTRUCTION OF NEW SITE/BUILDING IMPROVEMENTS.

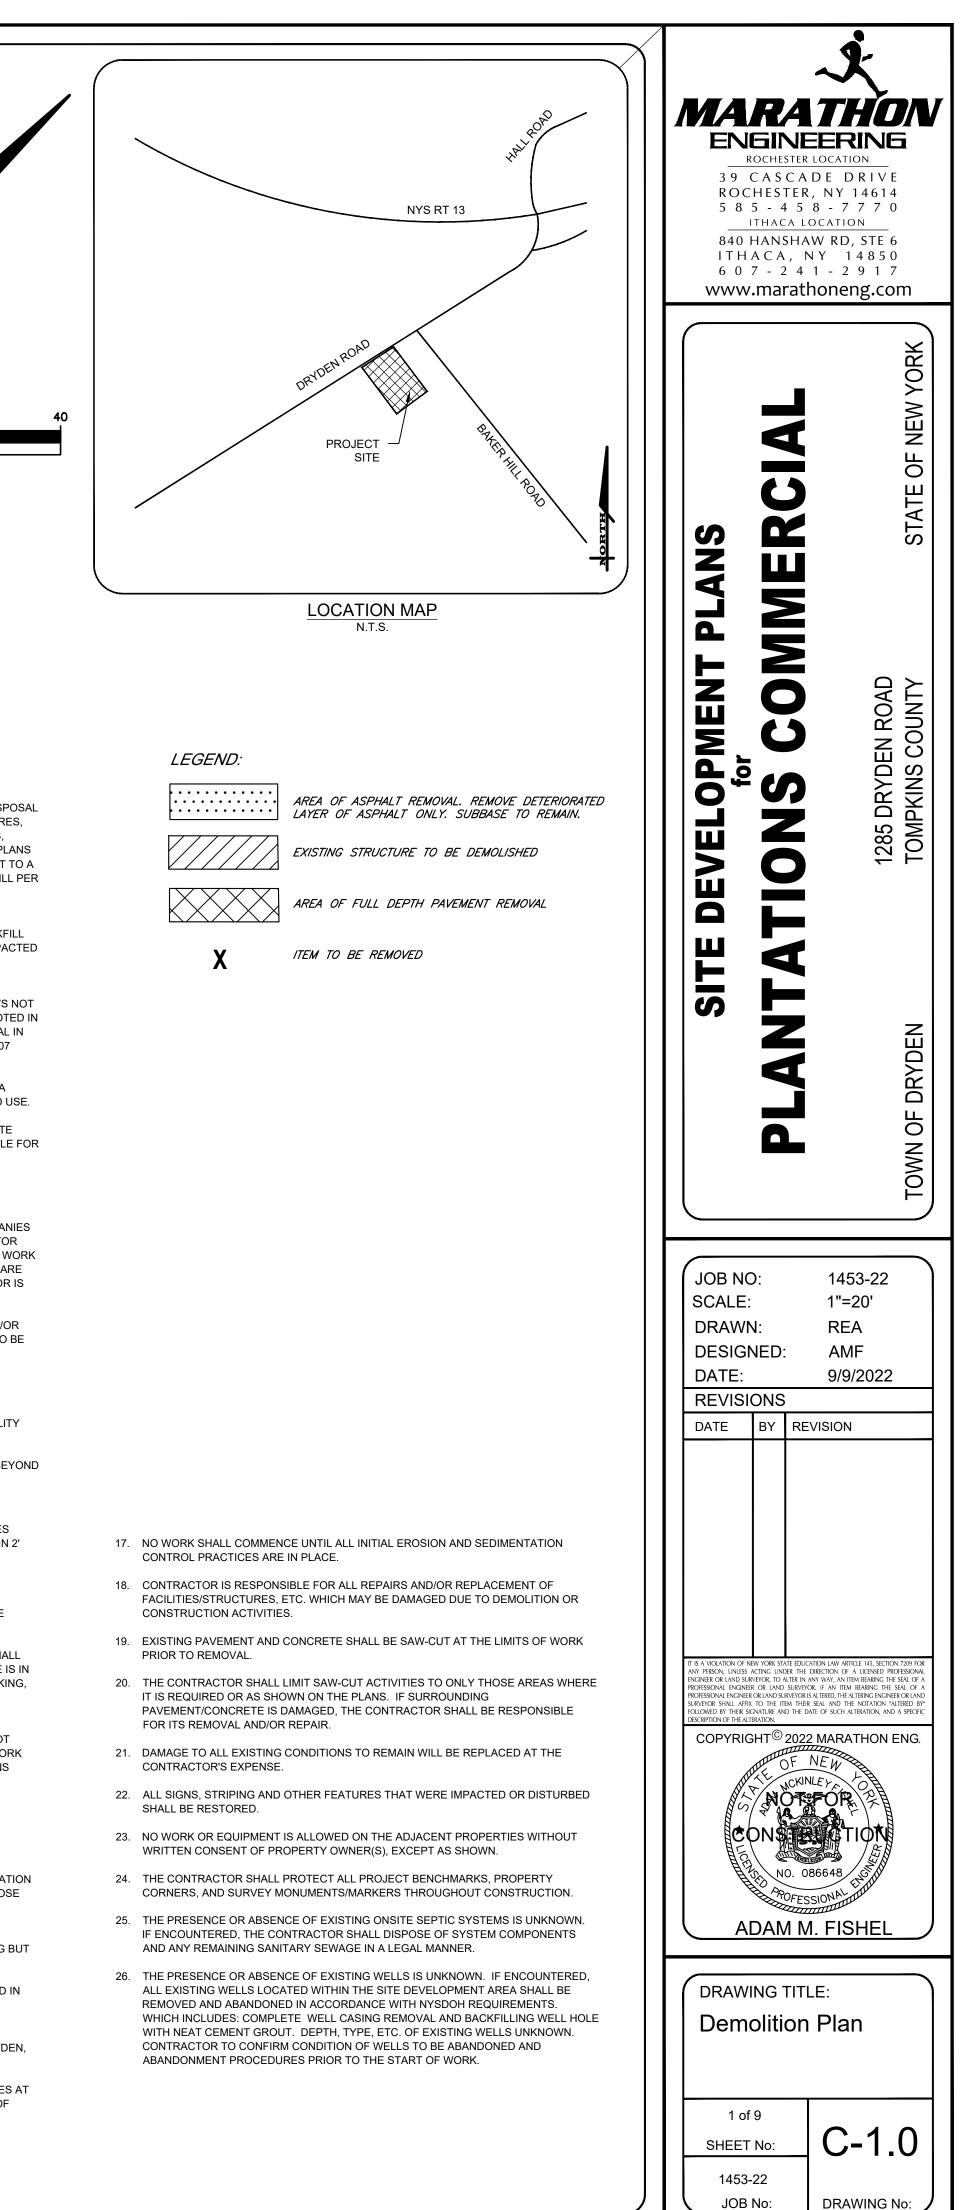

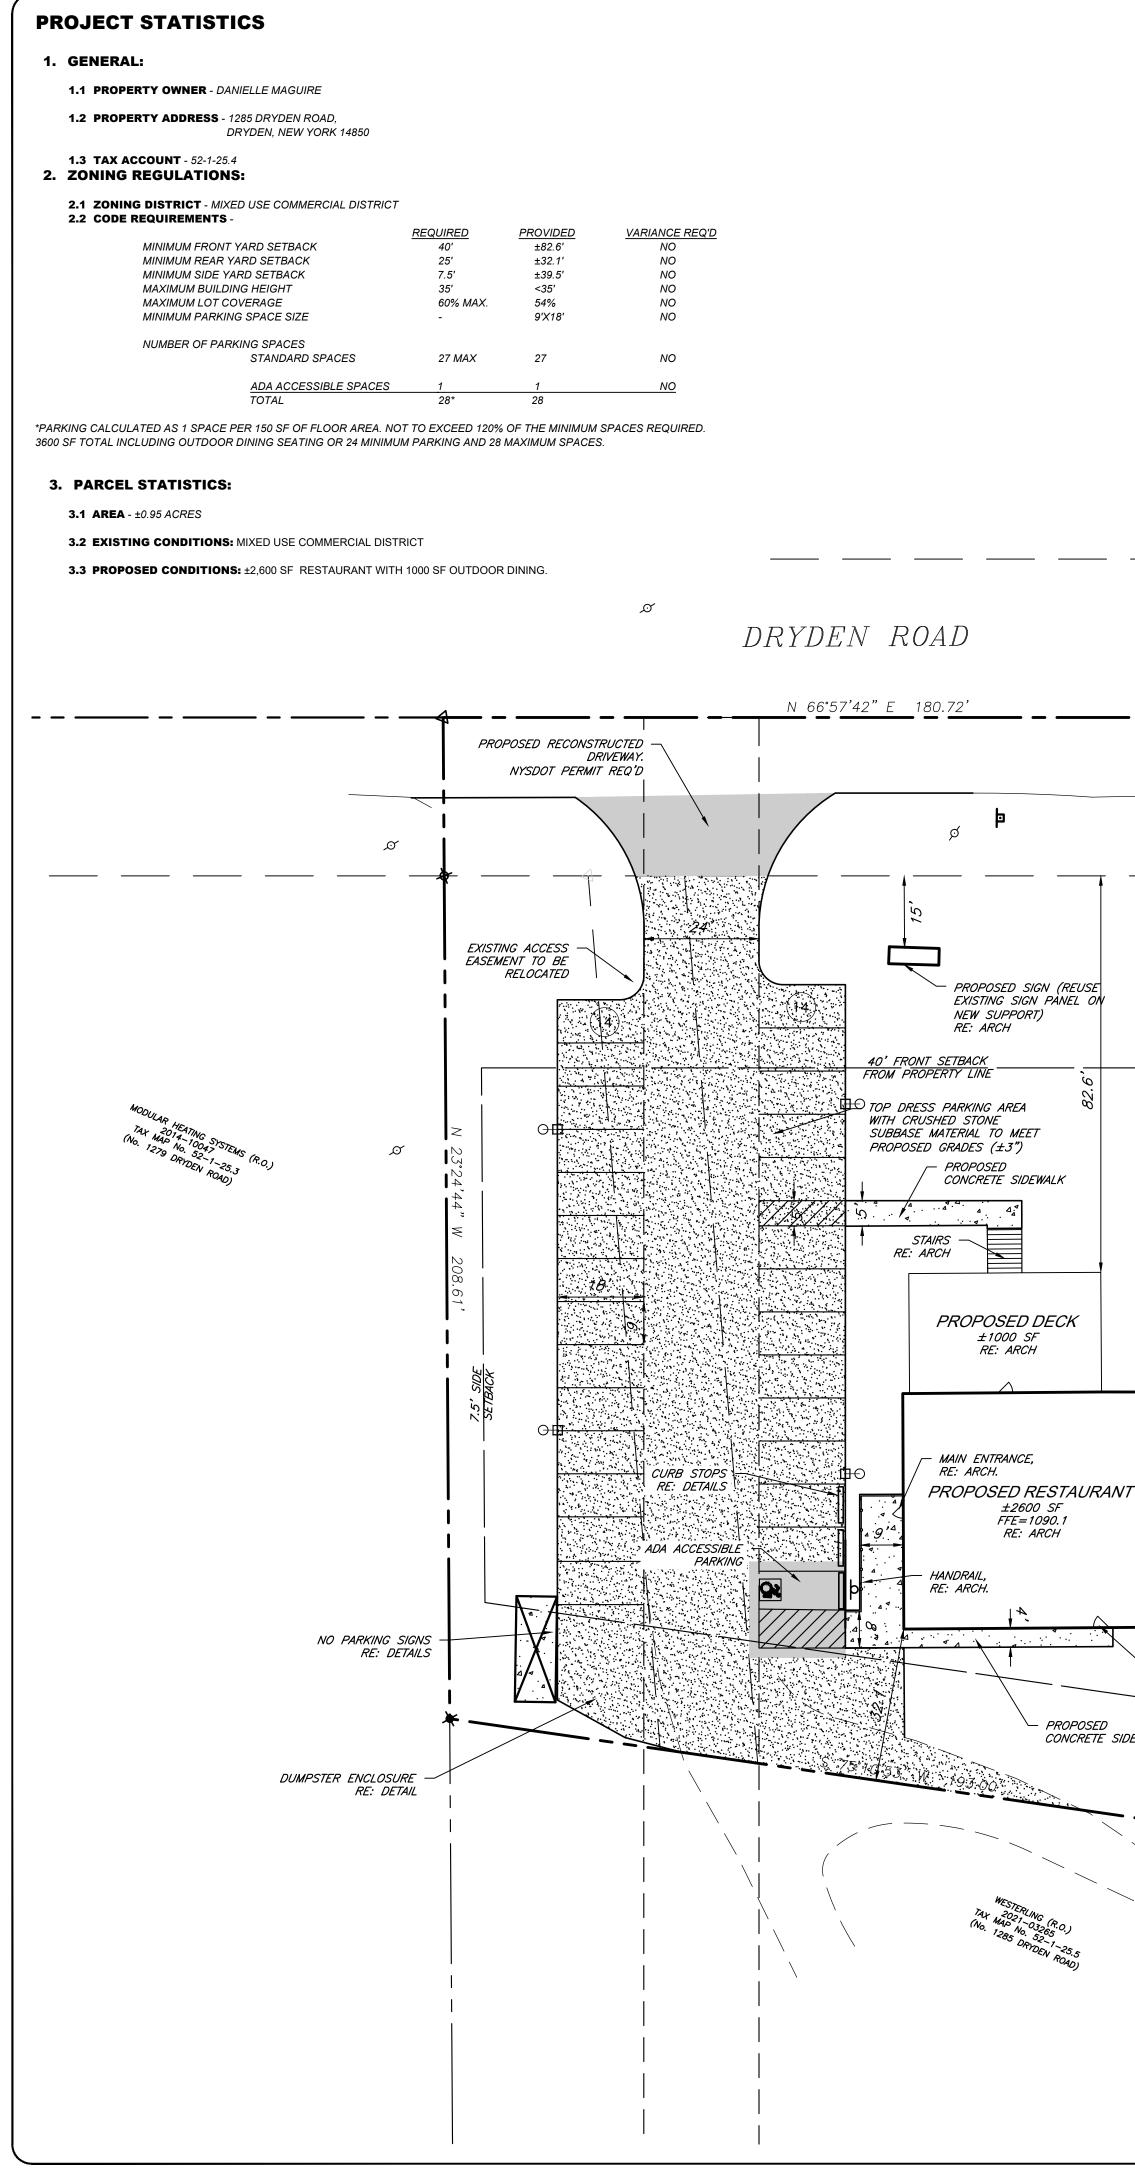

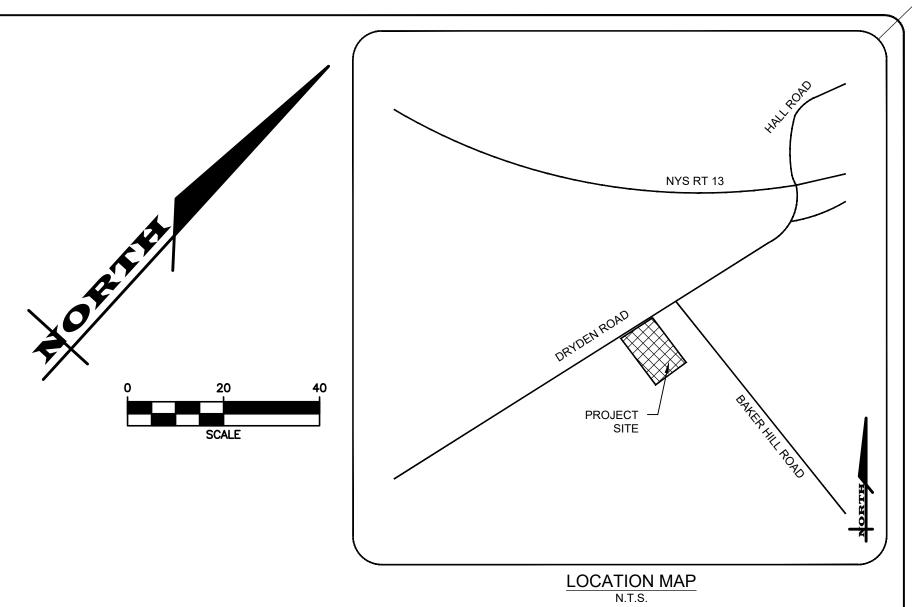

# GENERAL OWNER. FEES. 39.5' RECEIVING ENTRANCE, RE: ARCH. EAR ETBACK CONCRETE SIDEWALK

**1. APPLICABILITY** - THE NOTES AND INFORMATION PROVIDED ON THIS SHEET ARE APPLICABLE TO ALL "C" SERIES DRAWINGS. THE "C" SERIES DRAWINGS COVER SITE RELATED IMPROVEMENTS OUTSIDE THE BUILDING ENVELOPE. THE BUILDING ENVELOPE INCLUDES ALL AREA WITHIN 5' OUTSIDE OF THE BUILDING'S EXTERIOR WALL.

**2. MAPPING** - THE EXISTING UNDERGROUND UTILITIES WERE PLOTTED BASED ON RECORD MAPPING SUPPLIED BY OTHERS. THE ENGINEER MAKES NO WARRANTY AS TO THE LOCATION, SIZE, TYPE, ELEVATION, AND/OR NUMBER OF EXISTING UTILITIES. THE CONTRACTOR SHALL BE RESPONSIBLE FOR DETERMINING THE HORIZONTAL AND VERTICAL LOCATION OF UTILITIES IN THE VICINITY OF THE NEW INFRASTRUCTURE.

3. STAKEOUT - THE CONTRACTOR SHALL NOTIFY U DIG NEW YORK (1-800-962-7962) FOR A UTILITY STAKEOUT 48 HOURS IN ADVANCE OF COMMENCING WORK. STAKEOUT OF PRIVATE UTILITIES SHALL BE COORDINATED WITH THE

**4. PROPERTY PROTECTION** - THE CONTRACTOR IS RESPONSIBLE FOR DAMAGE TO EXISTING PAVEMENT, CURBS, WALKS, LAWNS, TREES, ETC. CAUSED BY THEIR CONSTRUCTION OPERATIONS. ALL DAMAGE SHALL BE REPAIRED OR REPLACED BY THE CONTRACTOR TO THE OWNER'S SATISFACTION AT NO ADDITIONAL EXPENSE.

5. ACCESS - THE CONTRACTOR SHALL PROVIDE SATISFACTORY VEHICULAR ACCESS TO ALL ADJOINING PROPERTIES, PRIVATE ROADWAYS, PARKING FACILITIES, AND PUBLIC STREETS DURING CONSTRUCTION.

6. SITE SAFETY - PRIOR TO AND THROUGHOUT CONSTRUCTION, THE CONTRACTOR SHALL POST SIGNAGE IN CONFORMANCE WITH THE REQUIREMENTS OF THE LOCAL MUNICIPALITY AND OCCUPATIONAL HEALTH AND SAFETY ACT (OHSA). JOB SAFETY AND MAINTENANCE AND PROTECTION OF TRAFFIC IS THE RESPONSIBILITY OF THE CONTRACTOR.

7. EXCAVATIONS - ALL EXCAVATIONS SHALL BE BACKFILLED/BARRICADED TO THE SATISFACTION OF THE OWNER'S REPRESENTATIVE AT THE CONCLUSION OF EACH WORKING DAY.

8. MAINTENANCE - PUBLIC STREETS, PRIVATE DRIVES AND PARKING FACILITIES SHALL BE KEPT FREE OF FOREIGN MATERIALS. ALL AREAS SHALL BE SWEPT CLEAN AT THE END OF EACH WORKING DAY AND/OR AS DIRECTED BY THE OWNER'S ON-SITE REPRESENTATIVE.

9. CONSTRUCTION STORAGE - STORAGE OF EQUIPMENT AND MATERIALS SHALL BE WITHIN A SPECIFIED AND SECURED AREA AS DETERMINED IN CONTRACT DOCUMENTS OR AS SPECIFIED BY THE OWNER'S ON-SITE REPRESENTATIVE.

10. PERMIT(S) - PRIOR TO CONSTRUCTION, THE CONTRACTOR SHALL OBTAIN THE NECESSARY PERMITS FROM THE APPLICABLE MUNICIPALITY OR AGENCY. UNLESS SPECIFIED OTHERWISE, THE OWNER IS RESPONSIBLE FOR PERMIT

**11. SPECIFICATIONS** - TECHNICAL SPECIFICATIONS, IF SUPPLIED AS PART OF CONTRACT DOCUMENTS, ARE INTENDED TO AID AND HELP DEFINE THE CONTRACTOR'S WORK SCOPE. IF DISCREPANCIES OCCUR THE CONTRACTOR SHALL REQUEST A CLARIFICATION.

# CONSTRUCTION

**1. STAKEOUT** - THE CONSTRUCTION STAKEOUT SHALL BE PERFORMED BY A LICENSED LAND SURVEYOR USING CONTROL PROVIDED ON THE "LAYOUT PLAN". THE BUILDING FOOTPRINT(S) SHOWN IS BASED ON THE FOUNDATION PLAN PROVIDED BY CLAUDIA BRENNER ON 2/16/22. DISCREPANCIES WITH BUILDING(S), CONTROL POINTS, AND/ OR TIE DIMENSIONS SHALL BE REPORTED TO THE DESIGN ENGINEER (PRIOR TO THE INSTALLATION OF IMPROVEMENTS) FOR COORDINATION AND CLARIFICATION.

2. LAYOUT - DIMENSIONS SHOWN, WHERE APPLICABLE, SHALL BE FROM THE FACE OF CURB UNLESS SPECIFICALLY CALLED OUT OTHERWISE.

**3. DEMOLITION** - CLEARING AND GRUBBING SHALL BE LIMITED TO THE SITE BOUNDARIES OR WITHIN THE "LIMIT OF DISTURBANCE" AS DEFINED ON THE PLAN. TREES AND OBJECTS DESIGNATED FOR REMOVAL SHALL BE COORDINATED AND FIELD VERIFIED WITH PROJECT ON-SITE REPRESENTATIVE. ALL MATERIALS SHALL BE LEGALLY DISPOSED OF OFF-SITE OR RETURNED TO OWNER AS DIRECTED BY CONTRACT DOCUMENTS. ALL ITEMS NOT SPECIFICALLY CALLED OUT TO BE REMOVED SHALL REMAIN.

**4. COORDINATION** - THE CONTRACTOR SHALL COORDINATE INSTALLATION OF UTILITY WORK WITH OTHER SITE UTILITIES (I.E. GAS, ELECTRIC, LIGHTING, COMMUNICATIONS) TO AVOID POTENTIAL INSTALLATION CONFLICTS.

5. STAGING - AS DEFINED BY THE CONTRACT DOCUMENTS THE CONTRACTOR SHALL CONSTRUCT A SECURE STAGING AREA FOR STORAGE OF EQUIPMENT, MATERIALS, EMPLOYEE PARKING AND OFFICE SPACE. IF THE AREA/METHOD IS NOT SPECIFICALLY DEFINED ON THE DOCUMENTS THEN IT SHALL BE COORDINATED WITH THE OWNER'S ON-SITE REPRESENTATIVE.


6. CLOSE-OUT - THE CONTRACTOR'S WORK SCOPE INCLUDES BUT IS NOT LIMITED TO THE FOLLOWING AT PROJECT CLOSE-OUT TO THE SATISFACTION OF OWNER'S ON-SITE REPRESENTATIVE:


• REMOVAL OF ANY CONSTRUCTION DEBRIS. • CLEANING PAVEMENT AND WALKWAY SURFACES.

• RESTORATION OF ALL DISTURBED GRASS AND LANDSCAPED AREAS. • PROVIDING BONDS, GUARANTEES, CERTIFICATIONS, ETC. AS REQUIRED


BY CONTRACT DOCUMENTS. PROVIDING A RECORD DRAWING.

COMPLETION OF FINAL PUNCH LIST ITEMS.

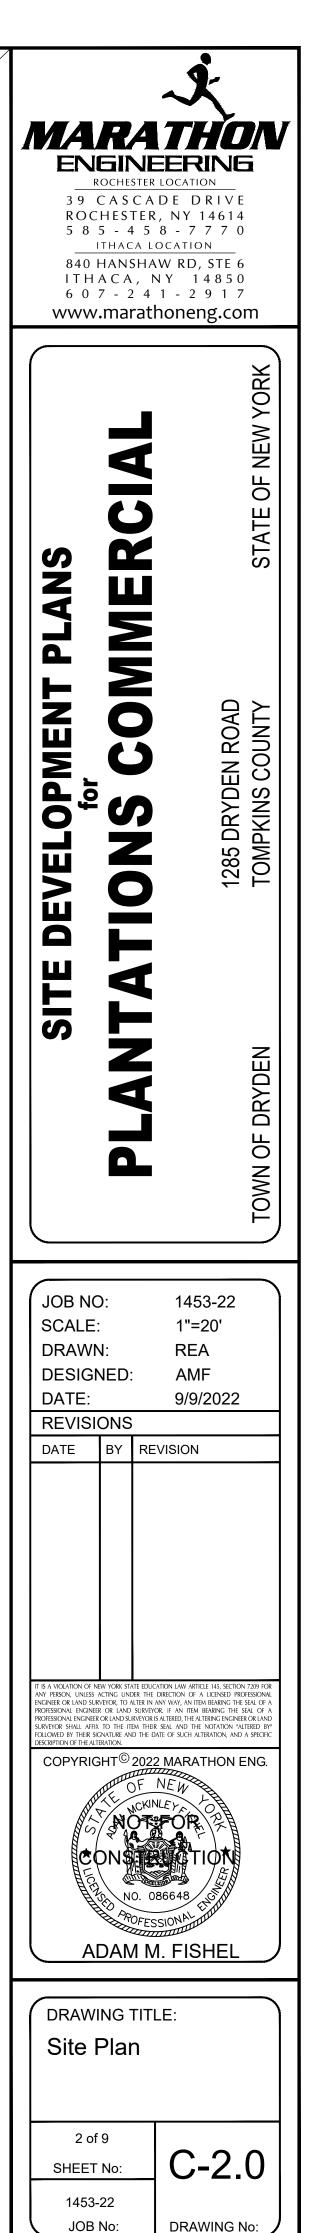

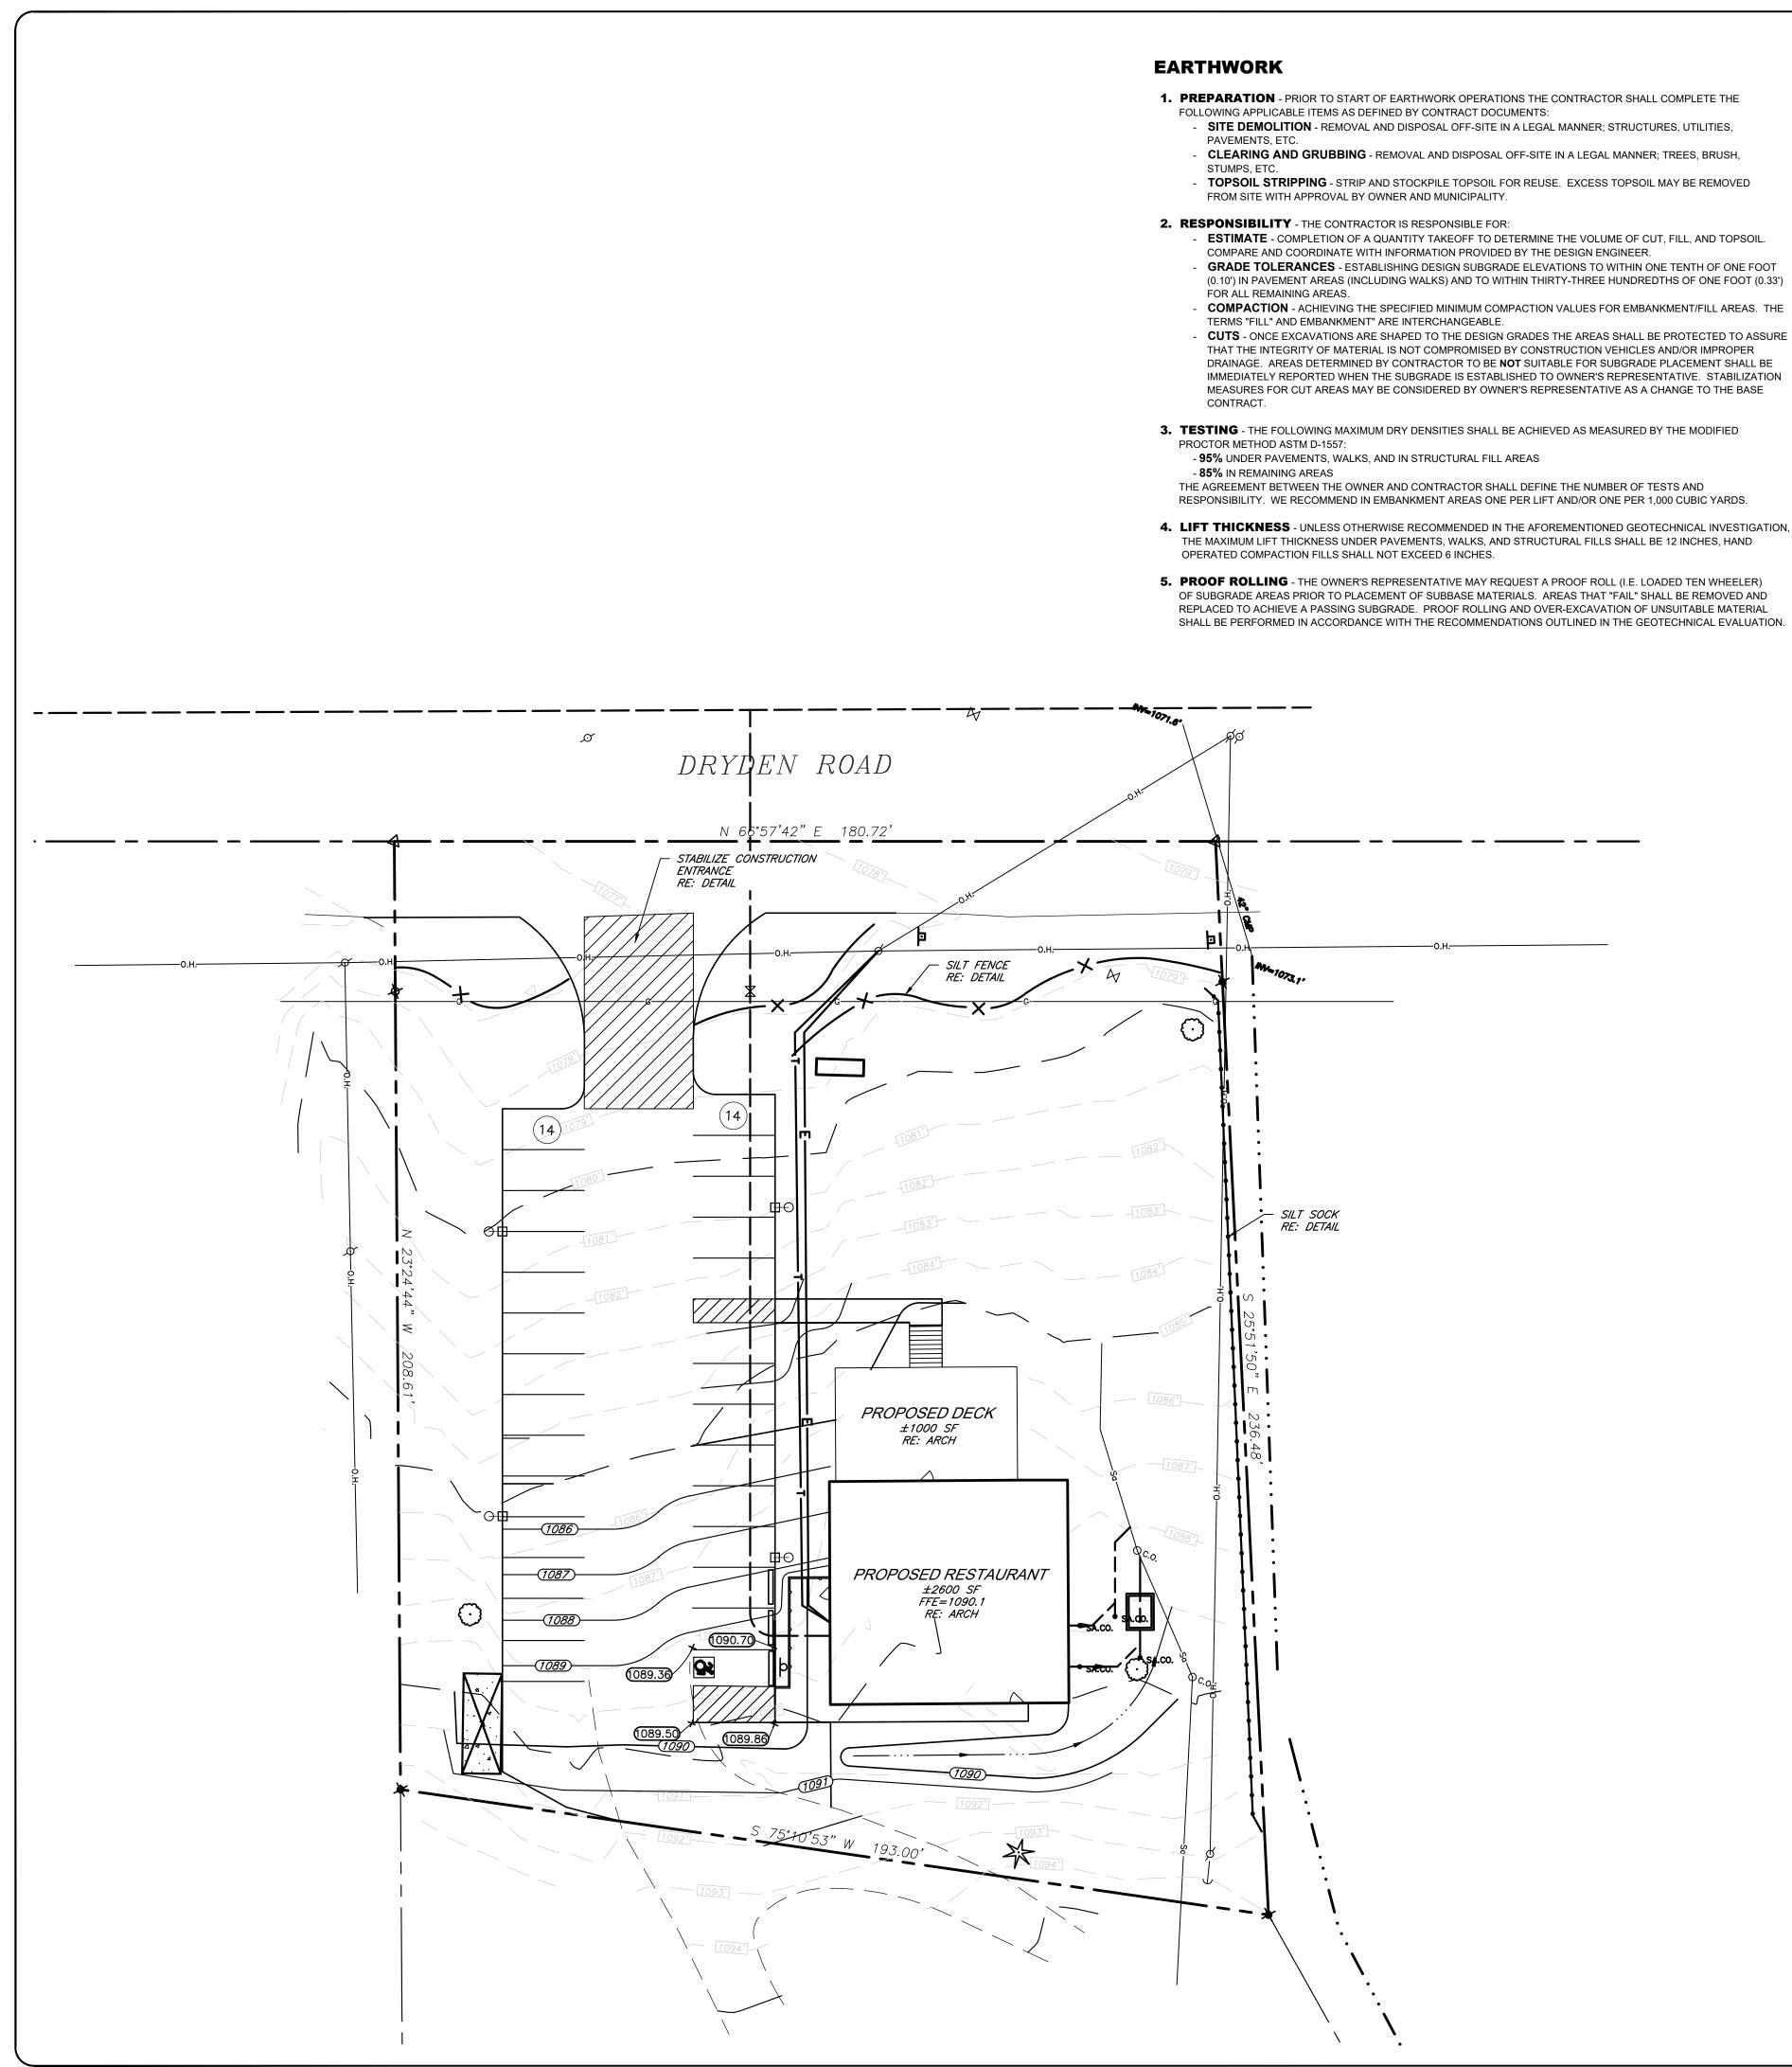



- **1. PREPARATION** PRIOR TO START OF EARTHWORK OPERATIONS THE CONTRACTOR SHALL COMPLETE THE FOLLOWING APPLICABLE ITEMS AS DEFINED BY CONTRACT DOCUMENTS:
  - CLEARING AND GRUBBING REMOVAL AND DISPOSAL OFF-SITE IN A LEGAL MANNER; TREES, BRUSH,
  - **TOPSOIL STRIPPING** STRIP AND STOCKPILE TOPSOIL FOR REUSE. EXCESS TOPSOIL MAY BE REMOVED
- ESTIMATE COMPLETION OF A QUANTITY TAKEOFF TO DETERMINE THE VOLUME OF CUT, FILL, AND TOPSOIL. COMPARE AND COORDINATE WITH INFORMATION PROVIDED BY THE DESIGN ENGINEER. **GRADE TOLERANCES** - ESTABLISHING DESIGN SUBGRADE ELEVATIONS TO WITHIN ONE TENTH OF ONE FOOT (0.10') IN PAVEMENT AREAS (INCLUDING WALKS) AND TO WITHIN THIRTY-THREE HUNDREDTHS OF ONE FOOT (0.33')
- COMPACTION ACHIEVING THE SPECIFIED MINIMUM COMPACTION VALUES FOR EMBANKMENT/FILL AREAS. THE
- THAT THE INTEGRITY OF MATERIAL IS NOT COMPROMISED BY CONSTRUCTION VEHICLES AND/OR IMPROPER DRAINAGE. AREAS DETERMINED BY CONTRACTOR TO BE **NOT** SUITABLE FOR SUBGRADE PLACEMENT SHALL BE IMMEDIATELY REPORTED WHEN THE SUBGRADE IS ESTABLISHED TO OWNER'S REPRESENTATIVE. STABILIZATION MEASURES FOR CUT AREAS MAY BE CONSIDERED BY OWNER'S REPRESENTATIVE AS A CHANGE TO THE BASE
- 3. TESTING THE FOLLOWING MAXIMUM DRY DENSITIES SHALL BE ACHIEVED AS MEASURED BY THE MODIFIED
- RESPONSIBILITY. WE RECOMMEND IN EMBANKMENT AREAS ONE PER LIFT AND/OR ONE PER 1,000 CUBIC YARDS.
- 4. LIFT THICKNESS UNLESS OTHERWISE RECOMMENDED IN THE AFOREMENTIONED GEOTECHNICAL INVESTIGATION, THE MAXIMUM LIFT THICKNESS UNDER PAVEMENTS, WALKS, AND STRUCTURAL FILLS SHALL BE 12 INCHES, HAND
- 5. PROOF ROLLING THE OWNER'S REPRESENTATIVE MAY REQUEST A PROOF ROLL (I.E. LOADED TEN WHEELER) OF SUBGRADE AREAS PRIOR TO PLACEMENT OF SUBBASE MATERIALS. AREAS THAT "FAIL" SHALL BE REMOVED AND REPLACED TO ACHIEVE A PASSING SUBGRADE. PROOF ROLLING AND OVER-EXCAVATION OF UNSUITABLE MATERIAL SHALL BE PERFORMED IN ACCORDANCE WITH THE RECOMMENDATIONS OUTLINED IN THE GEOTECHNICAL EVALUATION.

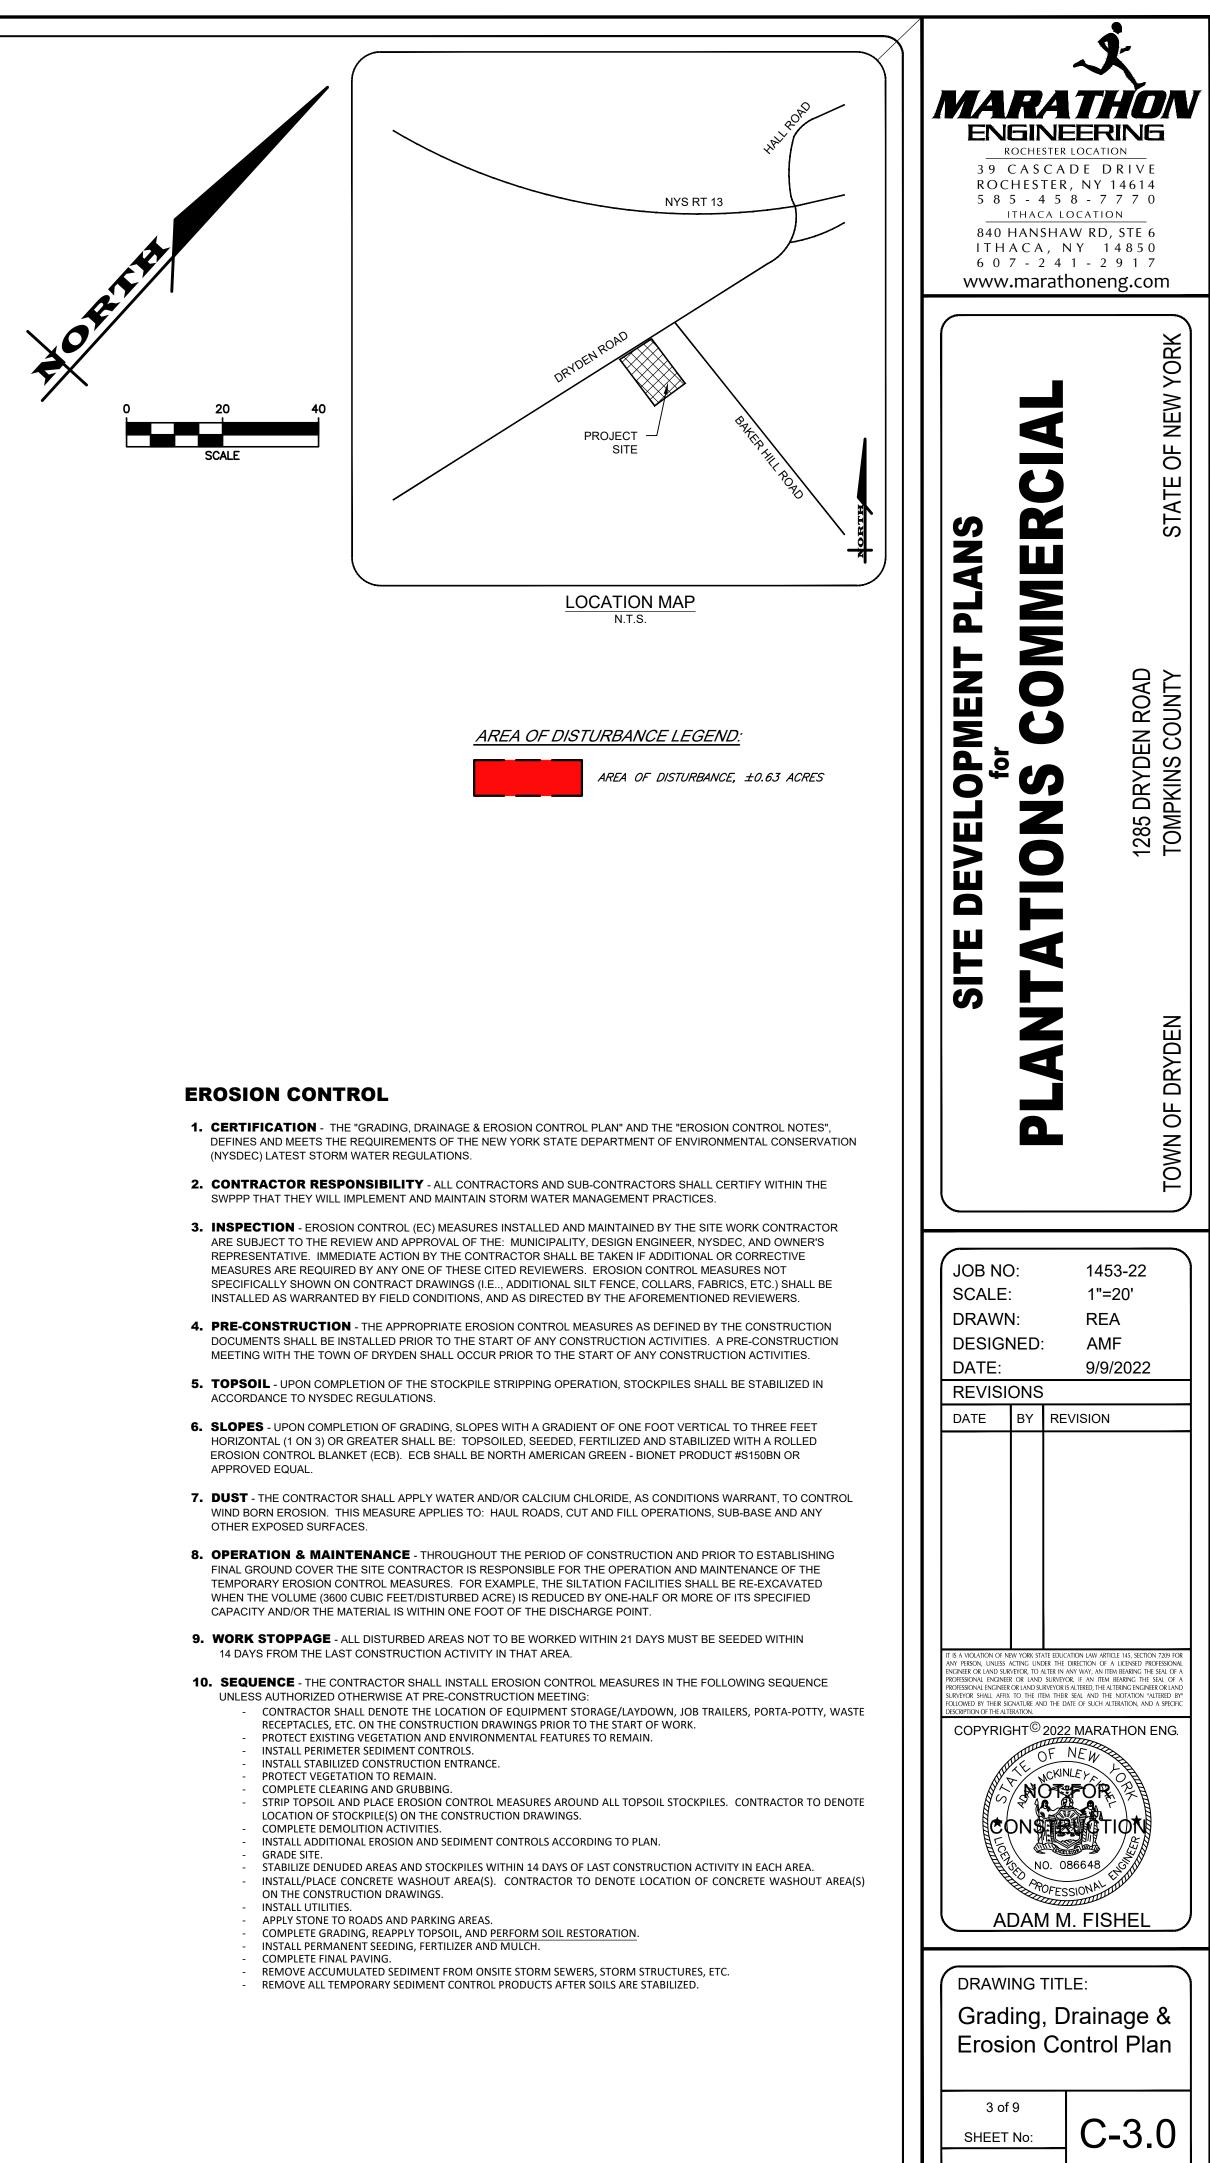



1453-22 JOB No:

DRAWING No:

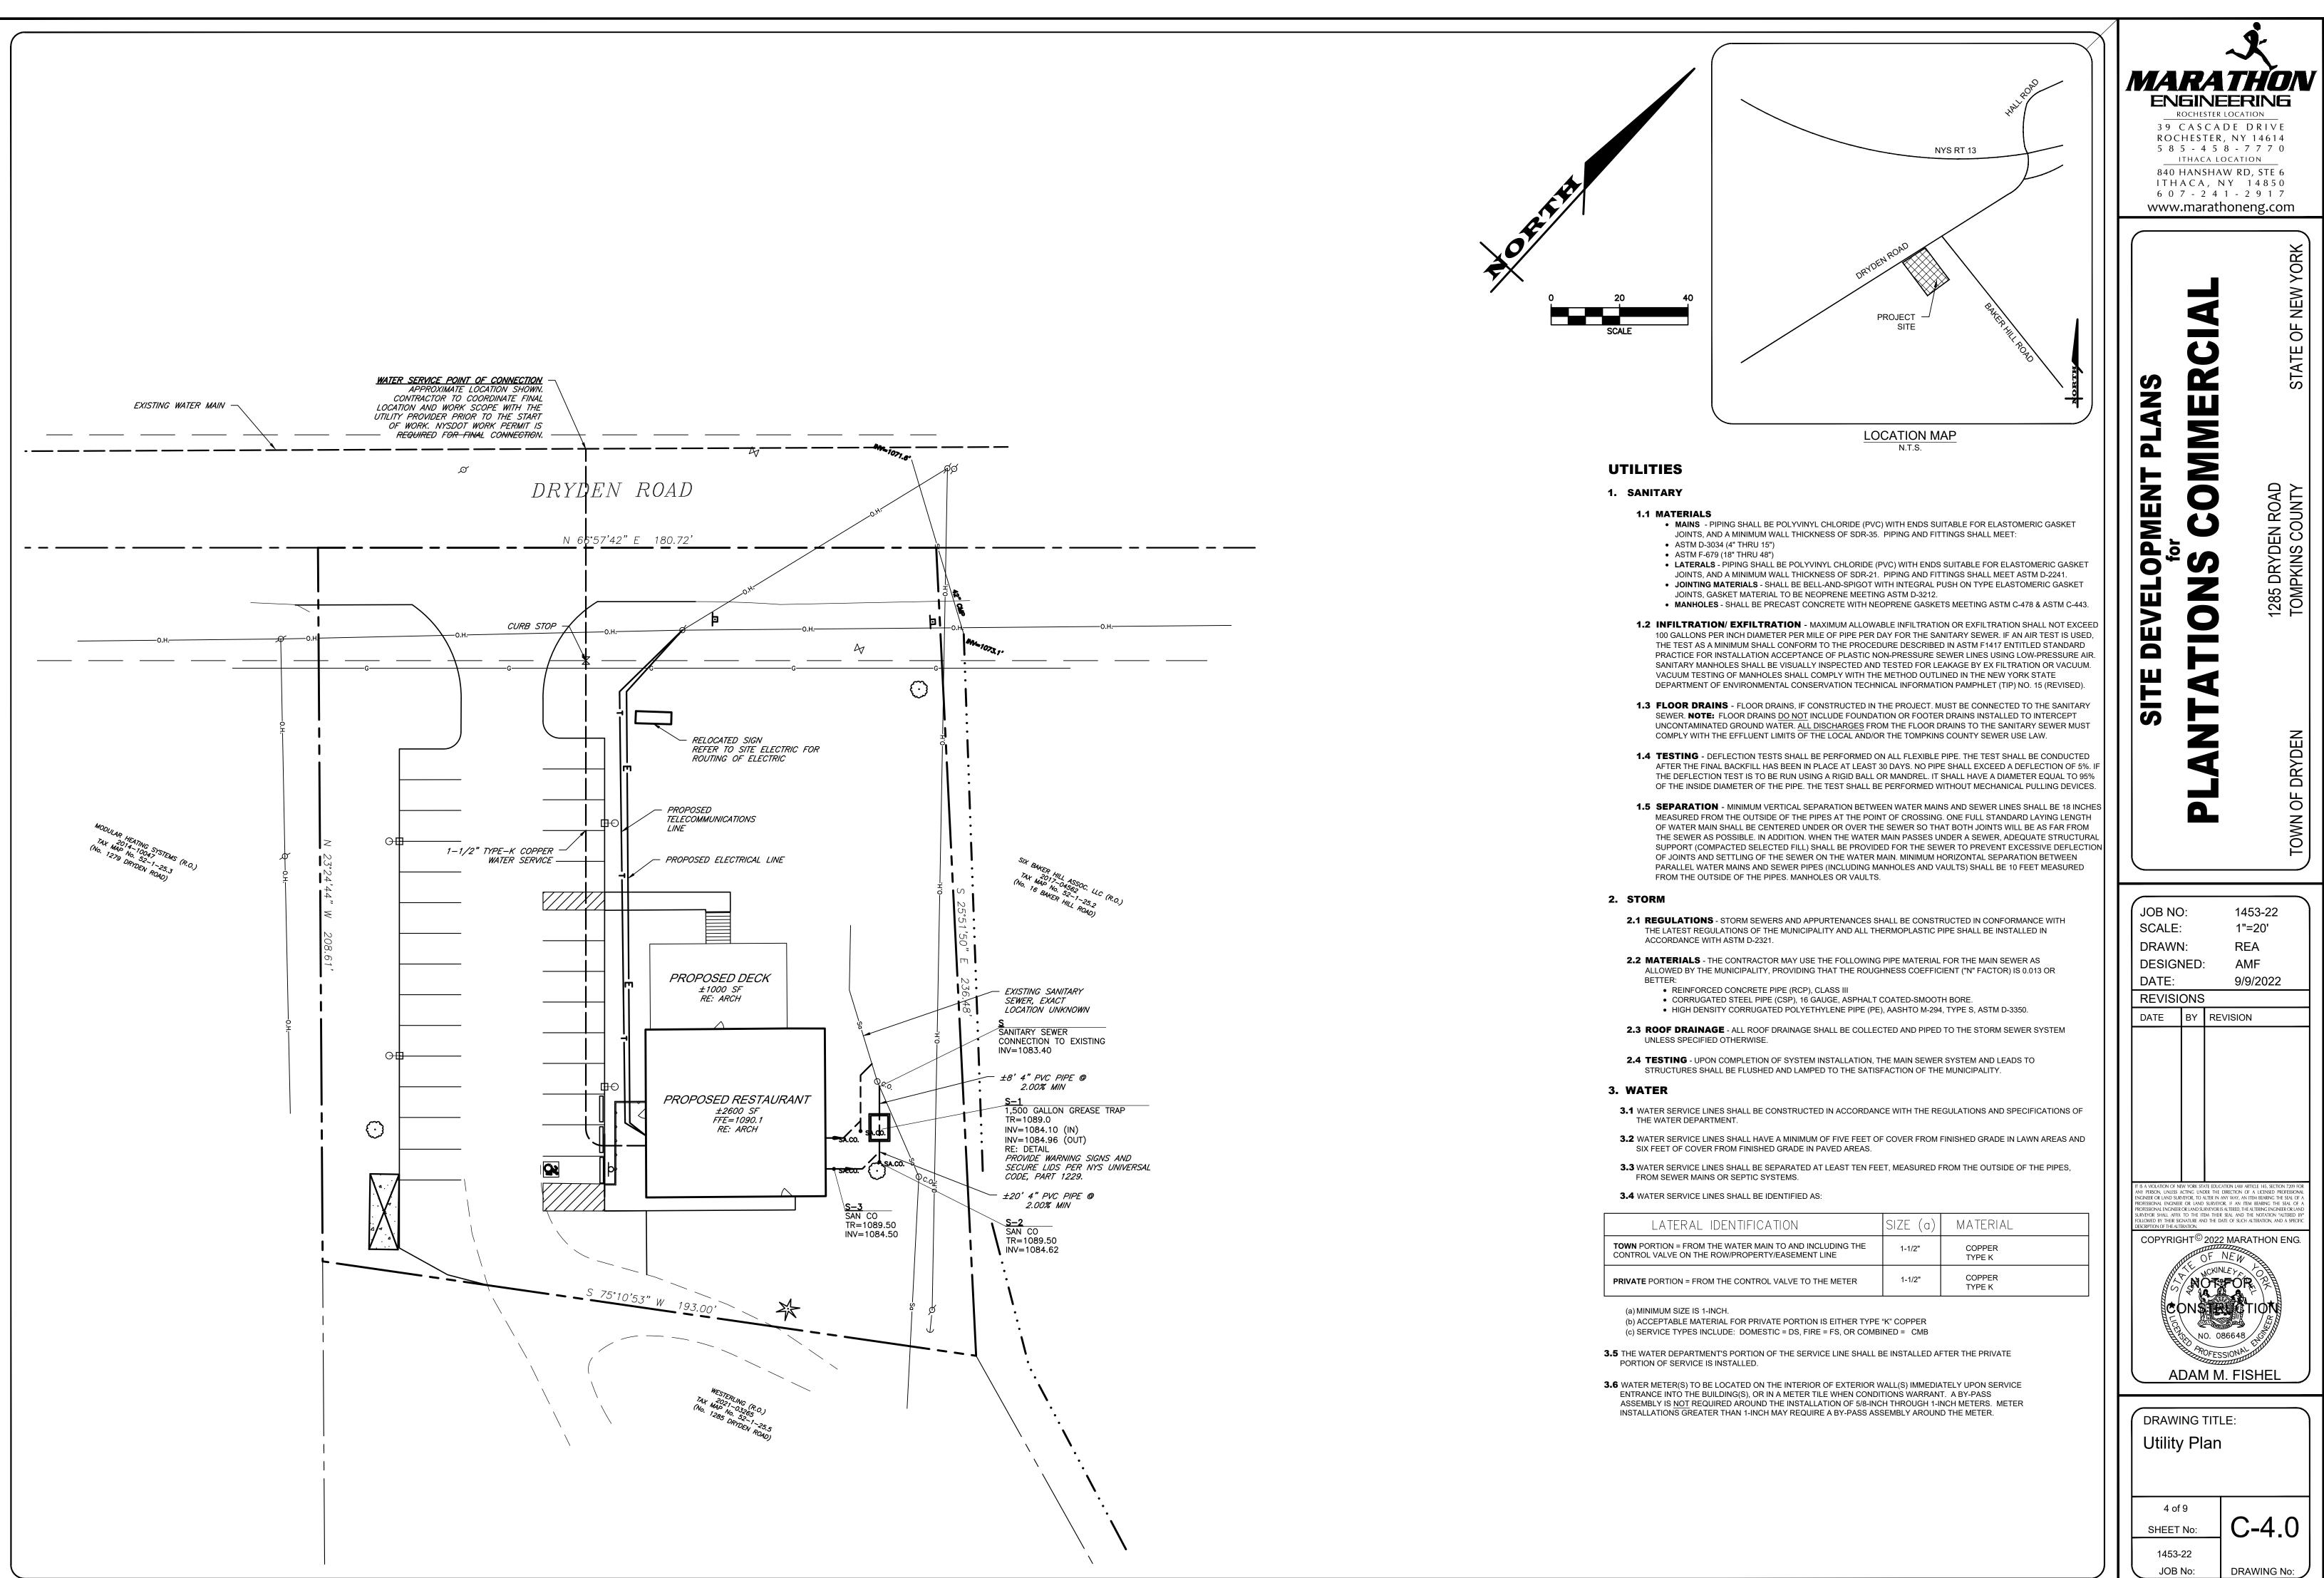

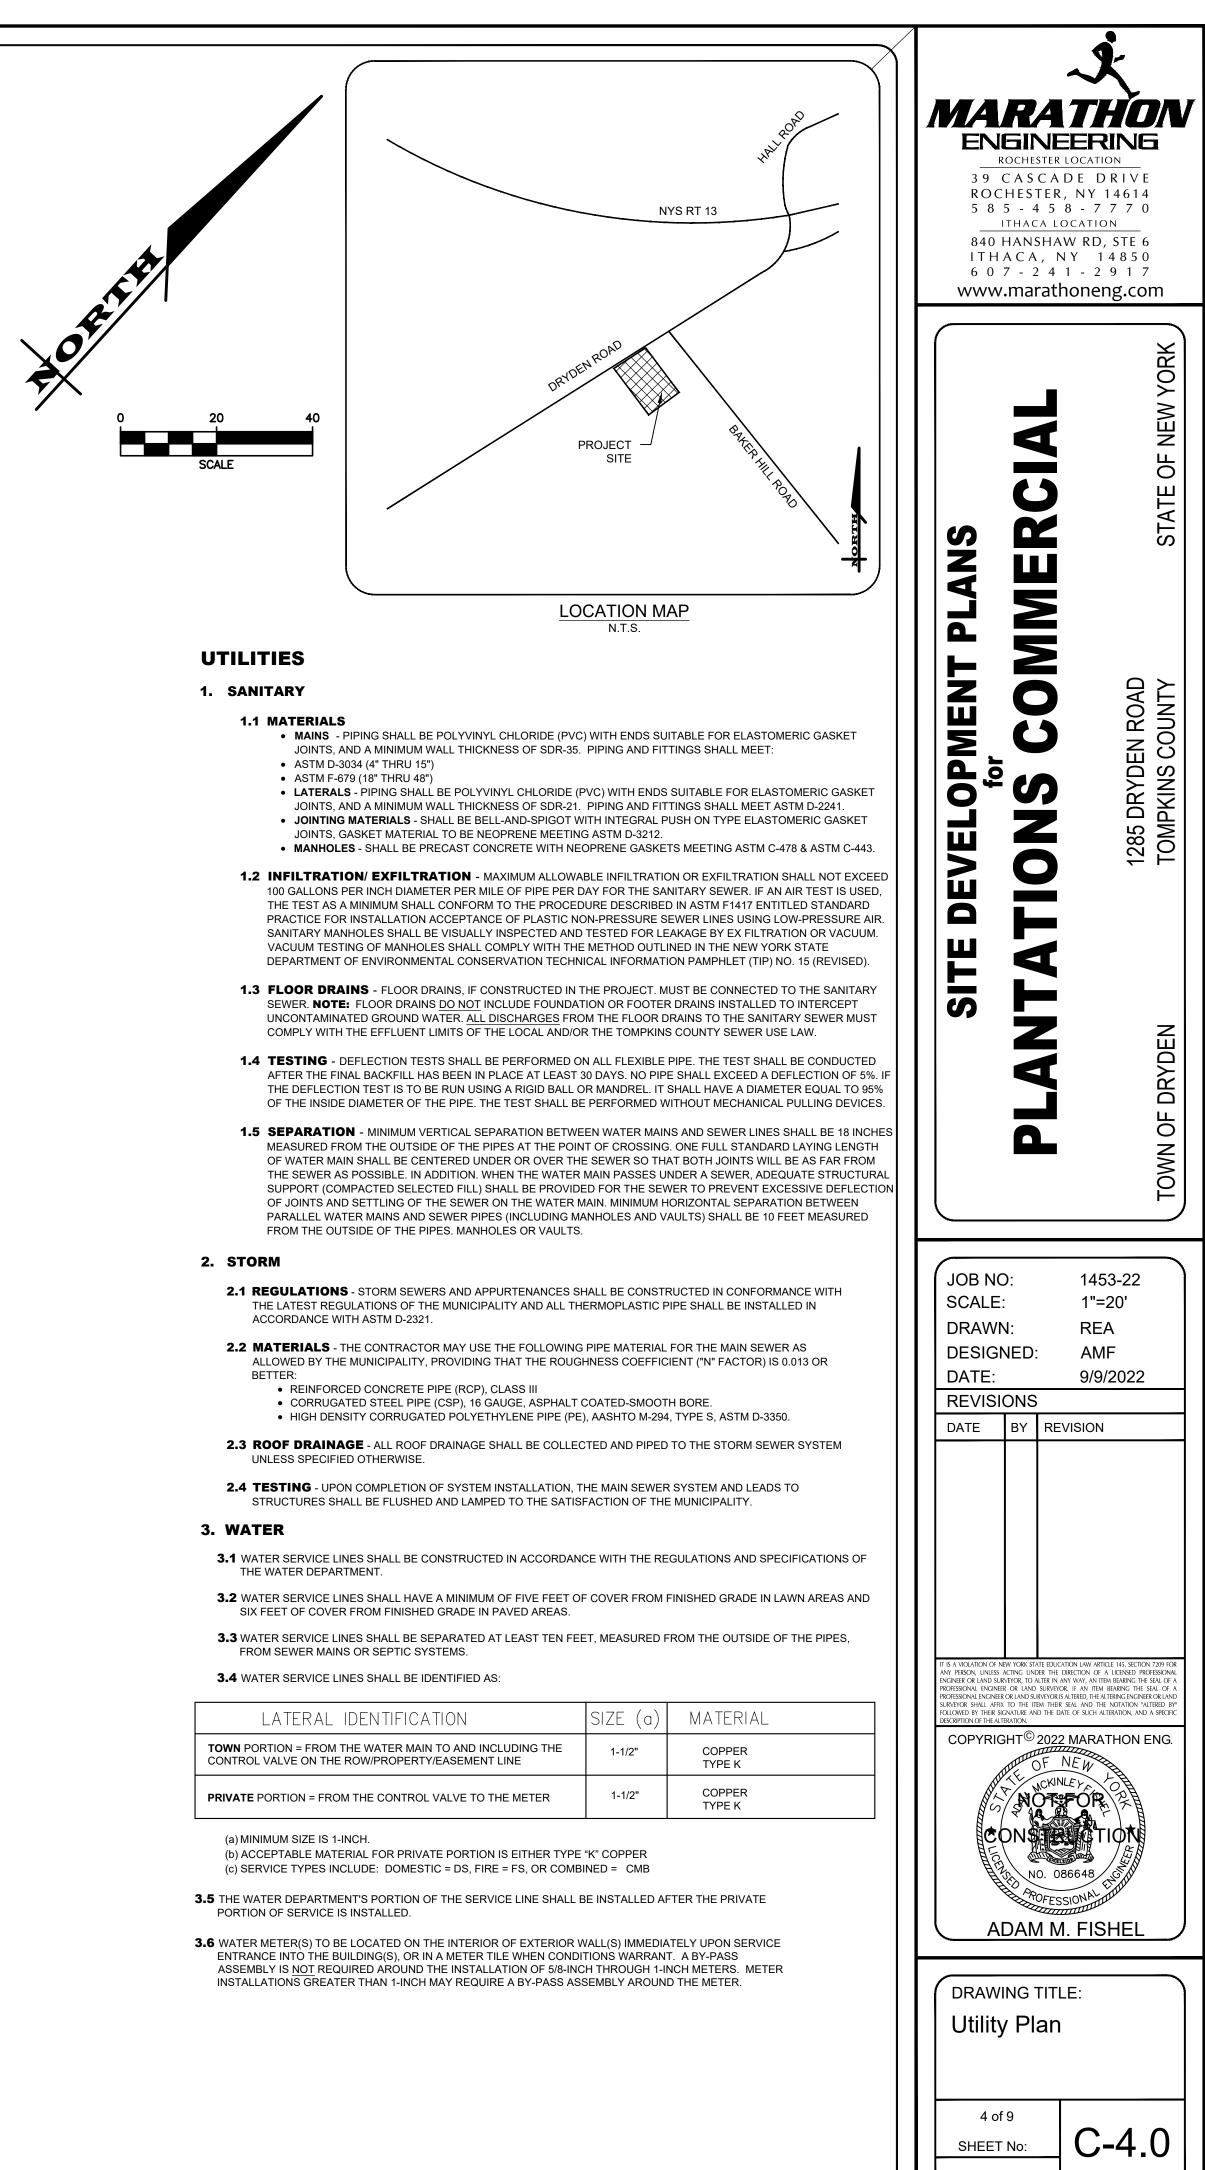


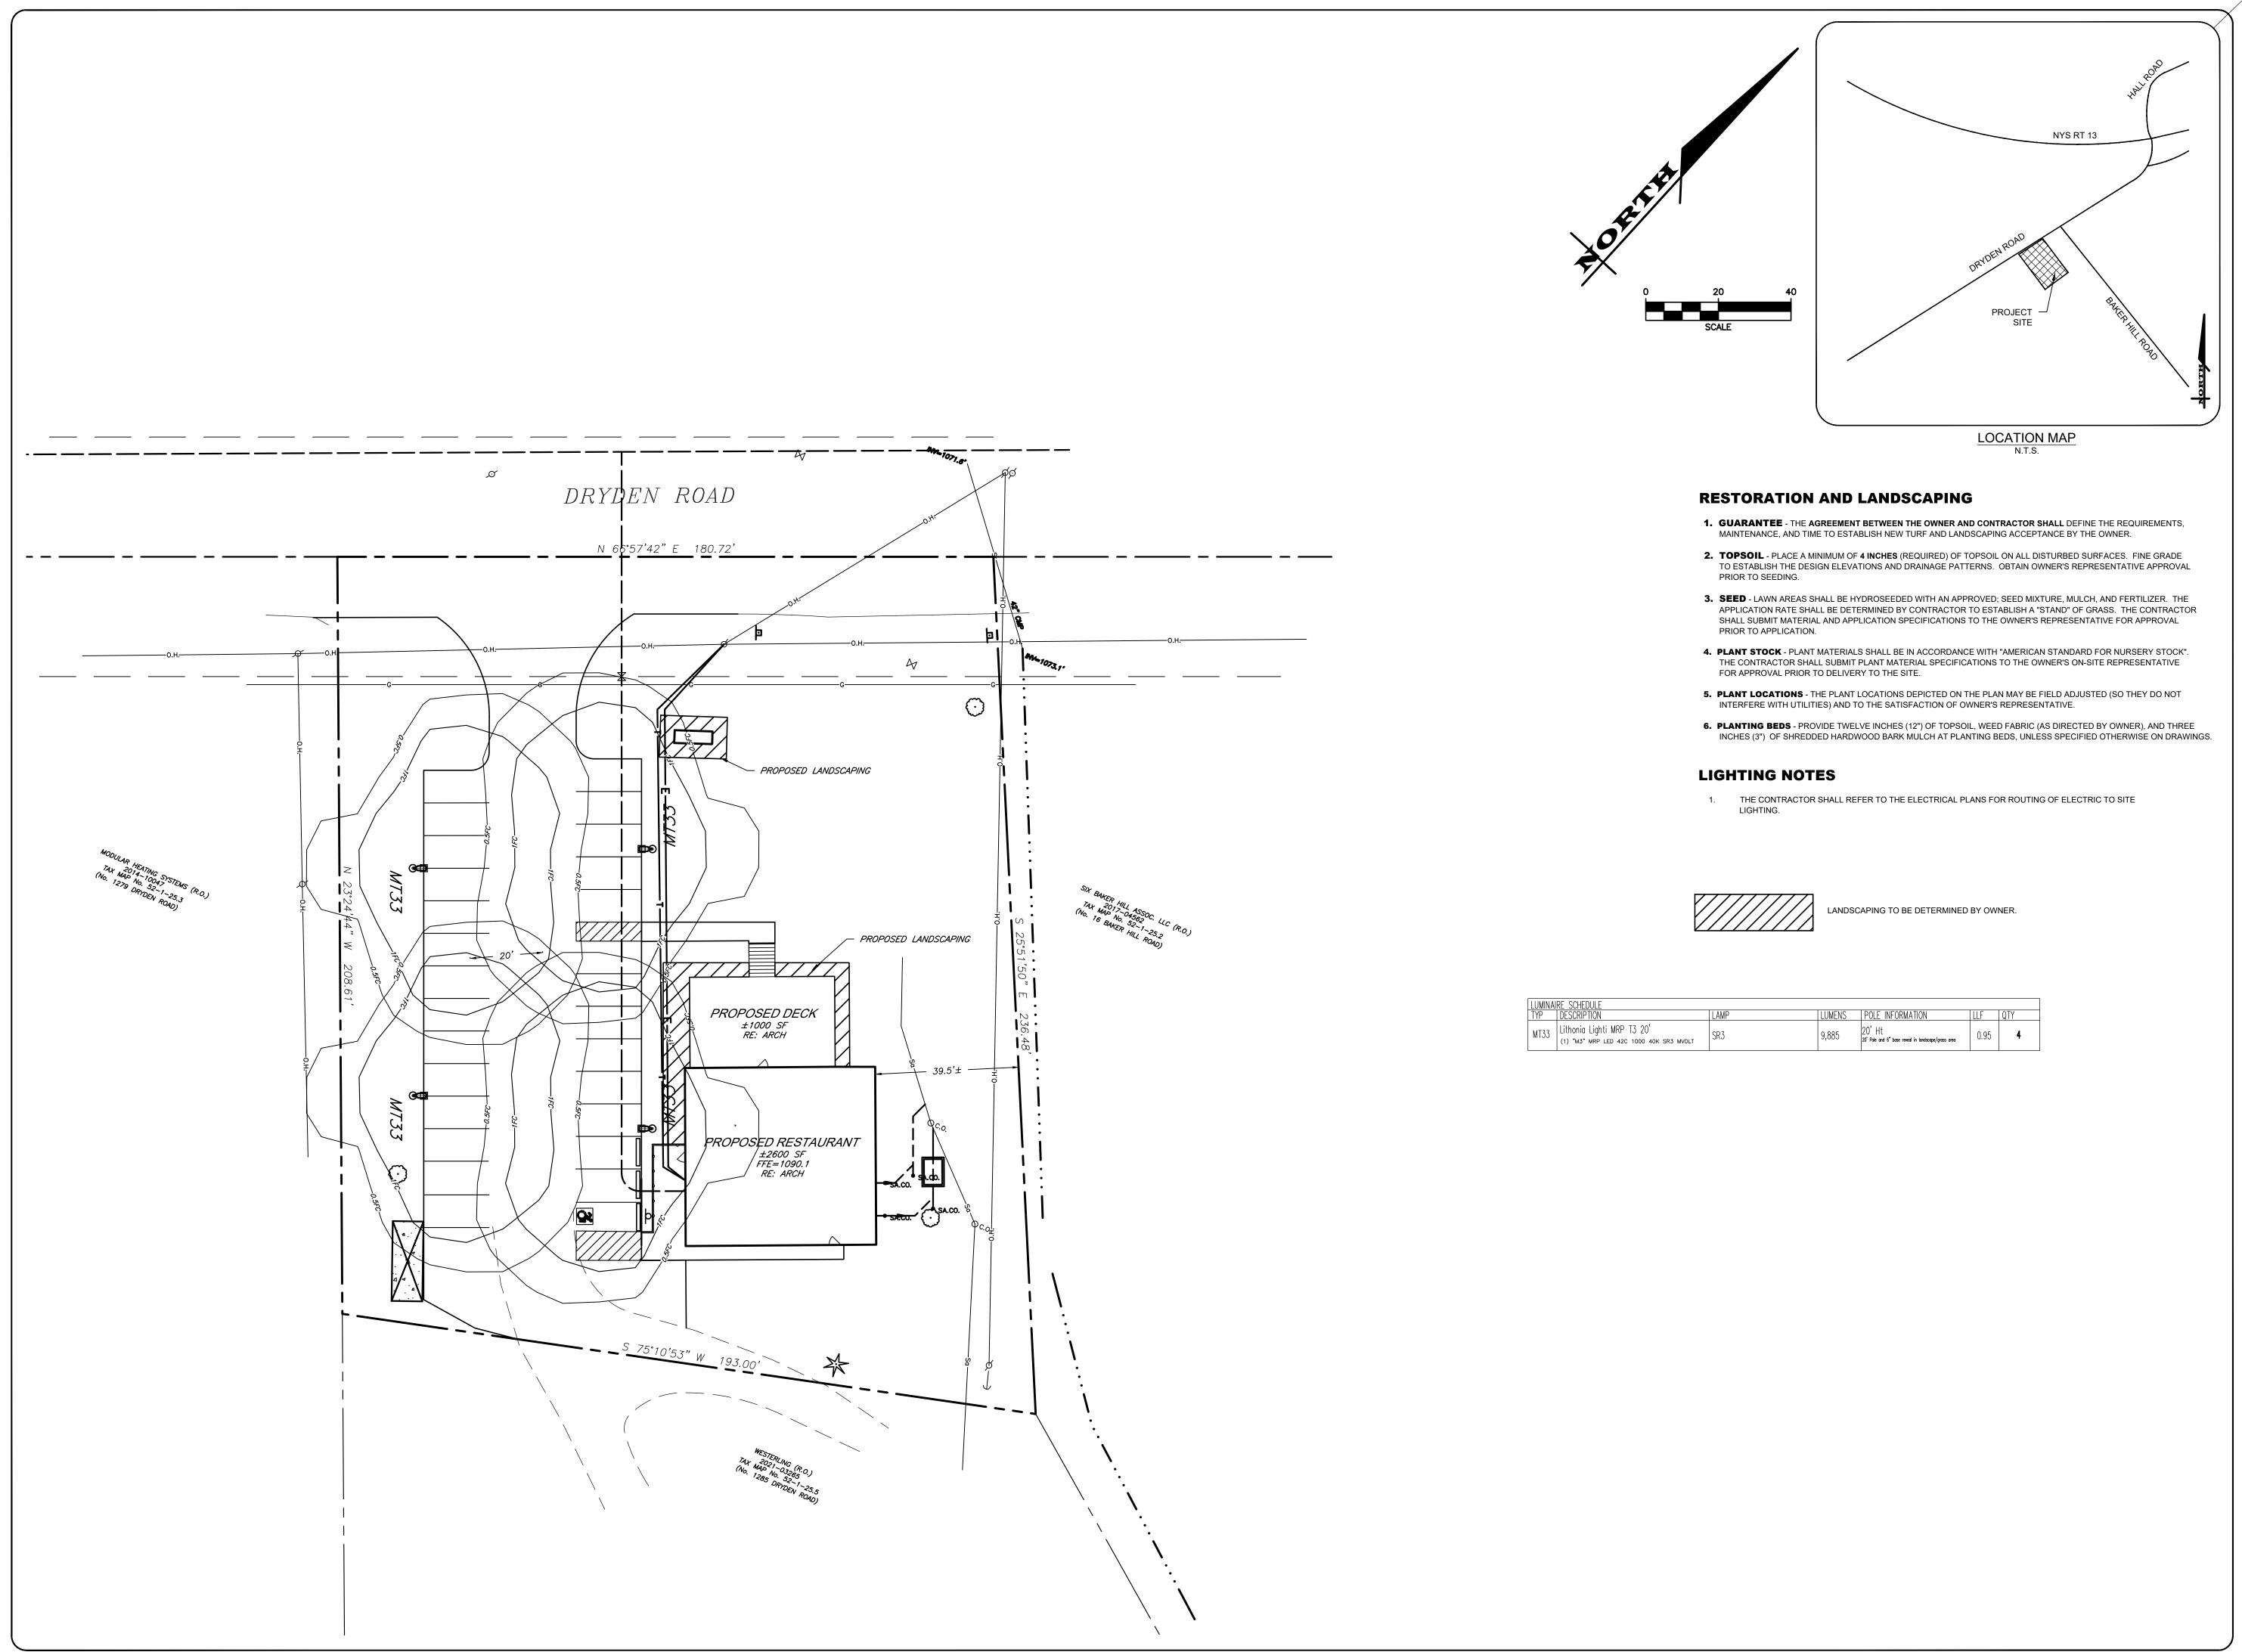

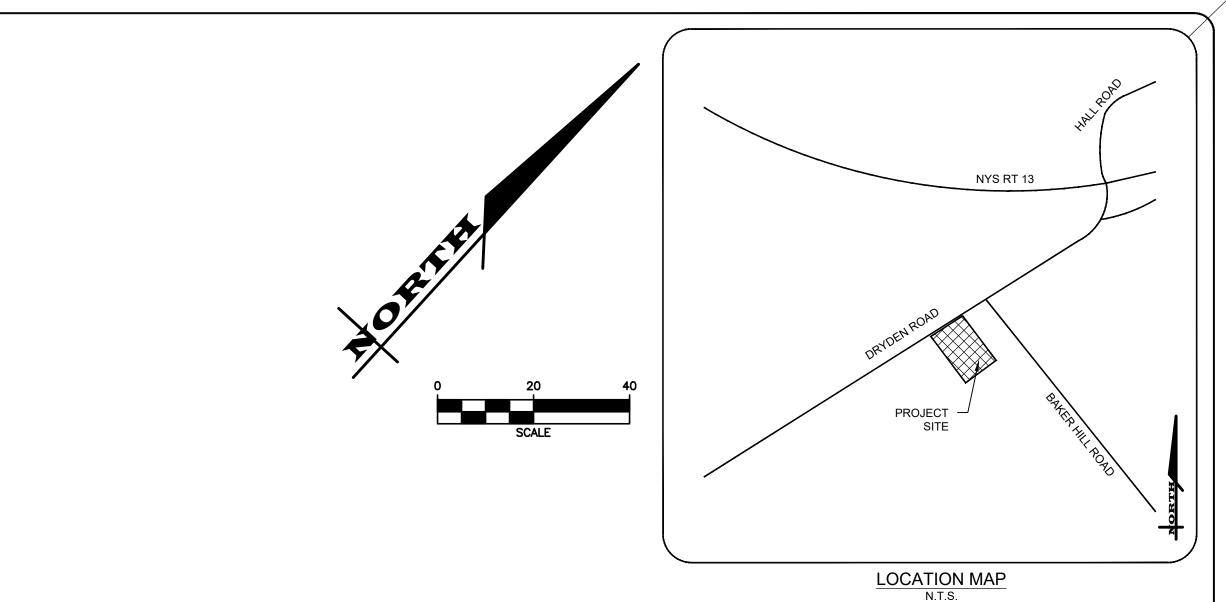


LUMENS	POLE INFORMATION	LLF	QTY
9,885	20' Ht 20' Pole and 6" base reveal in landscape/grass area	0.95	4


	ENGINE ROCHESTER 3 9 CASCA ROCHESTER 5 8 5 - 4 5 ITHACA L 840 HANSHA ITHACA, N 6 0 7 - 2 4	LOCATION DE DRIVE 2, NY 14614 8 - 7 7 7 0 OCATION W RD, STE 6 NY 14850	
	<b>JERCIAL</b>	STATE OF NEW YORK	
	PLANTATIONS COM	1285 DRYDEN ROAD TOMPKINS COUNTY	
	PLANTA'	TOWN OF DRYDEN	
	JOB NO: SCALE: DRAWN: DESIGNED: DATE: REVISIONS DATE BY RE	1453-22 1"=20' REA AMF 9/9/2022	
	CONST CONST	DIRECTION OF A LICENSED PROFESSIONAL ANY WAY, AN ITEM BEARING THE SEAL OF A SAVE WAY, AN ITEM BEARING THE SEAL OF A SALERED, THE ALTERING ENGINEER OR LAND SALETEED, THE NOTATION 'ALTERED BY' THE OF SUCH ALTERATION, AND A SPECIFIC AND ALTERATION, AND A SPECIFIC AND ALTERATION, AND A SPECIFIC	
Γ	DRAWING TIT		
	Landscapi		

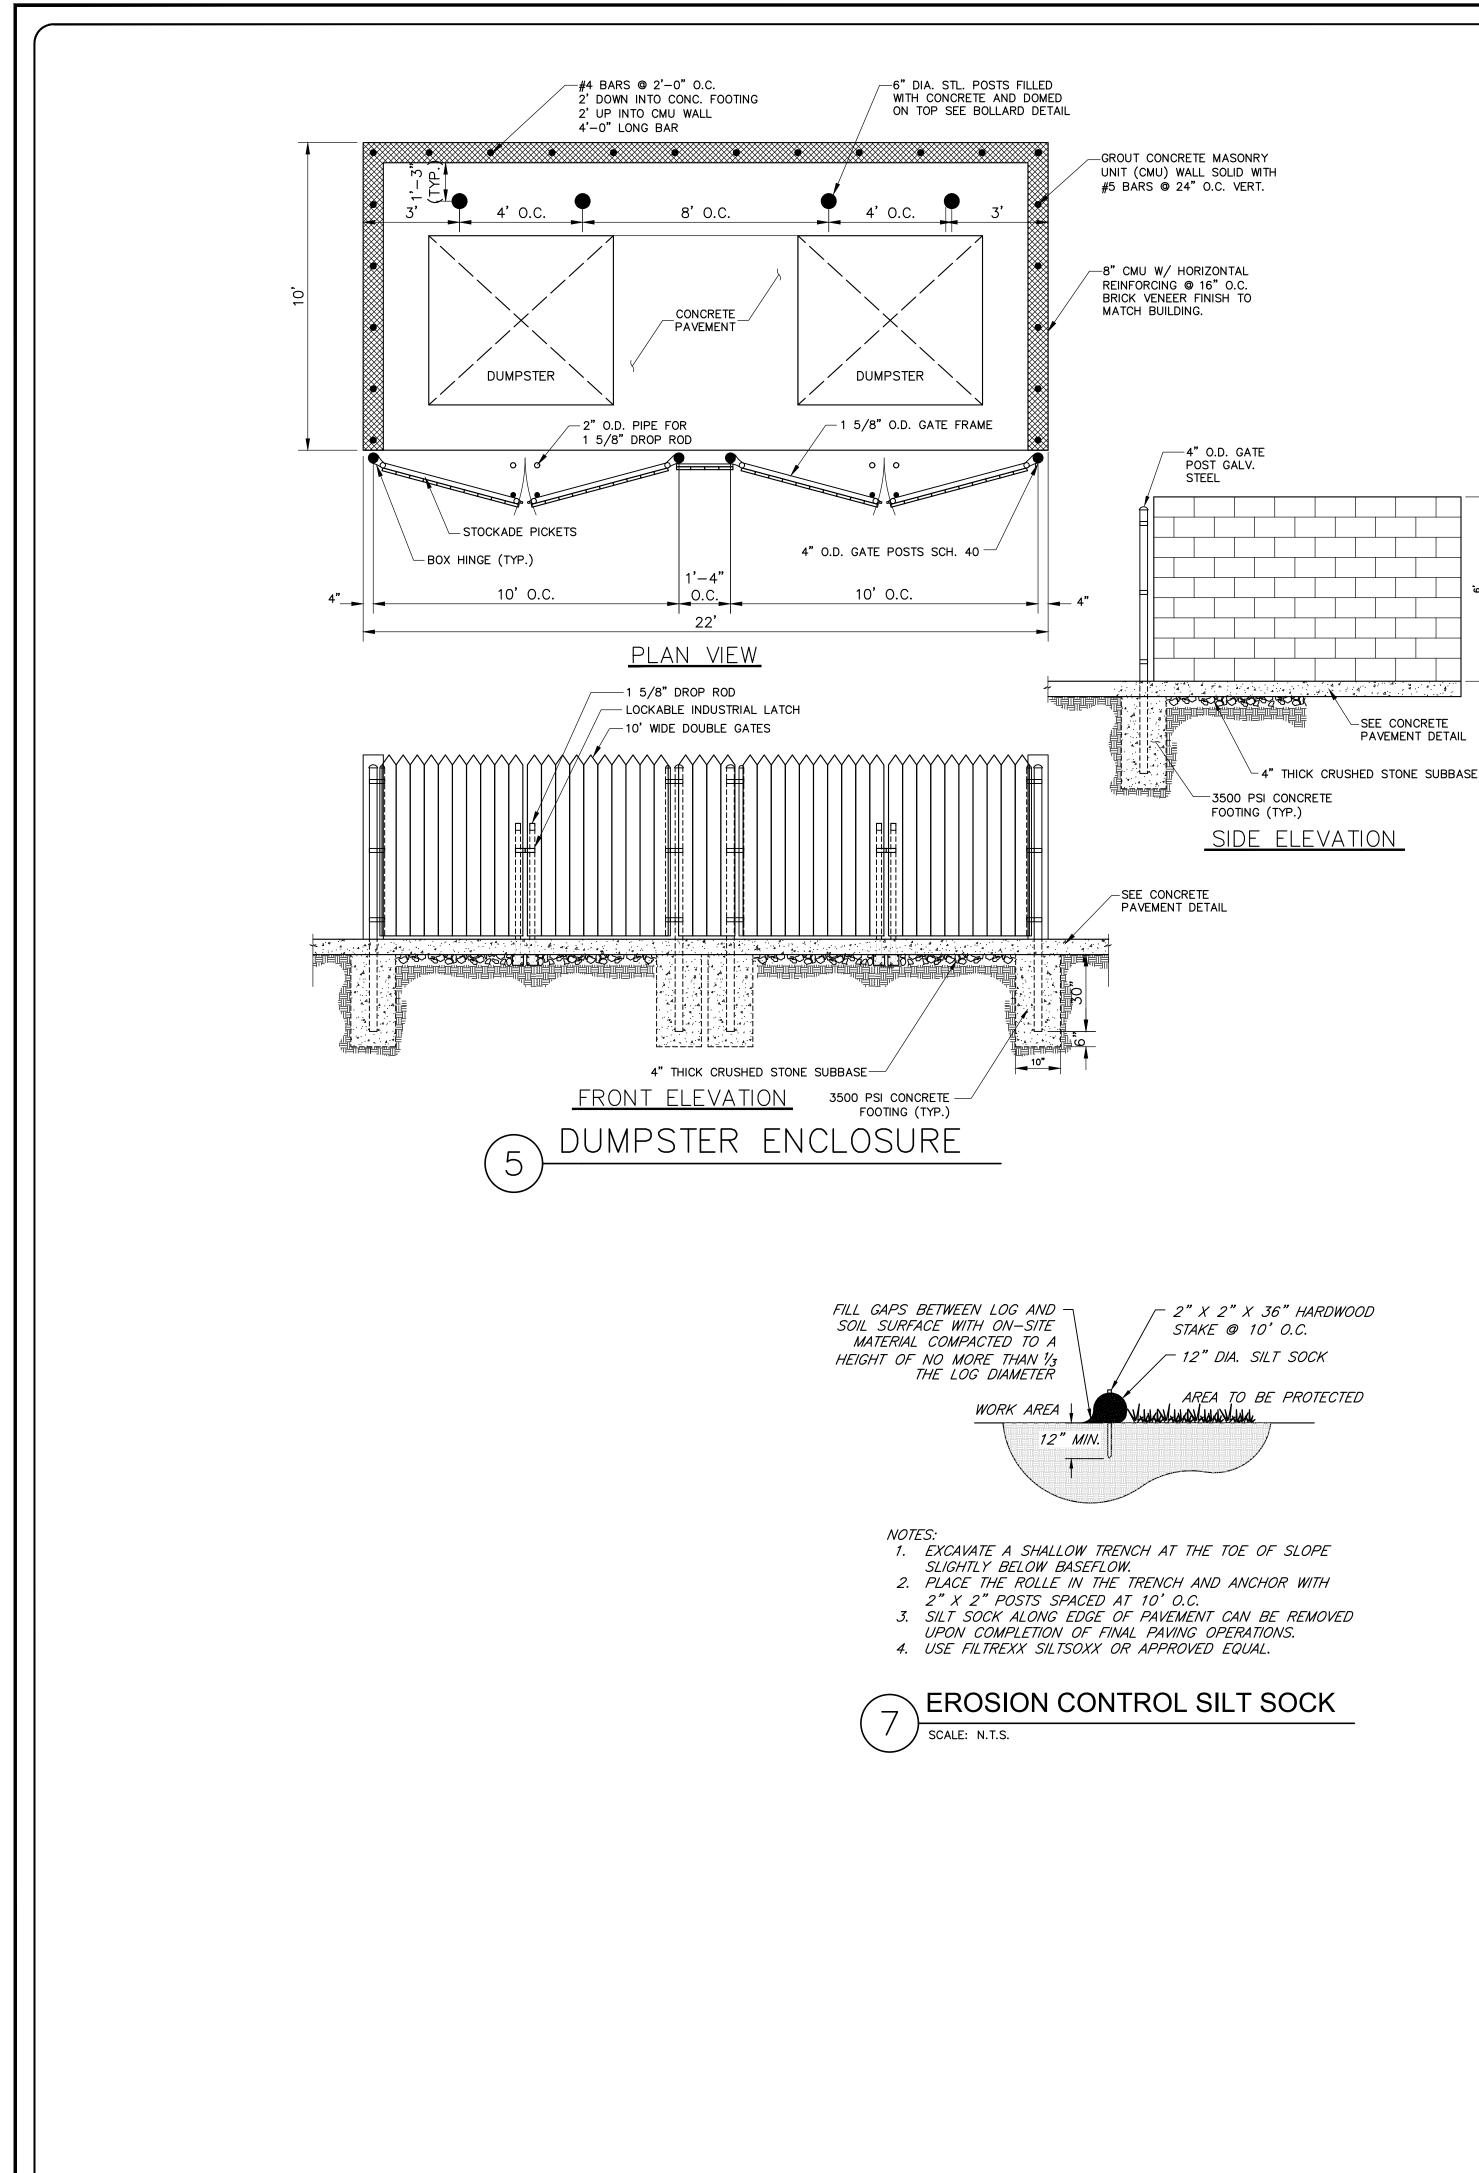




- 6. ENVIRO-FENCE WITH INTEGRAL MESH IS ACCEPTABLE SUBSTITUTE.
- 5. MAINTENANCE SHALL BE PERFORMED AS NEEDED AND MATERIAL REMOVED WHEN "BULGES" DEVELOP IN THE SILT FENCE.
- 4. PREFABRICATED UNITS SHALL BE GEOFAB, ENVIROFENCE, OR APPROVED EQUIVALENT.
- OPENING. 3. WHEN TWO SECTIONS OF FILTER CLOTH ADJOIN EACH OTHER THEY SHALL BE OVERLAPPED BY SIX INCHES AND FOLDED. FILTER CLOTH SHALL BE EITHER FILTER X, MIRAFI 100X, STABLINKKA T140N, OR APPROVED EQUIVALENT.
- POSTS SHALL BE STEEL "T" OF "U" TYPE OF HARDWOOD. 2. FILTER CLOTH TO BE FASTENED SECURELY TO WOVEN WIRE FENCE WITH TIES SPACED EVERY 24" AT TOP AND MID SECTION. FENCE SHALL BE WOVEN WIRE, 12 1/2 GAUGE, 6" MAXIMUM MESH
- SECTION VIEW CONSTRUCTION SPECIFICATIONS 1. WOVEN WIRE FENCE TO BE FASTENED SECURELY TO FENCE POSTS WITH WIRE TIES OR STAPLES,

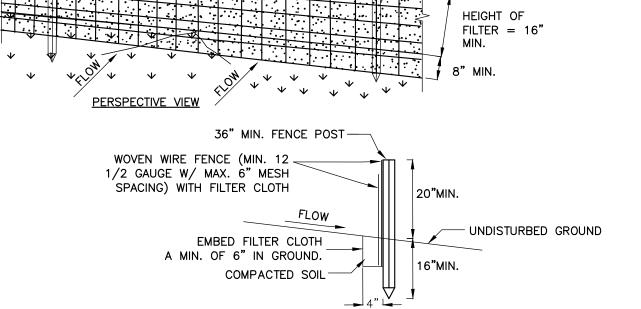

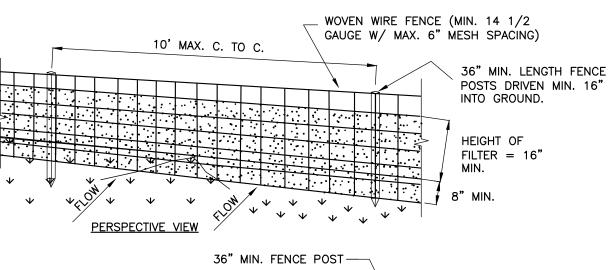

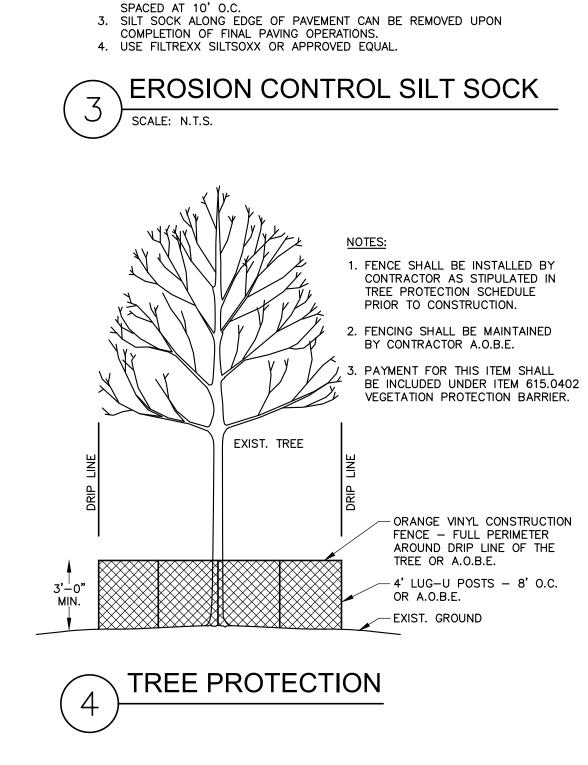

2" X 2" X 36" HARDWOOD STAKE

@ 10' O.C.

200/11/200/11/200/11/200

- 12" DIA. SILT SOCK

AREA TO BE PROTECTED

FILL GAPS BETWEEN LOG AND SOIL

SURFACE WITH ON-SITE MATERIAL

COMPACTED TO A HEIGHT OF NO

MORE THAN m % THE LOG DIAMETER

BASEFLOW.


NOTES:


WORK AREA


12" MIN.

1. EXCAVATE A SHALLOW TRENCH AT THE TOE OF SLOPE SLIGHTLY BELOW


2. PLACE THE ROLLE IN THE TRENCH AND ANCHOR WITH 2" X 2" POSTS

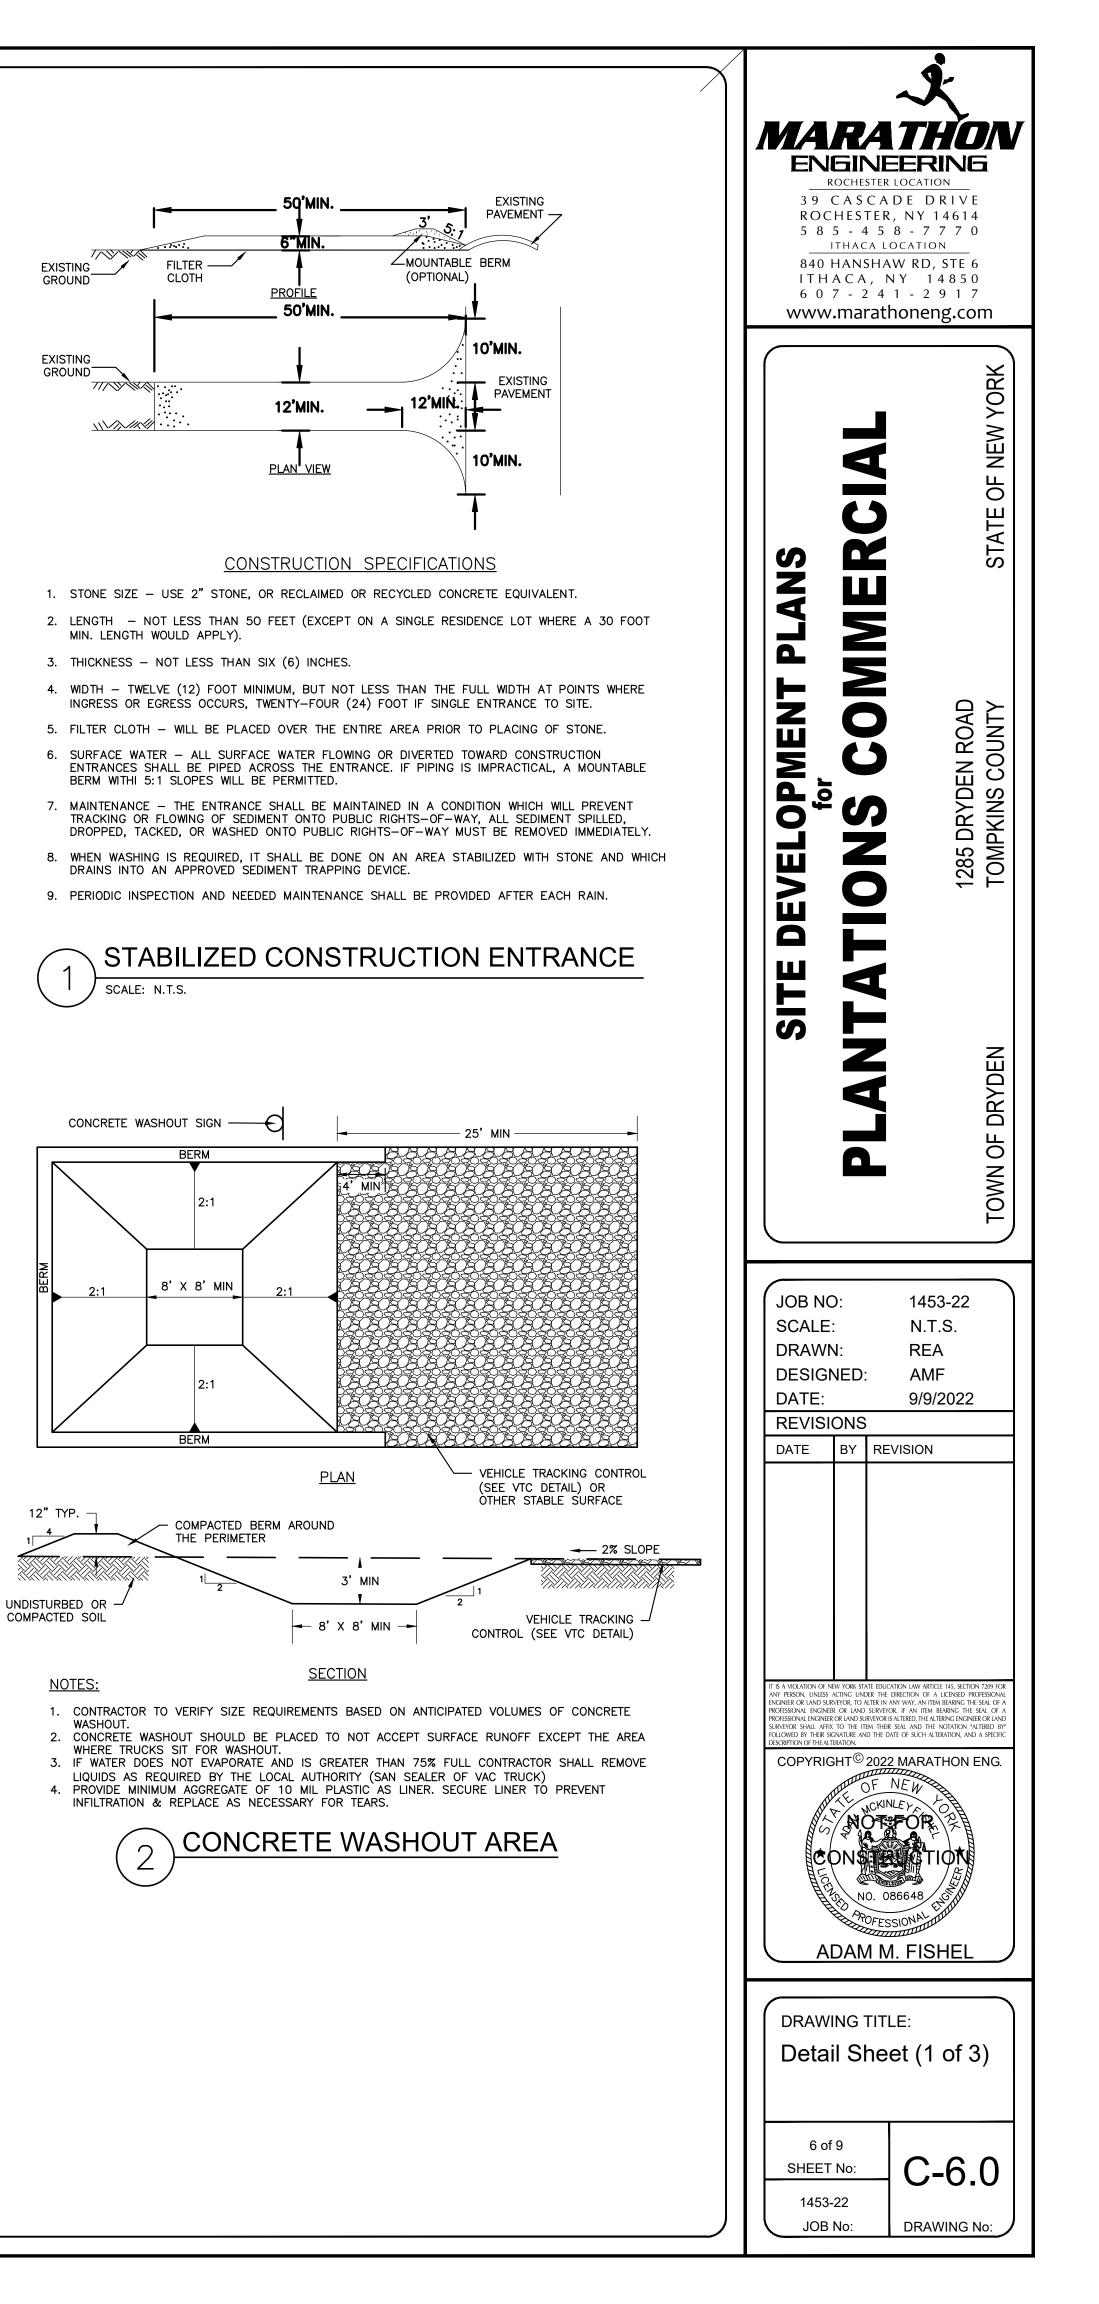


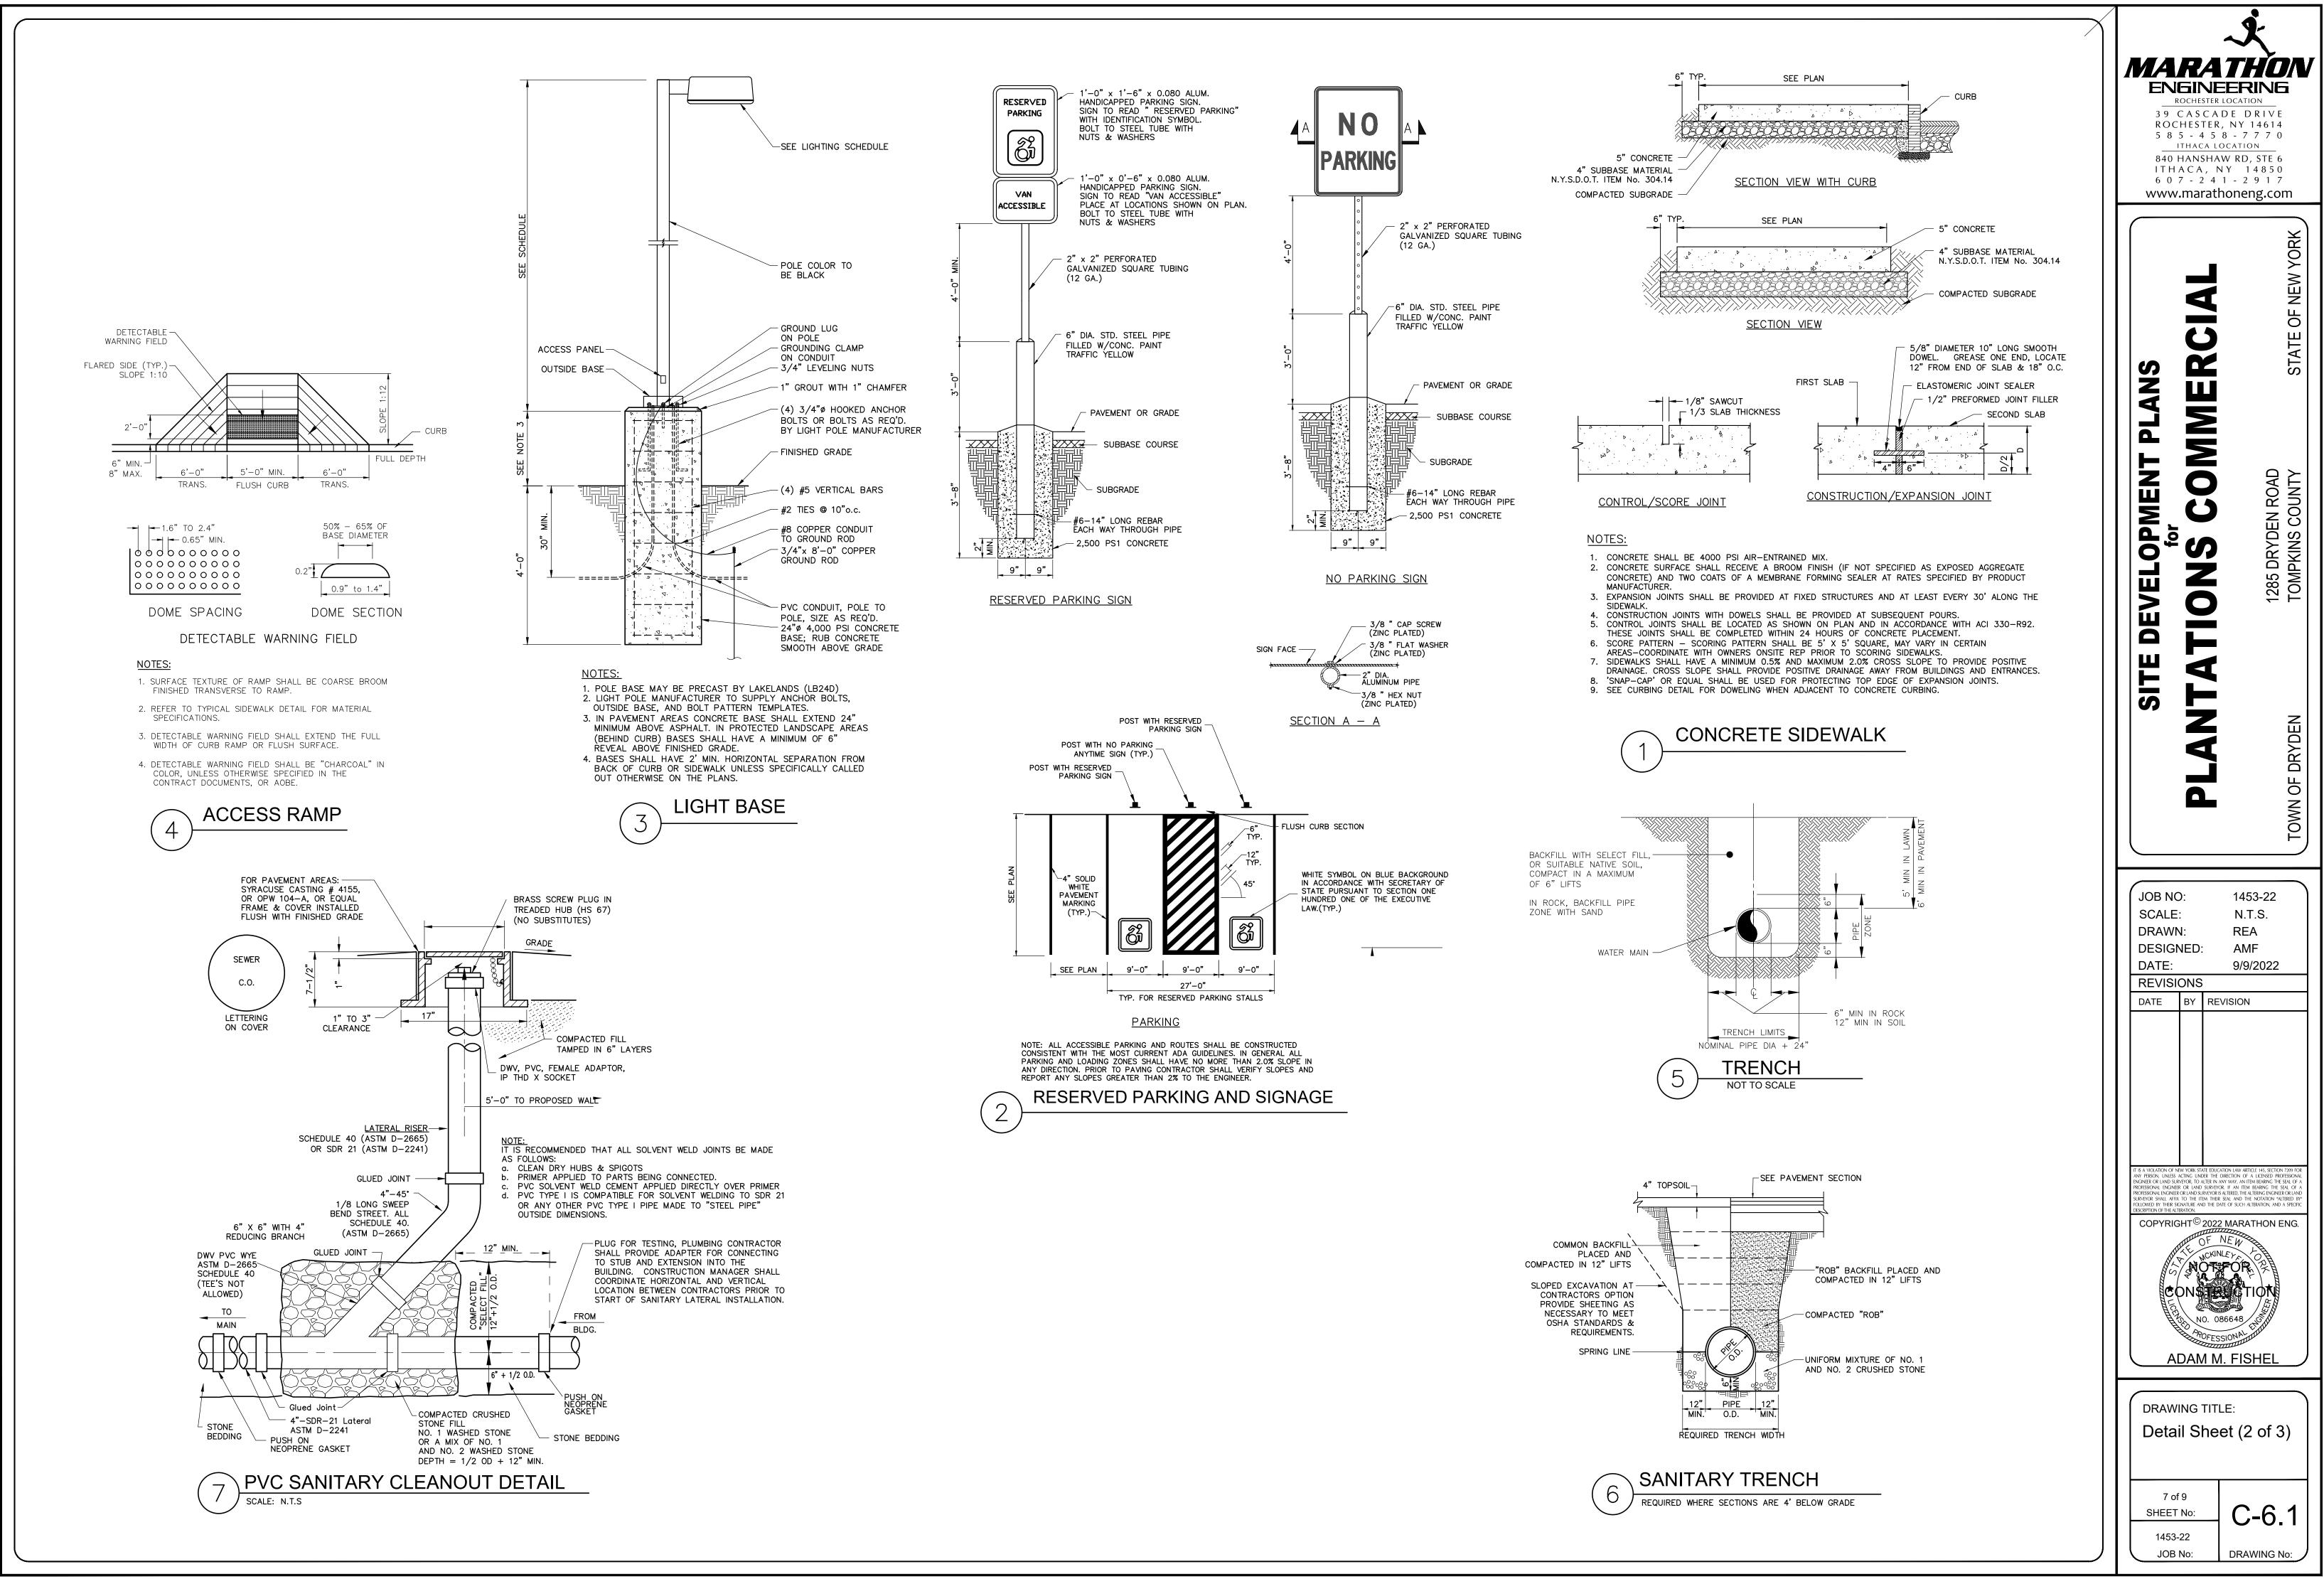

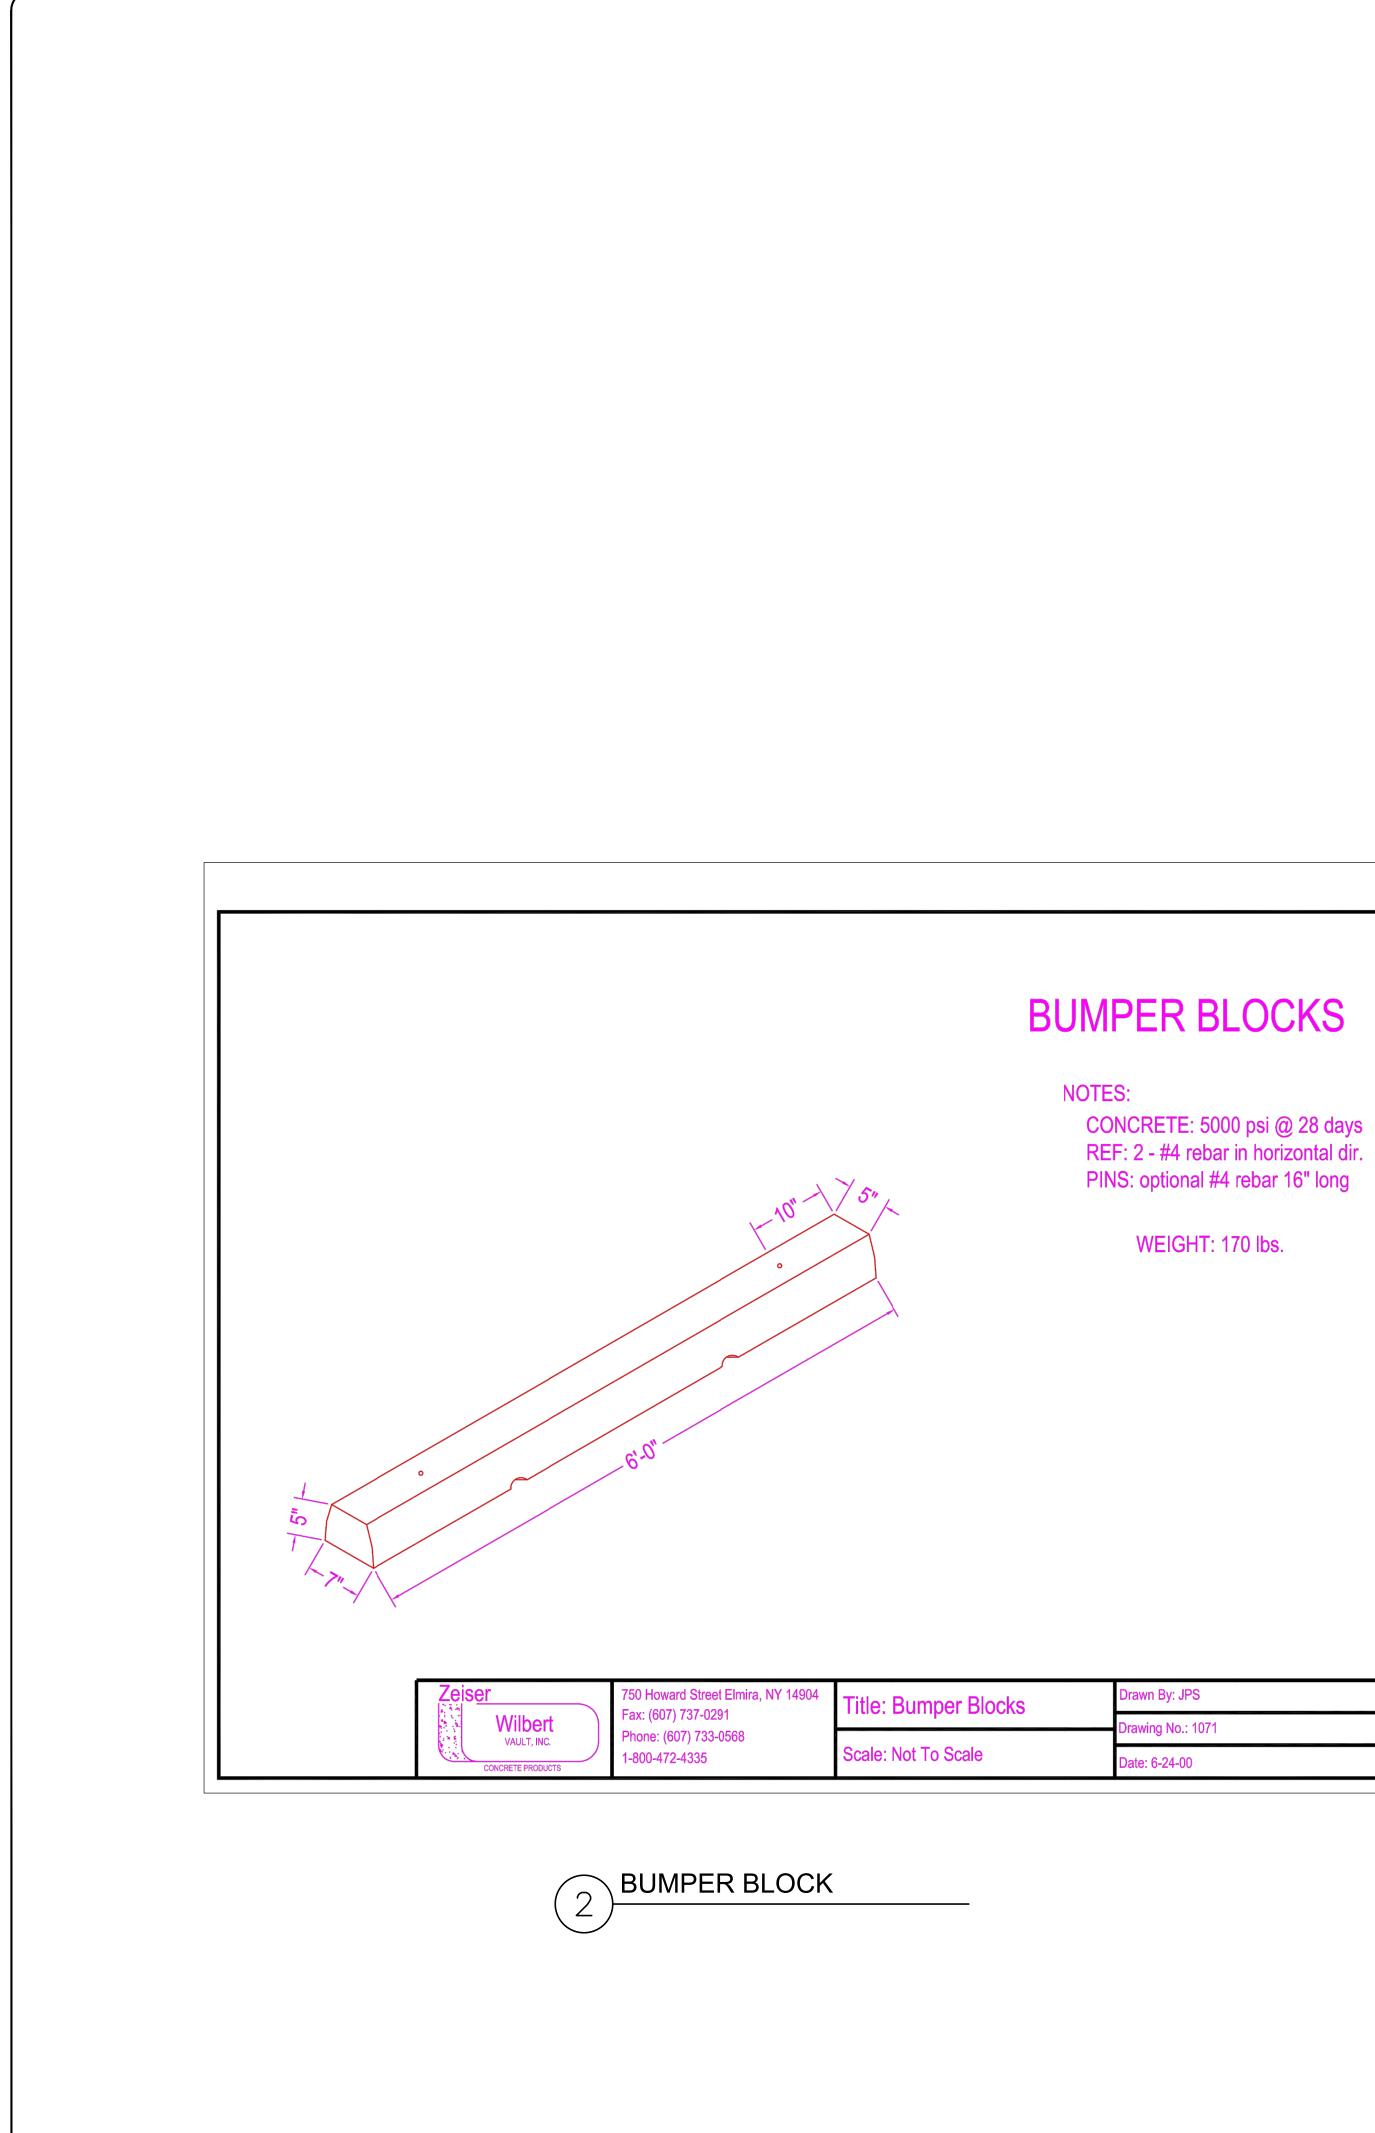

Drawn By: JPS
 Drawing No.: 1071
Date: 6-24-00

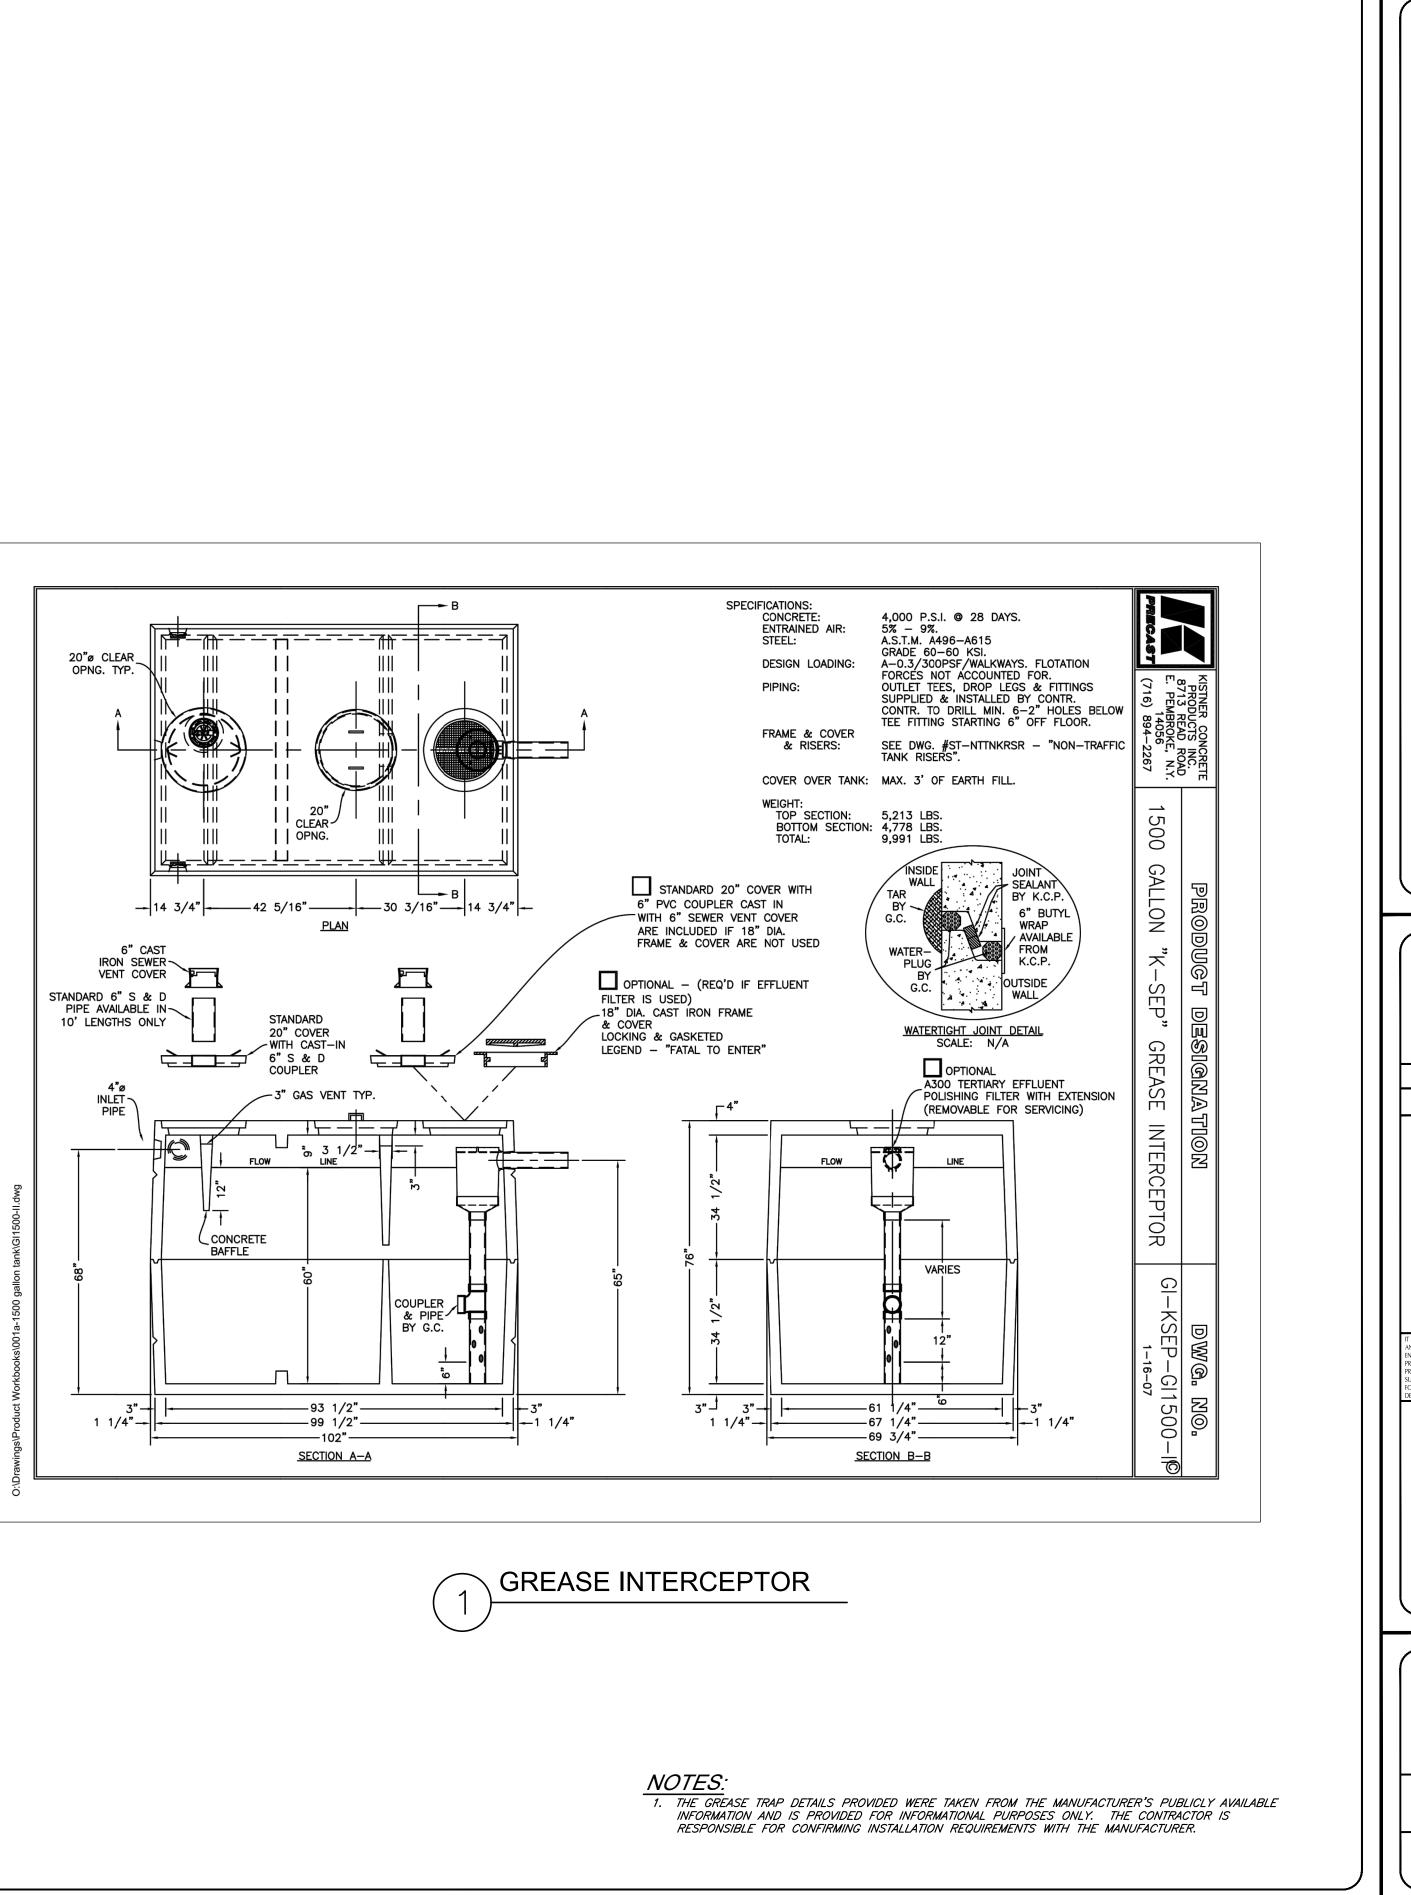

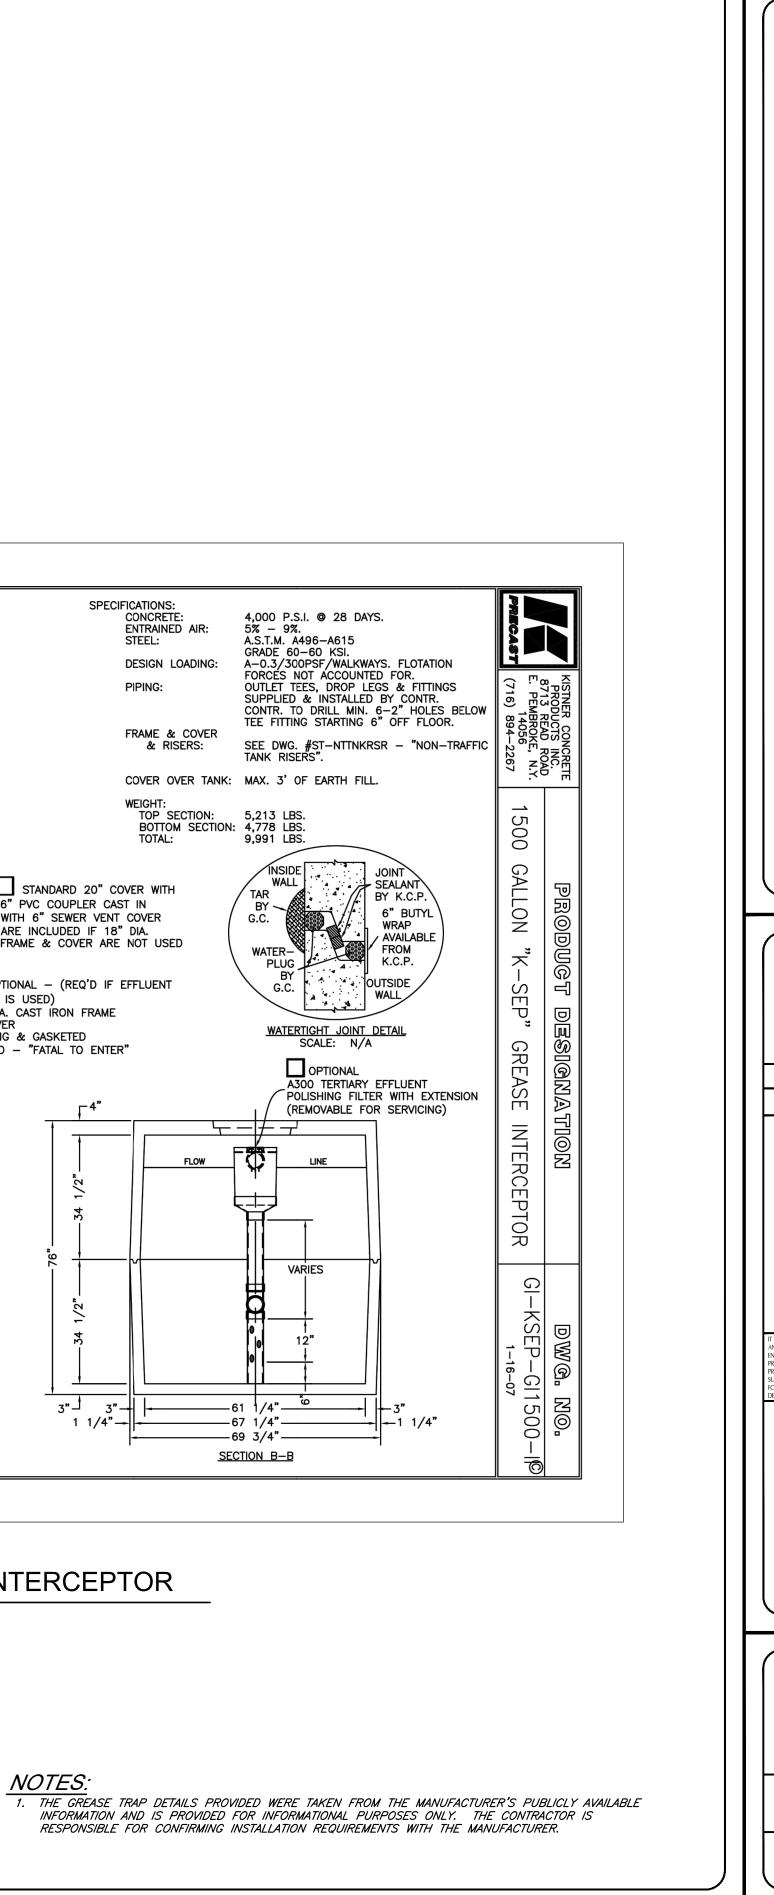

ROCHESTER LOCATION 3 9 CASCADE DRIVE ROCHESTER, NY 14614 5 8 5 - 4 5 8 - 7 7 7 0 ITHACA LOCATION 840 HANSHAW RD, STE 6 ITHACA, NY 14850 6 0 7 - 2 4 1 - 2 9 1 7 www.marathoneng.com				
LANS MERCIAL	STATE OF NEW YORK			
SITE DEVELOPMENT P for for for for for for for M	1285 DRYDEN ROAD TOMPKINS COUNTY			
PLANTA	TOWN OF DRYDEN			
JOB NO: SCALE: DRAWN: DESIGNED: DATE: REVISIONS DATE BY RE	1453-22 N.T.S. REA AMF 9/9/2022			
<text></text>				
DRAWING TITLE: Detail Sheet (3 of 3)				
8 of 9 SHEET No: 1453-22 JOB No:	C-6.2			

