SITE DEVELOPMENT PLANS FOR

PG DRYDEN, LLC

1061 DRYDEN ROAD / NYS RT. 366

SITUATED IN:

TOWN OF DRYDEN - TOMPKINS COUNTY - NEW YORK

PROJECT CONTACTS:

APPLICANT: TIM CRILLY PG DRYDEN, LLC 46 PRINCE STREET ROCHESTER, NY 14607 (585) 481-6091

ARCHITECT: JAMES FAHY DESIGN 2024 WEST HENRIETTA ROAD ROCHESTER, NY 14623 (585) 272-1650

SANITARY SEWER: RICK YOUNG TOWN OF DRYDEN DEPARTMENT OF PUBLIC WORKS 61 EAST MAIN STREET DRYDEN, NY 13053 (607) 844-5188


ELECTRIC: NEW YORK STATE ELECTRIC & GAS 18 LINK DRIVE BINGHAMTON, NY 13904 (607) 343-5283


SURVEYOR: LEE DRESSER, L.S. TG MILLER, PC 605 W STATE STREET SUITE A ITHACA, NY 14850 (607) 272-6477

CIVIL ENGINEER: ADAM M. FISHEL, PE MARATHON ENGINEERING 840 HANSHAW ROAD, SUITE 12 ITHACA, NY 14850 (607) 241-2917

WATER: **BOLTON POINT WATER SYSTEM** STEVE RIDDLE 1402 EAST SHORE DRIVE ITHACA, NY 14850 (607) 277-0660

GAS: **NEW YORK STATE ELECTRIC & GAS** 18 LINK DRIVE BINGHAMTON, NY 13904 (607) 343-5283

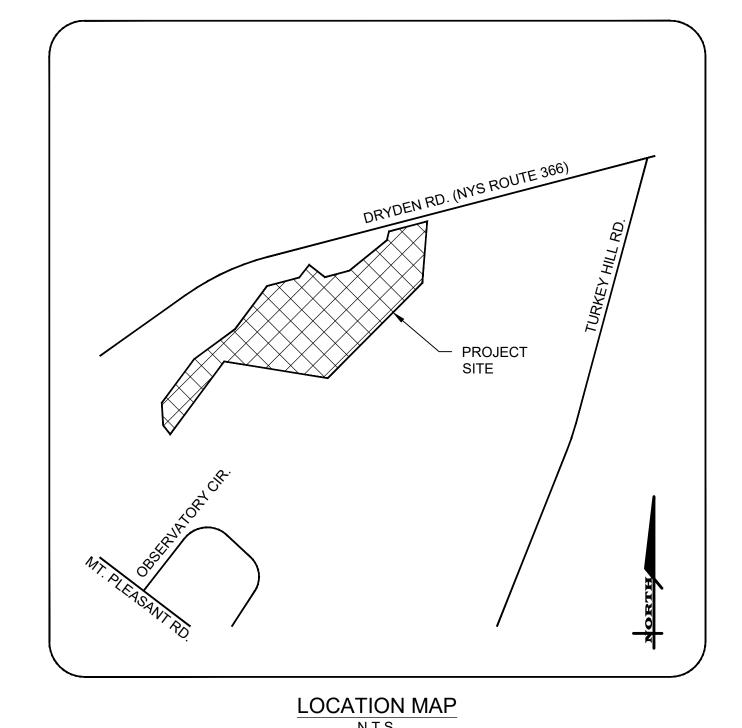

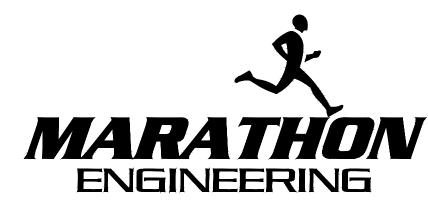

39 CASCADE DRIVE ROCHESTER, NY 14614 5 8 5 - 4 5 8 - 7 7 7 0 ITHACA LOCATION 840 HANSHAW RD, STE 6 ITHACA, NY 14850 6 0 7 - 2 4 1 - 2 9 1 7 www.marathoneng.com

ROCHESTER LOCATION GE OF PAVEMENT NISH FLOOR = FINISH FLOOR ELEVATION NISH PAD = GARAGE FLOOR ELEVATION

EXISTING

DESCRIPTION

LIGHT POLE

POWER POLE

+00 \oplus -2+00 CENTERLINE AND STATIONING

SAN @ 1 02 SAN DE 1 02

· --- CENTERLINE OF SWALE

SPOT ELEVATION

TREE PROTECTION

ABBREVIATIONS

PARKING SPACE COUNT

MONUMENT OR MONTH MONROE COUNTY GEODET

POINT OF TANGENCY
POINT OF VERTICAL CURVATURE
POINT OF VERTICAL INTERESECTION
POINT OF VERTICAL TANGENCY
POWER POLE

EINFORCED CONCRETE PIPE

SQUARE YARD TANGENT DISTANCE THEORETICAL GRADE LINE

RTICAL CURVE

TRIFIED TILE PIP

O—8"ST→---□ O12"PE ST O 1.0% STORM SEWER, MANHOLE & FIELD/DROP INLET

TREE LINE

ONTAL CONTROL LINE

GAS MAIN & VALVE

ELECTRIC CONDUIT & STRUCTURE TELEPHONE CONDUIT & STRUCTURE

, WATER MAIN WITH HYDRANT & GATE VALVE

DWG	TITLE COVER SHEET			
	BOUNDARY & TOPOGRAPHIC MAP			
C1.0	NOTES SHEET			
C2.0	SITE PLAN (1 OF 2)			
C2.1	SITE PLAN (2 OF 2)			
C3.0	GRADING, DRAINAGE AND EROSION CONTROL PLAN			
C4.0	UTILITY PLAN (1 OF 2)			
C4.1	UTILITY PLAN (2 OF 2)			
C5.0	LIGHTING AND LANDSCAPING PLAN			
C6.0	DETAIL SHEET (1 OF 6)			
C6.1	DETAIL SHEET (2 OF 6)			
C6.2	DETAIL SHEET (3 OF 6)			
C6.3	DETAIL SHEET (4 OF 6)			
C6.4	DETAIL SHEET (5 OF 6)			
C6.5	DETAIL SHEET (6 OF 6)			
C7.0	DRIVEWAY PLAN (1 OF 3)			
C7.1	DRIVEWAY PLAN (2 OF 3)			
C7.2	DRIVEWAY PLAN (2 OF 3)			
C8.0	TRUCK TURN PLAN			

OWNER/ APPLICANT:

PDG DRYDEN, LLC 46 PRINCE STREET ROCHESTER, NY 14607

COPYRIGHT © 2023 MARATHON ENGINEERING

OF ROCHESTER, P.C.

<u>DESIGNER CONTACT STATEMENT:</u>
MARATHON ENGINEERING IS RESPONSIBLE FOR THE DESIGN OF THIS PROJECT. ADAM M. FISHEL, PE IS THE DESIGNER AND IS FAMILIAR WITH THE NYSDOT STANDARDS AND REQUIREMENTS AND SHALL BE CONTACTED AT (607) 241-2917 TO RESOLVE ISSUES OR PROBLEMS DURING CONSTRUCTION. ALL REVISIONS, INCLUDING REVISIONS NECESSARY DUE TO FIELD CONDITIONS,

SOIL RESTORATION REQUIREMENTS							
TYPE OF SOIL DISTUBANCE	RESTORATION	REQUIREMENTS	COMMENTS/EXAMPLES				
NO SOIL DISTURBANCE	RESTORATION NO	T REQUIRED	PRESERVATION OF NATURAL FEATURES				
MINIMAL SOIL DISTURBANCE	RESTORATION IS I	NOT REQUIRED	CLEARING & GRUBBING				
	HSG A & B	HSG C & D					
AREAS WHERE TOPSOIL IS STRIPPED ONLY — NO CHANGE TO GRADE	APPLY 6 INCHES OF TOPSOIL	AERATE* & APPLY 6 INCHES OF TOPSOIL	PROTECT AREA FROM ANY ONGOING CONSTRUCTION ACTIVITIES				
	HSG A & B	HSG C & D					
AREAS OF CUTS OR FILLS	AERATE & APPLY 6 INCHES OF TOPSOIL	APPLY FULL SOIL RESTORATION**					
HEAVY TRAFFIC AREAS (ESEPCIALLY WITHIN A ZONE OF 5- 25 FFET AROUND BUILDINGS, BUT NOT WITHIN 5 FEET OF THE FOUNDATION WALLS)	APPLY FULL SOIL F (DE-COMPACTION ENHANCEMENT)						
AREAS WHERE RUNOFF REDUCTION AND OR INFILTRATION PRACTICES ARE APPLIED	SOIL RESTORATIO REQUIRED, BUT M TO ENHANCE THE SPECIFIED FOR AP PRACTICES	1AY BE APPLIED REDUCTION	KEEP CONSTRUCTION EQUIPMENT FROM CROSSING THESE AREAS. TO PROTECT NEWLY INSTALLED PRACTICES FROM ANY ONGOING CONSTRUCTION ACTIVITIES, CONSTRUCT A SINGLE PHASE OPERATION FENCE AREA				
REDEVELOPMENT PROJECTS	SOIL RESTORATIO ON REDEVELOPM AREAS WHERE EX IMPERVIOUS ARE. CONVERTED TO P						
Aeration includes the use of ma	achines such as tra	ctor-drawn impler	nents with coulters making a				

*Aeration includes the use of machines such as tractor-drawn implements with coulters making a narrow slit in the soil, a roller with many spikes making indentations in the soil, or prongs which function like a mini-subsoile

** Per "Deep Ripping and De -compaction, DEC 2008".

1. DURING PERIODS OF RELATIVELY LOW TO MODERATE SUBSOIL MOISTURE, THE DISTURBED SUBSOILS ARE RETURNED TO ROUGH GRADE AND THE FOLLOWING SOIL RESTORATION STEPS

APPLY 3 INCHES OF COMPOST OVER SUBSOIL.

 TILL COMPOST INTO SUBSOIL TO A DEPTH OF AT LEAST 12 INCHES USING A CAT MOUNTED RIPPER, TRACTOR-MOUNTED DISC, OR TILLER, MIXING, AND CIRCULATING AIR AND COMPOST

INTO SUBSOILS

 ROCKPICK UNTIL UPLIFTED STONE/ROCK MATERIALS OF FOUR INCHES AND LARGER SIZE ARE CLEANED OFF THE SITE

APPLY TOPSOIL TO A DEPTH OF 6 INCHES

EROSION CONTROL

- 1. CERTIFICATION THE STORM WATER POLLUTION PREVENTION PLAN (SWPPP), WHICH INCLUDES THE "GRADING PLAN", "EROSION CONTROL PLAN", "EROSION CONTROL NOTES", ALONG WITH THE "DRAINAGE REPORT", DEFINES AND MEETS THE REQUIREMENTS OF THE NEW YORK STATE DEPARTMENT OF ENVIRONMENTAL CONSERVATION (NYSDEC) LATEST STORM WATER REGULATIONS.
- 2. CONTRACTOR RESPONSIBILITY ALL CONTRACTORS AND SUB-CONTRACTORS SHALL CERTIFY WITHIN THE SWPPP THAT THEY WILL IMPLEMENT AND MAINTAIN STORM WATER MANAGEMENT PRACTICES.
- 3. INSPECTION EROSION CONTROL (EC) MEASURES INSTALLED AND MAINTAINED BY THE SITE WORK CONTRACTOR ARE SUBJECT TO THE REVIEW AND APPROVAL OF THE: MUNICIPALITY, DESIGN ENGINEER, NYSDEC, AND OWNER'S REPRESENTATIVE. IMMEDIATE ACTION BY THE CONTRACTOR SHALL BE TAKEN IF ADDITIONAL OR CORRECTIVE MEASURES ARE REQUIRED BY ANY ONE OF THESE CITED REVIEWERS. EROSION CONTROL MEASURES NOT SPECIFICALLY SHOWN ON CONTRACT DRAWINGS (I.E., STRAW BALES, COLLARS, FABRICS, ETC.) SHALL BE INSTALLED AS WARRANTED BY FIELD CONDITIONS, AND AS DIRECTED BY THE AFOREMENTIONED
- 4. **NOTIFICATION** AS DESIGN ENGINEER, OUR OFFICE HAS NOTIFIED THE OWNER OF THE INSPECTION REQUIREMENTS UNDER GP-0-20-002. DISTURBANCES OF 1.0 ACRE OR GREATER REQUIRE THAT THE OWNER FILE A NOTICE OF INTENT (NOI) AND A SWPPP WITH THE NYSDEC UNDER STATE POLLUTANT DISCHARGE ELIMINATION SYSTEM (SPDES) GENERAL PERMIT #GP-0-20-001. THE REGULATIONS REQUIRE THAT A LICENSED PROFESSIONAL COMPLETE A WEEKLY INSPECTION (THROUGHOUT THE PERIOD OF LAND DISTURBANCE).
- 5. PRE-CONSTRUCTION THE APPROPRIATE EROSION CONTROL MEASURES AS DEFINED BY THE CONSTRUCTION DOCUMENTS SHALL BE INSTALLED PRIOR TO THE START OF ANY CONSTRUCTION ACTIVITIES. A PRE-CONSTRUCTION MEETING WITH THE TOWN OF DRYDEN SHALL OCCUR PRIOR TO THE START OF ANY CONSTRUCTION ACTIVITIES.
- 6. TOPSOIL UPON COMPLETION OF THE STOCKPILE STRIPPING OPERATION, STOCKPILES SHALL BE STABILIZED IN ACCORDANCE TO NYSDEC REGULATIONS.
- 7. SLOPES UPON COMPLETION OF GRADING, SLOPES WITH A GRADIENT OF ONE FOOT VERTICAL TO THREE FEET HORIZONTAL (1 ON 3) OR GREATER SHALL BE: TOPSOILED, SEEDED, FERTILIZED AND MULCHED OR TREATED AS SPECIFIED ON CONTRACT DRAWINGS.
- 8. DUST THE CONTRACTOR SHALL APPLY WATER AND/OR CALCIUM CHLORIDE, AS CONDITIONS WARRANT, TO CONTROL WIND BORN EROSION. THIS MEASURE APPLIES TO: HAUL ROADS, CUT AND FILL OPERATIONS, SUB-BASE AND ANY OTHER EXPOSED SURFACES.
- 9. OPERATION & MAINTENANCE THROUGHOUT THE PERIOD OF CONSTRUCTION AND PRIOR TO ESTABLISHING FINAL GROUND COVER THE SITE CONTRACTOR IS RESPONSIBLE FOR THE OPERATION AND MAINTENANCE OF THE TEMPORARY EROSION CONTROL MEASURES. FOR EXAMPLE, THE SILTATION FACILITIES SHALL BE RE-EXCAVATED WHEN THE VOLUME (3600 CUBIC FEET/DISTURBED ACRE) IS REDUCED BY ONE-HALF OR MORE OF ITS SPECIFIED CAPACITY AND/OR THE MATERIAL IS WITHIN ONE FOOT OF THE DISCHARGE POINT.
- 10. WORK STOPPAGE ALL DISTURBED AREAS NOT TO BE WORKED WITHIN 14 DAYS MUST BE SEEDED WITHIN 7 DAYS FROM THE LAST CONSTRUCTION ACTIVITY IN THAT AREA.
- 11. TEMPORARY STABILIZATION TEMPORARY STABILIZATION SHALL REQUIRE 4 TONS OF STRAW/ ACRE OF DISTURBANCE PLACED WITH TACKIFIER OR ROLLED WITH A TRACKED VEHICLE TO ENSURE NOT DISPLACED.
- 12. WINTER STABILIZATION ALL WINTER STABILIZATION METHODS IDENTIFIED IN THE NYS 'BLUE BOOK' SHALL BE FOLLOWED FOR ANY DISTURBANCE OR NON-STABILIZED AREAS FROM NOVEMBER 15TH - APRIL 1ST.
- 13. SUBSOIL RESTORATION ALL AREAS TO BE RESTORED AS LAWN SHALL BE RESTORED PER CHAPTER 5 (5.1.6) OF THE NEW YORK STATE STORMWATER DESIGN MANUAL AND THE SOIL RESTORATION TABLE (TABLE 5.3) SOIL RESTORATION REQUIREMENTS) SHOWN ON THE PLANS. THE PROJECT SOILS ARE HYDROLOGIC SOIL GROUP D AND SHALL BE RESTORED AS SPECIFIED.
- 14. SEQUENCE THE CONTRACTOR SHALL INSTALL EROSION CONTROL MEASURES IN THE FOLLOWING SEQUENCE UNLESS AUTHORIZED OTHERWISE AT PRE-CONSTRUCTION MEETING:
 - INSTALL PERIMETER SEDIMENT CONTROLS, I.E. EROSION FENCING.
 - INSTALL STABILIZED CONSTRUCTION ENTRANCE
- PROTECT VEGETATION TO REMAIN
- CLEAR/GRUB AND CONSTRUCT DIVERSIONARY SWALES, AND SEDIMENT BASINS. • COMPLETE CLEARING AND GRUBBING OPERATION.
- PLACE EROSION CONTROL MEASURES AT TOPSOIL STOCKPILES AND STRIP TOPSOIL.
- CONSTRUCT SWALES AND SILTATION DEVICES AS EARTHWORK OPERATIONS PROGRESS. MAINTAIN EROSION CONTROL MEASURES AND PLACE ADDITIONAL MEASURES AS EARTHWORK AND
- UNDERGROUND UTILITIES ARE CONSTRUCTED. • RESTORE AREAS AS DEFINED BY CONTRACT DOCUMENTS.
- REMOVE EROSION CONTROL MEASURES AS AREAS ARE REESTABLISHED WITH GROUND COVER.

UTILITIES 1. STORM

- 1.1 REGULATIONS STORM SEWERS AND APPURTENANCES SHALL BE CONSTRUCTED IN CONFORMANCE WITH THE LATEST REGULATIONS OF THE MUNICIPALITY AND ALL THERMOPLASTIC PIPE SHALL BE INSTALLED IN ACCORDANCE WITH ASTM D-2321.
- **1.2 MATERIALS** THE CONTRACTOR MAY USE THE FOLLOWING PIPE MATERIAL FOR THE MAIN SEWER AS ALLOWED BY THE MUNICIPALITY, PROVIDING THAT THE ROUGHNESS COEFFICIENT ("N" FACTOR) IS 0.013 OR
 - REINFORCED CONCRETE PIPE (RCP), CLASS III • HIGH DENSITY CORRUGATED POLYETHYLENE PIPE (PE), AASHTO M-294, TYPE S, ASTM D-3350.
- 1.3 ROOF DRAINAGE ALL ROOF DRAINAGE SHALL BE COLLECTED AND PIPED TO THE STORM SEWER SYSTEM **UNLESS SPECIFIED OTHERWISE**
- **1.4 TESTING** UPON COMPLETION OF SYSTEM INSTALLATION, THE MAIN SEWER SYSTEM AND LEADS TO STRUCTURES SHALL BE FLUSHED AND LAMPED TO THE SATISFACTION OF THE MUNICIPALITY.

TOWN OF DRYDEN MATERIAL AND PERFORMANCE STANDARDS FOR WATER SYSTEM EXTENSIONS

- 1. Water pipe Cl 52 Ductile Iron double cement lined (in accordance with AWWA C151 and AWWA C104).
- 2. Fittings Ductile Iron double cement lined (in accordance with AWWA C151 and
- 3. Services type K copper tubing (min. size determined by the design professional).
- 4. Corp stop and curb stops Brass body ball type. 5. Valves - Resilient seat gate with stainless steel bonnet blots (in accordance with AWWA C509).
- 6. Hydrants Dry barrel (5 1/4") break top type with 6" MJ connection, guard valve, anchoring tee, one 4 1/2" nozzle (NST) and two 2 1/2" nozzles (NST) in accordance with AWWA C502.
- 7. Bedding not required for mains in earth when at least 6" of earth exists beneath the
- bottom of the main (in rock it is to be bedded a minimum of 8" on all sides). 8. Pipe bedding (mains) - # 1 stone, # 2 stone or a mix of #1 and #2 stone a minimum of 8" on all sides. 1a stone bedding will not be allowed.
- 9. Refer to the Bolton Point Rules and Regulations for further information on testing and installation.
- 10. Backfill Select earth (native material 6" and smaller in size and within 2% of optimum moisture content) to 2' below asphalt subgrade within the ditchlines of an existing or proposed Town road and to the surface in other areas. The top 2' below the asphalt subgrade within the ditchlines of an existing or proposed Town road shall be Item 4 Base material as outlined in the Town Road Specifications.
- 11. Placement and compaction of backfill 8" lifts compacted to 95% of maximum density ASTM 698 between the ditch lines.
- 12. Surface restoration of existing Town roads 2.5" of Type 3-asphalt binder and 1.5"
- 13. Work within a County or State ROW will be governed by the respective standards.

TOWN OF DRYDEN MATERIAL AND PERFORMANCE STANDARDS FOR SANITARY SEWER SYSTEM EXTENSIONS

- 1. Sewer pipe SDR 35 PVC bedded a minimum of 8" on all sides.
- 2. Pipe size Main 8" (min.), Laterals 4" (min.).
- 3. Depth of cover Mains 6' min. (except 4' in areas without conflict with water mains or services), Laterals 3' min.
- 4. Pipe bedding # 1 stone, # 2 stone or a mix of #1 and #2 stone. 1a stone bedding will not be allowed.
- 5. Lateral connections to existing sewer Romac Industries Style CB sewer saddle, 4" SDR 35 PVC extended to the edge of the road Right-of-Way (ROW), cap end.
- 6. Lateral connections to new sewer SDR 35 PVC sanitary tee, extended to the edge of the road ROW, cap end.
- 7. Clean outs Shall be provided at the edge of the ROW when the homes are connected to the sewer.
- Manholes precast concrete 4' diameter (5' for 3 way or interior drop) in accordance with ASTM C478 coated inside and out (including grouted joints, benchwork, and flow channel) with 2 coats of coal tar-epoxy coating.
- 9. Benchwork and flow channel cast-in-place concrete
- 10. Flow channel walls are to be vertical from the springline of the pipe to the top of the pipe and the benchwork slope at 1/2" per foot from that point to the wall of the
- 11. Frame and cover Syracuse Castings Pattern 1009 with Flow Seal Cover (Sanitary Sewer cast into the cover in 2" letters).
- 12. Manhole steps Copolymer polypropylene encapsulated steel in accordance with ASTM C478, 12" on center.
- 13. Testing Sewer mains including laterals to the edge of the ROW shall be air tested. 14. Backfill - Select earth (native material 6" and smaller in size and within 2% of optimum moisture content) to 2' below asphalt subgrade within the ditchlines of an existing or proposed Town road and to the surface in other areas. The top 2' below the asphalt subgrade within the ditchlines of an existing or proposed Town road shall
- be Item 4 Base material as outlined in the Town Road Specifications. 15. Placement and compaction of backfill - 8" lifts compacted to 95% of maximum
- density ASTM 698 between the ditch lines. 16. Surface restoration of existing Town roads – 2.5" of Type 3-asphalt binder and 1.5" of Type 7 asphalt top.
- 17. Work within a County or State ROW will be governed by the respective standards.
- 18. Accurately record actual location of pipe runs, fittings, manholes, termination of laterals, couplings, lateral connections to the main, and invert elevations.

RESTORATION AND LANDSCAPING

- 1. GUARANTEE THE AGREEMENT BETWEEN THE OWNER AND CONTRACTOR SHALL DEFINE THE REQUIREMENTS, MAINTENANCE, AND TIME TO ESTABLISH NEW TURF AND LANDSCAPING ACCEPTANCE BY THE OWNER.
- 2. TOPSOIL PLACE A MINIMUM OF 4 INCHES (REQUIRED) OF TOPSOIL ON ALL DISTURBED SURFACES. FINE GRADE TO ESTABLISH THE DESIGN ELEVATIONS AND DRAINAGE PATTERNS. OBTAIN OWNER'S REPRESENTATIVE APPROVAL PRIOR TO SEEDING.
- 3. SEED LAWN AREAS SHALL BE HYDROSEEDED WITH AN APPROVED; SEED MIXTURE, MULCH, AND FERTILIZER. THE APPLICATION RATE SHALL BE DETERMINED BY CONTRACTOR TO ESTABLISH A "STAND" OF GRASS. THE CONTRACTOR SHALL SUBMIT MATERIAL AND APPLICATION SPECIFICATIONS TO THE OWNER'S REPRESENTATIVE FOR APPROVAL PRIOR TO APPLICATION.
- 4. PLANT STOCK PLANT MATERIALS SHALL BE IN ACCORDANCE WITH "AMERICAN STANDARD FOR NURSERY STOCK". THE CONTRACTOR SHALL SUBMIT PLANT MATERIAL SPECIFICATIONS TO THE OWNER'S ON-SITE REPRESENTATIVE FOR APPROVAL PRIOR TO DELIVERY TO THE SITE.
- 5. PLANT LOCATIONS THE PLANT LOCATIONS DEPICTED ON THE PLAN MAY BE FIELD ADJUSTED (SO THEY DO NOT INTERFERE WITH UTILITIES) AND TO THE SATISFACTION OF OWNER'S REPRESENTATIVE.
- 6. PLANTING BEDS PROVIDE TWELVE INCHES (12") OF TOPSOIL, WEED FABRIC (AS DIRECTED BY OWNER), AND THREE INCHES (3") OF MULCH AT PLANTING BEDS, UNLESS SPECIFIED OTHERWISE ON DRAWINGS.

LIGHTING NOTES

- 1. ALL LUMINARES TO BE AS SPECIFIED IN THE LUMINARE SCHEDULE ON THIS PLAN.
- 2. LIGHTING CONTOURS GENERATED USING LITEPRO SOFTWARE, VERSION 2.013 AS PROVIDED BY COLUMBIA LIGHTING, INC. AND MICROWARE CONCEPTS. LIGHTING CONTOURS REPRESENT THE ADDITIVE EFFECT OF
- 3. LIGHTING CALCULATIONS ARE PERFORMED IN ACORDANCE WITH IESNA PROCEDURES.
- 4. LIGHTING CONTRACTOR SHALL PROVIDE SHIELDS RESULTING IN ZERO LIGHT SPILLAGE TO ADJACENT
- 5. REFER TO ARCH, PLANS FOR ROUTING OF SITE ELECTRICAL.

GENERAL

- APPLICABILITY THE NOTES AND INFORMATION PROVIDED ON THIS SHEET ARE APPLICABLE TO ALL "C" SERIES DRAWINGS. THE "C" SERIES DRAWINGS COVER SITE RELATED IMPROVEMENTS OUTSIDE THE BUILDING ENVELOPE. THE BUILDING ENVELOPE INCLUDES ALL AREA WITHIN 5' OUTSIDE OF THE BUILDING'S EXTERIOR WALL.
- MAPPING THE EXISTING UNDERGROUND UTILITIES WERE PLOTTED BASED ON RECORD MAPPING SUPPLIED BY OTHERS. THE ENGINEER MAKES NO WARRANTY AS TO THE LOCATION, SIZE, TYPE, ELEVATION, AND/OR NUMBER OF EXISTING UTILITIES. THE CONTRACTOR SHALL BE RESPONSIBLE FOR DETERMINING THE HORIZONTAL AND VERTICAL LOCATION OF UTILITIES IN THE VICINITY OF THE NEW INFRASTRUCTURE.
- 3. UTILITY STAKEOUT THE CONTRACTOR SHALL NOTIFY UDIG NY (1-800-962-7962) FOR A UTILITY STAKEOUT 48 HOURS IN ADVANCE OF COMMENCING WORK. STAKEOUT OF PRIVATE UTILITIES SHALL BE COORDINATED WITH THE
- 4. PROPERTY PROTECTION THE CONTRACTOR IS RESPONSIBLE FOR DAMAGE TO EXISTING PAVEMENT, CURBS, WALKS, LAWNS, TREES, ETC. CAUSED BY THEIR CONSTRUCTION OPERATIONS. ALL DAMAGE SHALL BE REPAIRED OR REPLACED BY THE CONTRACTOR TO THE OWNER'S SATISFACTION AT NO ADDITIONAL EXPENSE.
- 5. ACCESS THE CONTRACTOR SHALL PROVIDE SATISFACTORY VEHICULAR ACCESS TO ALL ADJOINING PROPERTIES, PRIVATE ROADWAYS, PARKING FACILITIES, AND PUBLIC STREETS DURING CONSTRUCTION.
- 6. SITE SAFETY PRIOR TO AND THROUGHOUT CONSTRUCTION, THE CONTRACTOR SHALL POST SIGNAGE IN CONFORMANCE WITH THE REQUIREMENTS OF THE LOCAL MUNICIPALITY AND OCCUPATIONAL HEALTH AND SAFETY ACT (OHSA). JOB SAFETY AND MAINTENANCE AND PROTECTION OF TRAFFIC IS THE RESPONSIBILITY OF THE CONTRACTOR.
- **EXCAVATIONS** ALL EXCAVATIONS SHALL BE BACKFILLED/BARRICADED TO THE SATISFACTION OF THE OWNER'S REPRESENTATIVE AT THE CONCLUSION OF EACH WORKING DAY.
- MAINTENANCE PUBLIC STREETS, PRIVATE DRIVES AND PARKING FACILITIES SHALL BE KEPT FREE OF FOREIGN MATERIALS. ALL AREAS SHALL BE SWEPT CLEAN AT THE END OF EACH WORKING DAY AND/OR AS DIRECTED BY THE OWNER'S ON-SITE REPRESENTATIVE.
- 9. CONSTRUCTION STORAGE STORAGE OF EQUIPMENT AND MATERIALS SHALL BE WITHIN A SPECIFIED AND SECURED AREA AS DETERMINED IN CONTRACT DOCUMENTS OR AS SPECIFIED BY THE OWNER'S ON-SITE
- 10. PERMIT(S) PRIOR TO CONSTRUCTION. THE CONTRACTOR SHALL OBTAIN THE NECESSARY PERMITS FROM THE APPLICABLE MUNICIPALITY OR AGENCY. THE CONTRACTOR IS RESPONSIBLE FOR ALL BONDS AND INSURANCES AND THE OWNER IS RESPONSIBLE FOR PERMIT FEES UNLESS OTHERWISE STATED IN THE OWNER/ CONTRACTOR
- 11. INTERIM CONDITIONS THE CONTRACTOR IS RESPONSIBLE TO MAINTAIN POSITIVE DRAINAGE AWAY FROM BUILDINGS AND WITHIN PROJECT AREA TO A STABILIZED OUTLET THROUGHOUT THE CONSTRUCTION PERIOD. THIS MAY REQUIRE INTERIM GRADING, SHIMMING OF PAVEMENT ETC. THAT IS NOT SPECIFICALLY SHOWN ON THE PLANS AND SHALL BE THE RESPONSIBILITY OF THE CONTRACTOR.
- 12. SPECIFICATIONS TECHNICAL SPECIFICATIONS, IF SUPPLIED AS PART OF CONTRACT DOCUMENTS, ARE INTENDED TO AID AND HELP DEFINE THE CONTRACTOR'S WORK SCOPE. IF DISCREPANCIES OCCUR THE CONTRACTOR SHALL REQUEST A CLARIFICATION.

CONSTRUCTION

- 1. STAKEOUT THE CONSTRUCTION STAKEOUT SHALL BE PERFORMED BY A LICENSED LAND SURVEYOR USING CONTROL PROVIDED ON THE "LAYOUT PLAN". THE BUILDING FOOTPRINT(S), DATED 12/23/22, WERE PROVIDED BY HOLT ARCHITECTURE. DISCREPANCIES WITH BUILDING(S), CONTROL POINTS, AND/ OR TIE DIMENSIONS SHALL BE REPORTED TO THE DESIGN ENGINEER (PRIOR TO THE INSTALLATION OF IMPROVEMENTS) FOR COORDINATION AND CLARIFICATION.
- **BOUNDARY** BOUNDARY INFORMATION WAS TAKEN FROM BOUNDARY AND TOPOGRAPHIC MAP PREPARED BY TG MILLER ENGINEERS AND SURVEYORS DATED 10/21/2015 AND IS SHOWN FOR GRAPHICAL REPRESENTATION ONLY.
- 3. LAYOUT DIMENSIONS SHOWN, WHERE APPLICABLE, SHALL BE FROM THE FACE OF CURB UNLESS SPECIFICALLY CALLED OUT OTHERWISE.
- **DEMOLITION** CLEARING AND GRUBBING SHALL BE LIMITED TO THE SITE BOUNDARIES OR WITHIN THE "WORK LIMIT LINE" AS DEFINED ON THE PLAN. TREES AND OBJECTS DESIGNATED FOR REMOVAL SHALL BE COORDINATED AND FIELD VERIFIED WITH PROJECT ON-SITE REPRESENTATIVE. ALL MATERIALS SHALL BE LEGALLY DISPOSED OF OFF-SITE OR RETURNED TO OWNER AS DIRECTED BY CONTRACT DOCUMENTS. ALL ITEMS NOT SPECIFICALLY CALLED OUT TO BE REMOVED SHALL REMAIN
- **COORDINATION** THE CONTRACTOR SHALL COORDINATE INSTALLATION OF UTILITY WORK WITH OTHER SITE UTILITIES (I.E. GAS, ELECTRIC, LIGHTING, COMMUNICATIONS) TO AVOID POTENTIAL INSTALLATION CONFLICTS.
- 6. STAGING AS DEFINED BY THE CONTRACT DOCUMENTS THE CONTRACTOR SHALL CONSTRUCT A SECURE STAGING AREA FOR STORAGE OF EQUIPMENT, MATERIALS, EMPLOYEE PARKING AND OFFICE SPACE. IF THE AREA/METHOD IS NOT SPECIFICALLY DEFINED ON THE DOCUMENTS THEN IT SHALL BE COORDINATED WITH THE OWNER'S ON-SITE REPRESENTATIVE.
- **CLOSE-OUT** THE CONTRACTOR'S WORK SCOPE INCLUDES BUT IS NOT LIMITED TO THE FOLLOWING AT PROJECT
- CLOSE-OUT TO THE SATISFACTION OF OWNER'S ON-SITE REPRESENTATIVE: REMOVAL OF ANY CONSTRUCTION DEBRIS
- CLEANING PAVEMENT AND WALKWAY SURFACES.
- RESTORATION OF ALL DISTURBED GRASS AND LANDSCAPED AREAS. • PROVIDING BONDS, GUARANTEES, CERTIFICATIONS, ETC. AS REQUIRED BY CONTRACT DOCUMENTS.
- PROVIDING REDLINES FOR RECORD DRAWING.
- COMPLETION OF FINAL PUNCH LIST ITEMS.

EARTHWORK

- 1. **PREPARATION** PRIOR TO START OF EARTHWORK OPERATIONS THE CONTRACTOR SHALL COMPLETE THE FOLLOWING APPLICABLE ITEMS AS DEFINED BY CONTRACT DOCUMENTS:
- SITE DEMOLITION REMOVAL AND DISPOSAL OFF-SITE IN A LEGAL MANNER; STRUCTURES, UTILITIES, PAVEMENTS FTC
- CLEARING AND GRUBBING REMOVAL AND DISPOSAL OFF-SITE IN A LEGAL MANNER; TREES, BRUSH, STUMPS,
- TOPSOIL STRIPPING STRIP AND STOCKPILE TOPSOIL FOR REUSE. EXCESS TOPSOIL MAY BE REMOVED FROM SITE WITH APPROVAL BY OWNER AND MUNICIPALITY.
- 2. **RESPONSIBILITY** THE CONTRACTOR IS RESPONSIBLE FOR:
- ESTIMATE COMPLETION OF A QUANTITY TAKEOFF TO DETERMINE THE VOLUME OF CUT, FILL, AND TOPSOIL. COMPARE AND COORDINATE WITH INFORMATION PROVIDED BY THE DESIGN ENGINEER.
- GRADE TOLERANCES ESTABLISHING DESIGN SUBGRADE ELEVATIONS TO WITHIN ONE TENTH OF ONE FOOT (0.10') IN PAVEMENT AREAS (INCLUDING WALKS) AND TO WITHIN THIRTY-THREE HUNDREDTHS OF ONE FOOT (0.33') FOR ALL REMAINING AREAS.
- COMPACTION ACHIEVING THE SPECIFIED MINIMUM COMPACTION VALUES FOR EMBANKMENT/FILL AREAS. THE TERMS "FILL" AND EMBANKMENT" ARE INTERCHANGEABLE.
- CUTS ONCE EXCAVATIONS ARE SHAPED TO THE DESIGN GRADES THE AREAS SHALL BE PROTECTED TO ASSURE THAT THE INTEGRITY OF MATERIAL IS NOT COMPROMISED BY CONSTRUCTION VEHICLES AND/OR IMPROPER DRAINAGE. AREAS DETERMINED BY CONTRACTOR TO BE **NOT** SUITABLE FOR SUBGRADE PLACEMENT SHALL BE IMMEDIATELY REPORTED WHEN THE SUBGRADE IS ESTABLISHED TO OWNER'S REPRESENTATIVE. STABILIZATION MEASURES FOR CUT AREAS MAY BE CONSIDERED BY OWNER'S REPRESENTATIVE AS A CHANGE TO THE BASE
- 3. TESTING THE FOLLOWING MAXIMUM DRY DENSITIES SHALL BE ACHIEVED AS MEASURED BY THE MODIFIED PROCTOR METHOD ASTM D-1557
- 95% UNDER PAVEMENTS, WALKS, AND IN STRUCTURAL FILL AREAS

• 85% IN REMAINING AREAS THE AGREEMENT BETWEEN THE OWNER AND CONTRACTOR SHALL DEFINE THE NUMBER OF TESTS AND

4. LIFT THICKNESS - THE MAXIMUM LIFT THICKNESS UNDER PAVEMENTS, WALKS, AND STRUCTURAL FILLS SHALL BE 12 INCHES. HAND OPERATED COMPACTION FILLS SHALL NOT EXCEED 6 INCHES.

RESPONSIBILITY. WE RECOMMEND IN EMBANKMENT AREAS ONE PER LIFT AND/OR ONE PER 1,000 CUBIC YARDS.

5. PROOF ROLLING - THE OWNER'S REPRESENTATIVE MAY REQUEST A PROOF ROLL (I.E. LOADED TEN WHEELER) OF SUBGRADE AREAS PRIOR TO PLACEMENT OF SUBBASE MATERIALS. AREAS THAT "FAIL" SHALL BE REMOVED AND REPLACED TO ACHIEVE A PASSING SUBGRADE.

SEED & MULCH

SEED MIX SHALL BE TOWN & COUNTRY SEED MIX AS MANUFACTURED BY CROSSMAN SEED CORPORATION. SEED MIX SHALL CONSIST OF:

> 30% CREEPING RED FESCUE 20% GATOR 3 PERENNIAL RYEGRASS 20% ALL STAR 3 PERENNIAL RYEGRASS

20% KEYSTONE 2 PERENNIAL RYEGRASS

10% KENTUCKY BLUEGRASS 98 / 85 SEEDING RATE SHALL BE 6LBS./ 1000 S.F. OF PURE LIVE SEED.

MULCH: SHALL BE STRAW APPLIED AT 2 TONS/ACRE

ENGINEERING

39 CASCADE DRIVE ROCHESTER, NY 14614 5 8 5 - 4 5 8 - 7 7 7 0 ITHACA LOCATION 840 HANSHAW RD, STE 6 ITHACA, NY 14850 6 0 7 - 2 4 1 - 2 9 1 7

www.marathoneng.com

4

Σ

0

ROCHESTER LOCATIO

JOB NO: 1495-22 SCALE: 1"=30' DRAWN: RLJ DESIGNED: **AMF** DATE: 8/30/23 REVISIONS DATE BY REVISION 9/21/23 AF TOWN SUBMITTAL

IONAL ENGINEER OR LAND SURVEYOR, IF AN ITEM BEARING THE SEAL COPYRIGHT© 2023 MARATHON ENG

NY PERSON, UNLESS ACTING UNDER THE DIRECTION OF A LICENSED PROFESS NGINEER OR LAND SURVEYOR, TO ALTER IN ANY WAY, AN ITEM BEARING THE SEA


ADAM M. FISHEL **DRAWING TITLE:**

Notes Sheet

JOB No:

SHEET No: 1495-22

DRAWING No:

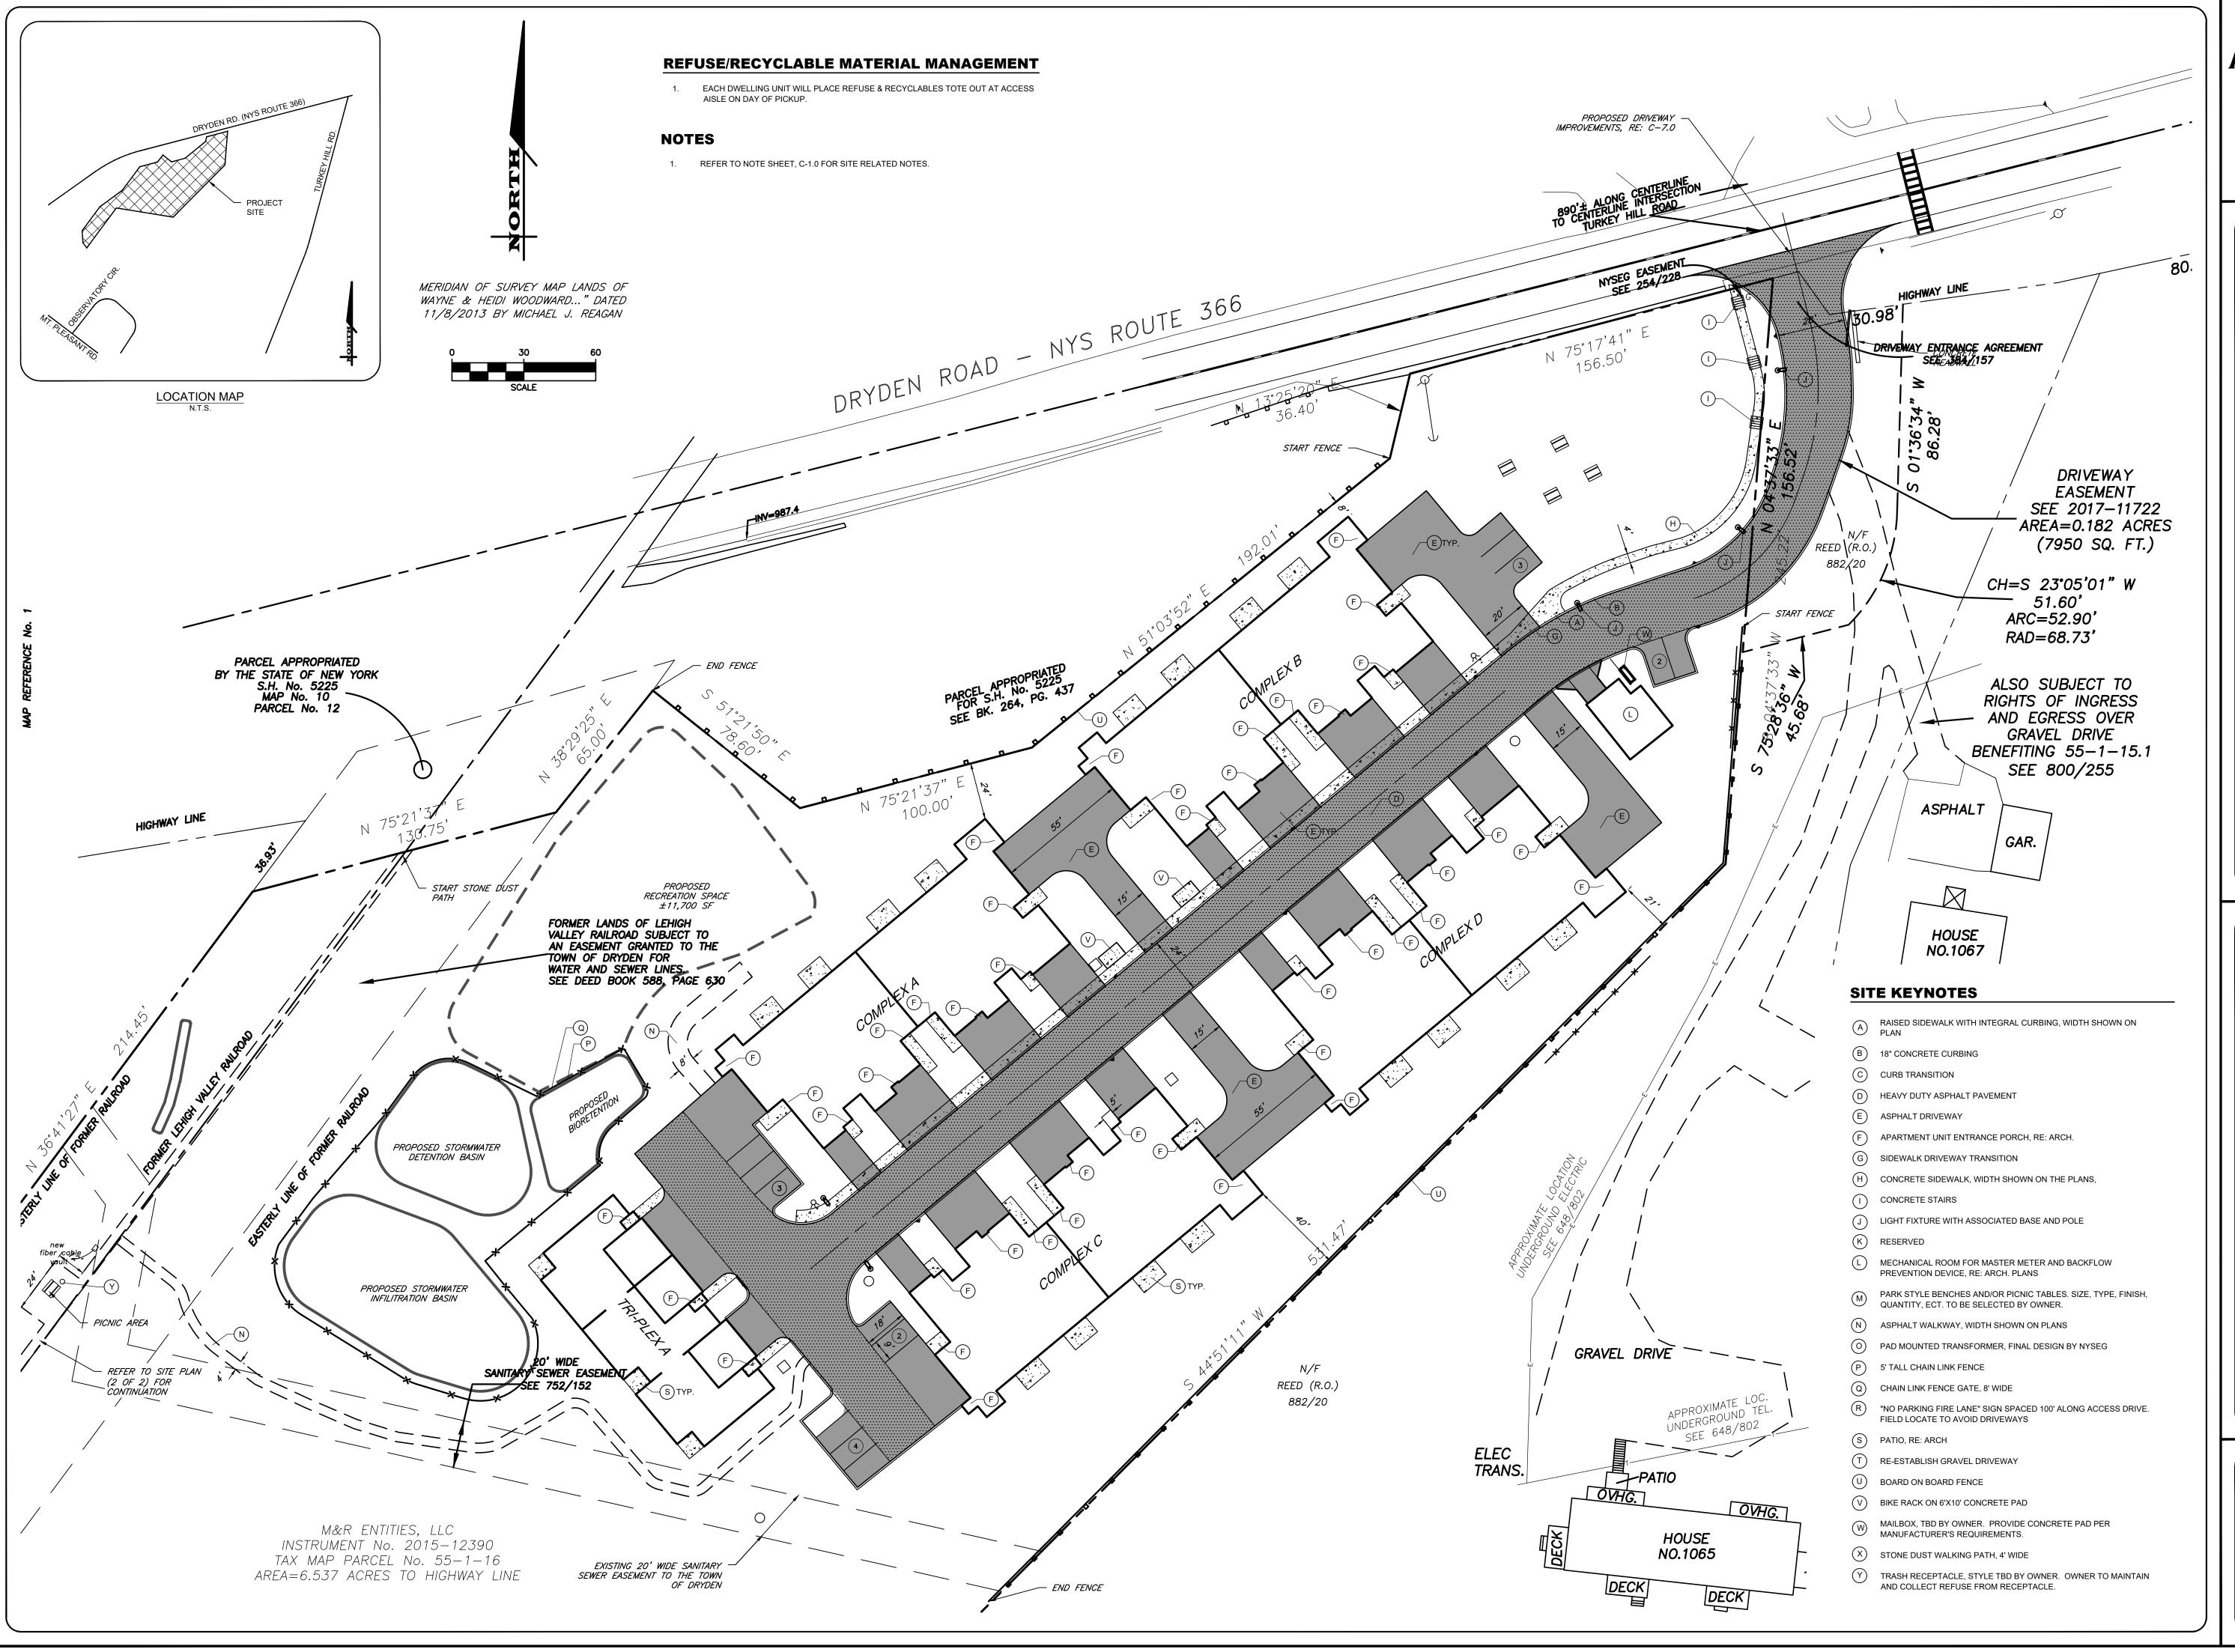

MARATHON ENGINEERING

3 9 CASCADE DRIVE
ROCHESTER, NY 14614
5 8 5 - 4 5 8 - 7 7 7 0

ITHACA LOCATION

840 HANSHAW RD, STE 6
ITHACA, NY 14850
6 0 7 - 2 4 1 - 2 9 1 7

6 0 7 - 2 4 1 - 2 9 1 7 www.marathoneng.com

DRYDEN ROAD (NYS ROUTE 366)

OPMENT

JOB NO: 1495-22
SCALE: 1"=30'
DRAWN: RLJ
DESIGNED: AMF
DATE: 8/30/23
REVISIONS

DATE BY REVISION

9/21/23 AF TOWN SUBMITTAL

DRAWING TITLE:
Site Plan


2 of 17
SHEET No:

DRAWING No:

1495-22 JOB No:

COPYRIGHT $^{\odot}$ 2023 MARATHON ENG.

CONSTRUCTION

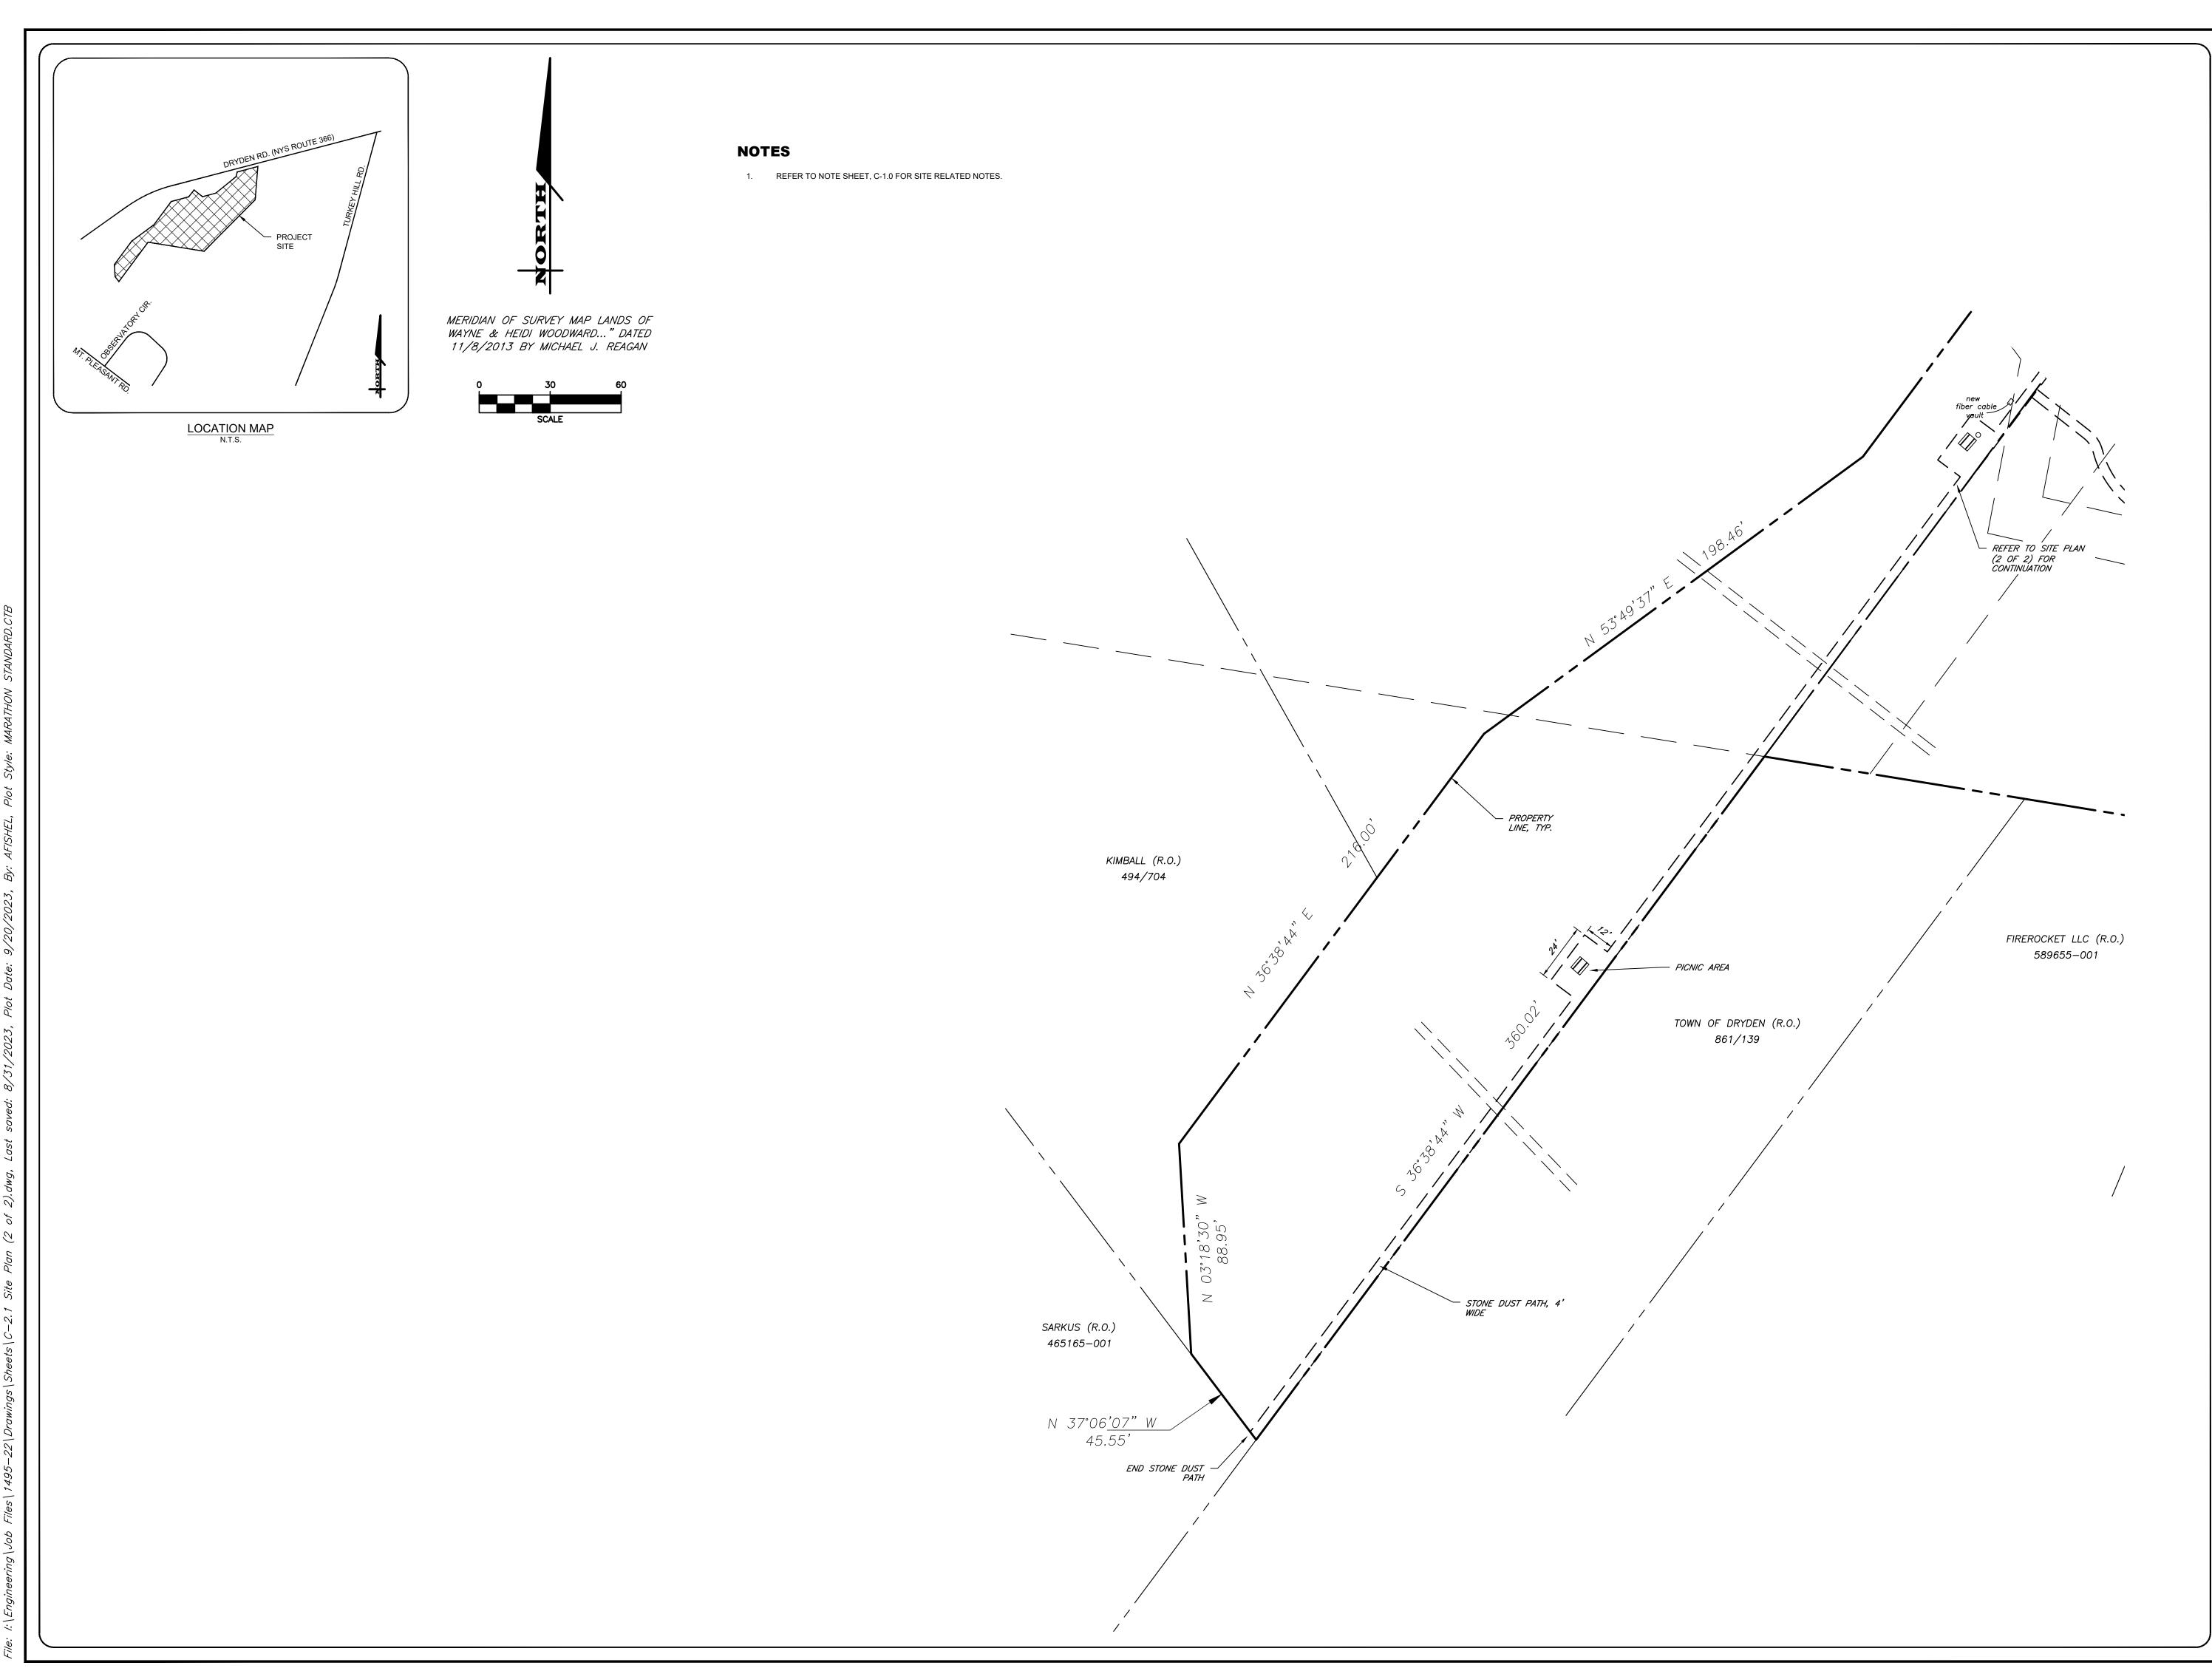

3 9 CASCADE DRIVE
ROCHESTER, NY 14614
5 8 5 - 4 5 8 - 7 7 7 0
ITHACA LOCATION
840 HANSHAW RD, STE 6
ITHACA, NY 14850
6 0 7 - 2 4 1 - 2 9 1 7

6 0 7 - 2 4 1 - 2 9 1 7 www.marathoneng.com

S) STATE OF NEW YO

YDEN, LLC ROAD (NYS ROUTE 366) PKINS COUNTY

> 106 N OF DRYDEN

JOB NO: 1495-22

SCALE: 1"=30'

DRAWN: RLJ

DESIGNED: AMF

DATE: 8/30/23

REVISIONS

DATE BY REVISION

9/21/23 AF TOWN SUBMITTAL

TI IS A VIOLATION OF NEW YORK STATE EDUCATION LAW ARTICLE 145, SECTION 7209 FOR ANY PERSON, UNILESS ACTING UNDER THE DIRECTION OF A LICENSED PROFESSIONAL ENGINEER OR LAND SURVEYOR, TO ALTER IN ANY WAY, AN TEM BEARING THE SEAL OF A PROFESSIONAL ENGINEER OR LAND SURVEYOR IS ALTERED. THE ALTERNIE GENGINEER OR LAND SURVEYOR SHALL AFEIX TO THE ITEM THEIR SEAL AND THE NOTATION "ALTERED BY FOLLOWED BY THEIR SIGNATURE AND THE DATE OF SUCH ALTERATION, AND A SPECIFIC DESCRIPTION OF THE ALTERNIE AND THE DATE OF SUCH ALTERATION, AND A SPECIFIC DESCRIPTION OF THE ALTERNIE AND THE DATE OF SUCH ALTERATION, AND A SPECIFIC DESCRIPTION OF THE ALTERRATION.

COPYRIGHT© 2023 MARATHON ENG.


DRAWING TITLE:
Site Plan (2 of 2)

ADAM M. FISHEL

3 of 17
SHEET No:

1495-22

JOB No: DRAWING No:

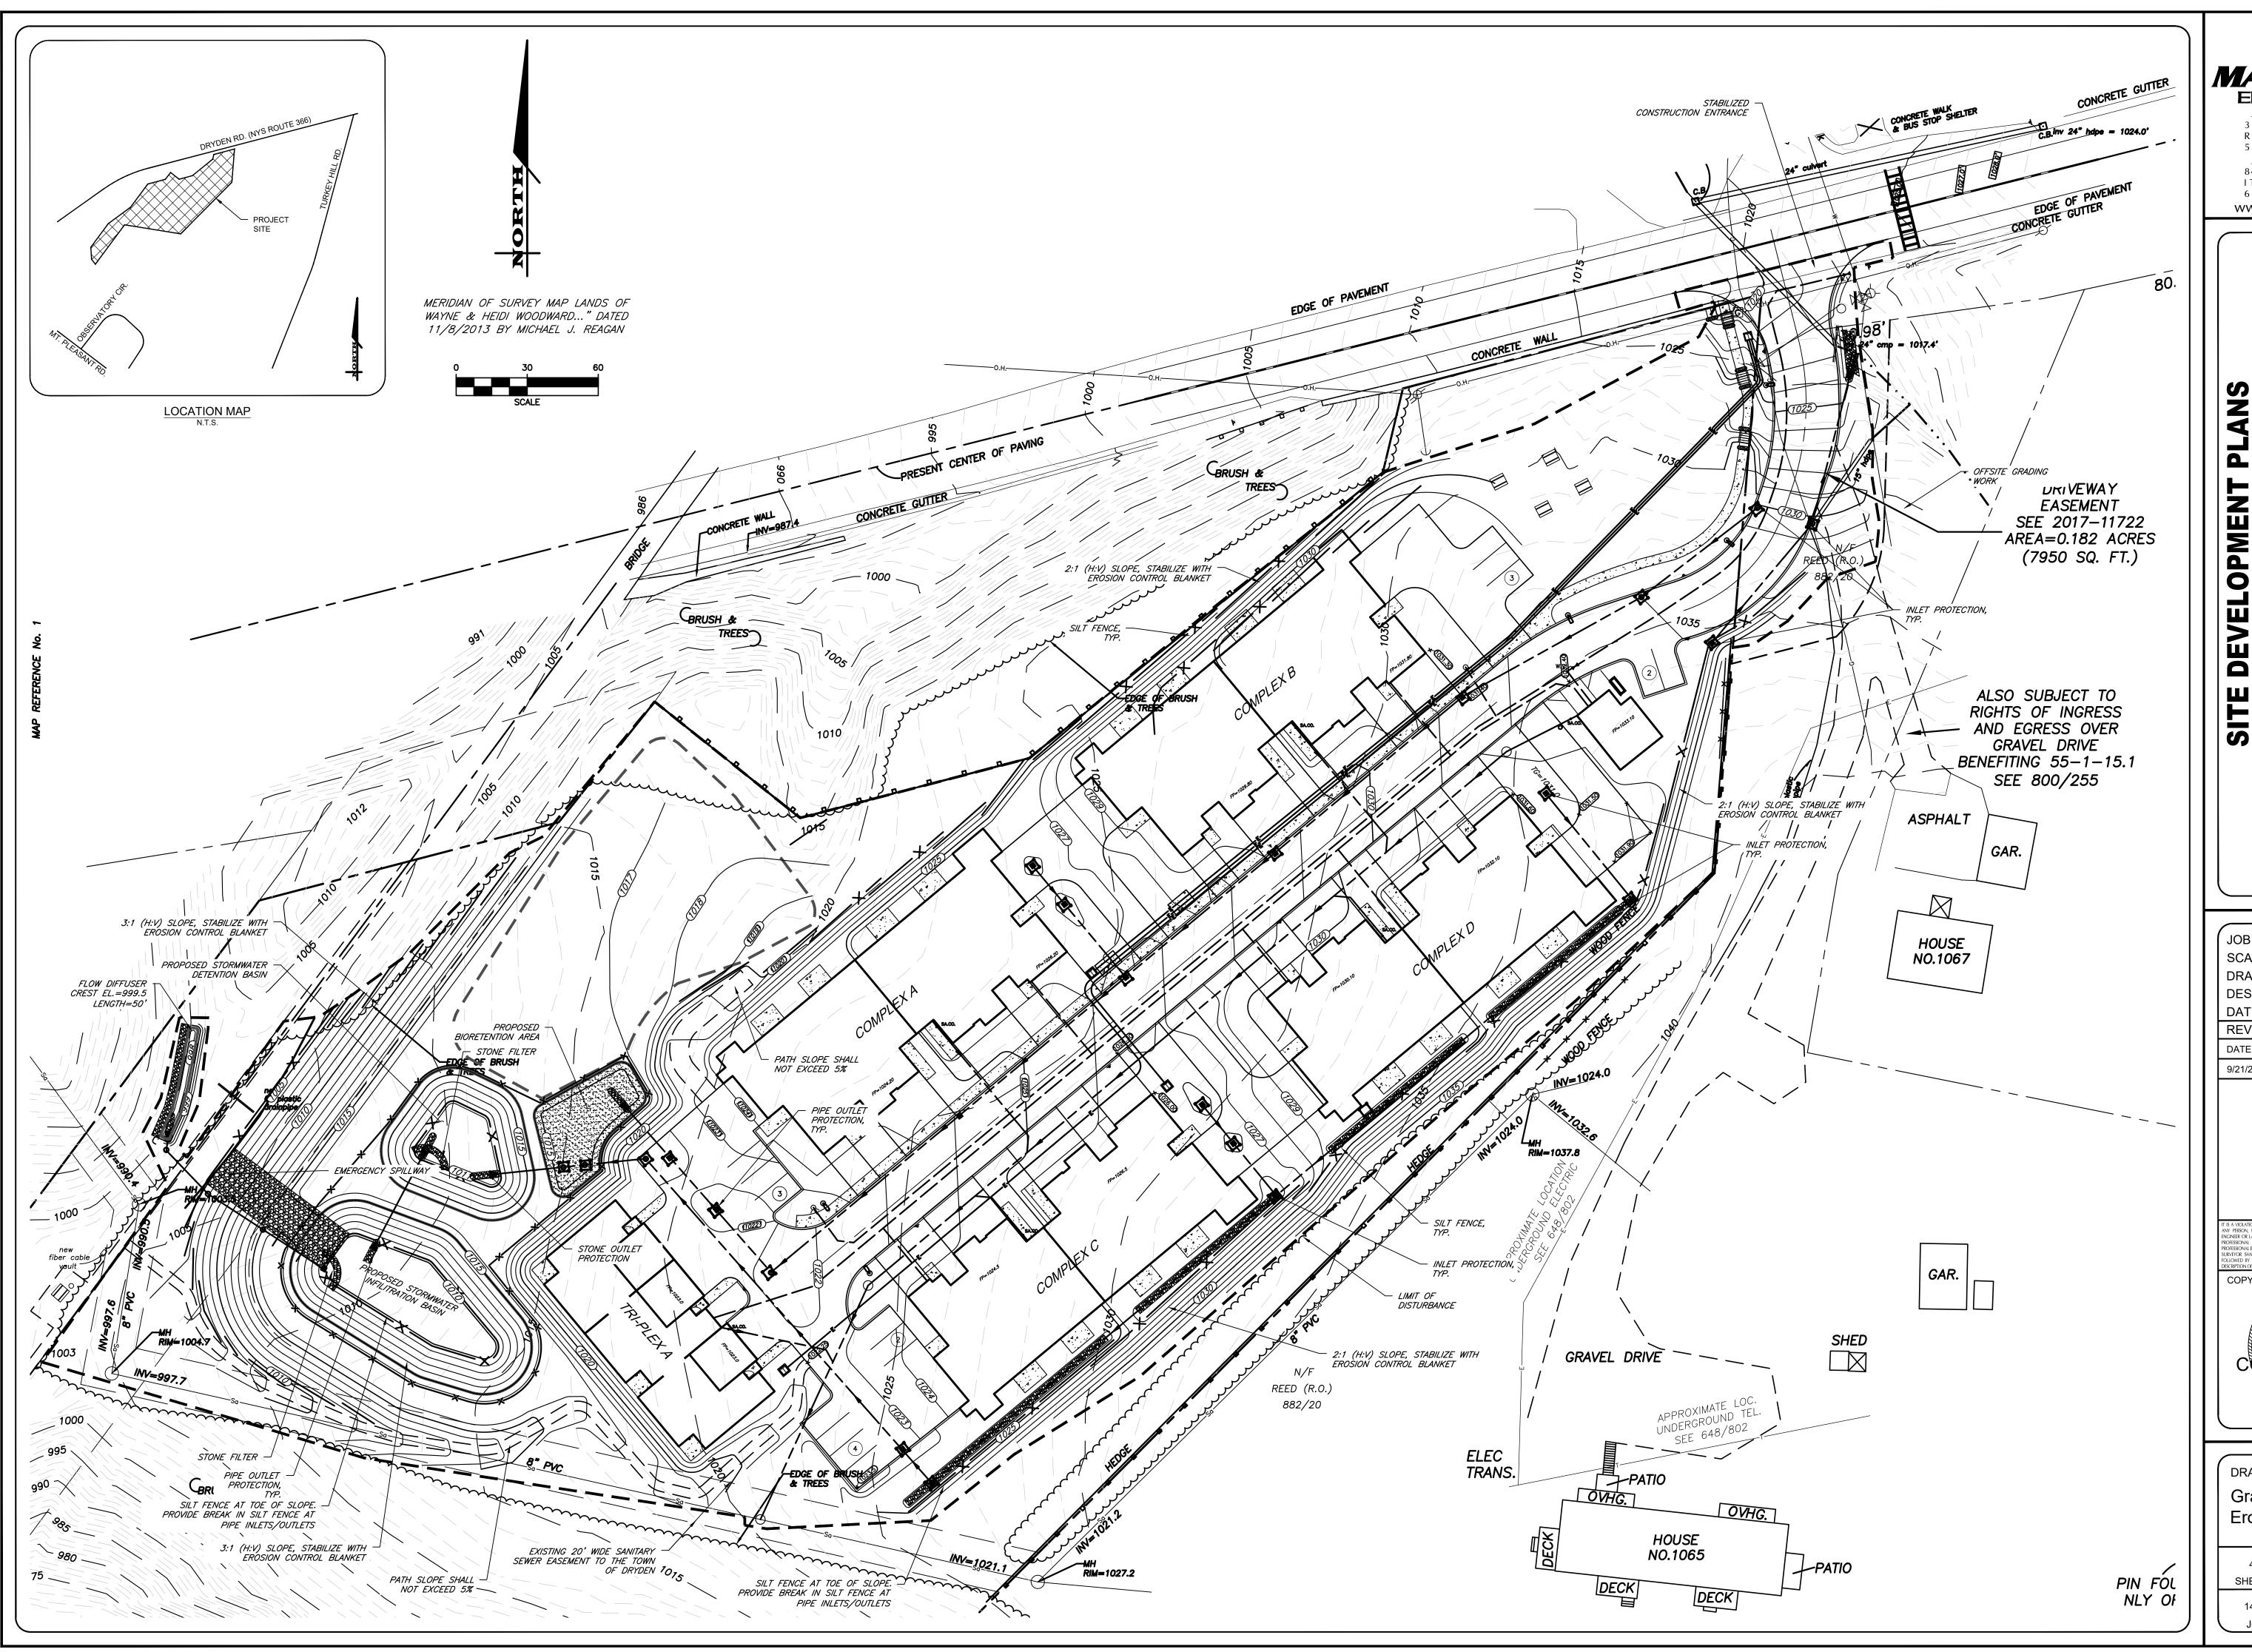

3 9 CASCADE DRIVE ROCHESTER, NY 14614 5 8 5 - 4 5 8 - 7 7 7 0 ITHACA LOCATION 840 HANSHAW RD, STE 6 ITHACA, NY 14850

1THACA, NY 14850 6 0 7 - 2 4 1 - 2 9 1 7 www.marathoneng.com

AKIMENI EN, LLG IYS ROUTE 366)

1061 DRYDEN ROAD (NYS ROAD) TOMPKINS COUNTY

JOB NO: 1495-22

SCALE: 1"=30'

DRAWN: RLJ

DESIGNED: AMF

DATE: 8/30/23

REVISIONS

DATE BY REVISION

9/21/23 AF TOWN SUBMITTAL

IT IS A MICLATION OF NEW YORK STATE EDUCATION LAW ARTICLE 145. SECTION 7:209 FOR ANY PBISON, UNIESS ACTING UNDER THE DIRECTION OF A LICENSED PROFESSIONAL ENGINEER OR LAND SURVEYOR. IF AN ITEM BEARING THE SEAL OF A PROFESSIONAL BYGINEER OR LAND SURVEYOR. IF AN ITEM BEARING THE SEAL OF A PROFESSIONAL BYGINEER OR LAND SURVEYOR. IF AN ITEM BEARING THE SEAL OF A PROFESSIONAL BYGINEER OR LAND SURVEYOR STALL AFTEX TO THE ITEM THEIR STAL AND THE NOTATION "ALTERED BY TOLLOWED BY THER SIGAALIZE AND THE AUTE OF SUCH ALTERATION, AND A SPECIFIC DESCRIPTION OF THE ALTERATION.

COPYRIGHT© 2023 MARATHON ENG.

Grading, Drainage & Erosion Control Plan


CONSTRUCTION

ADAM M. FISHEL

4 of 17
SHEET No:

1495-22

JOB No: DRAWING No:

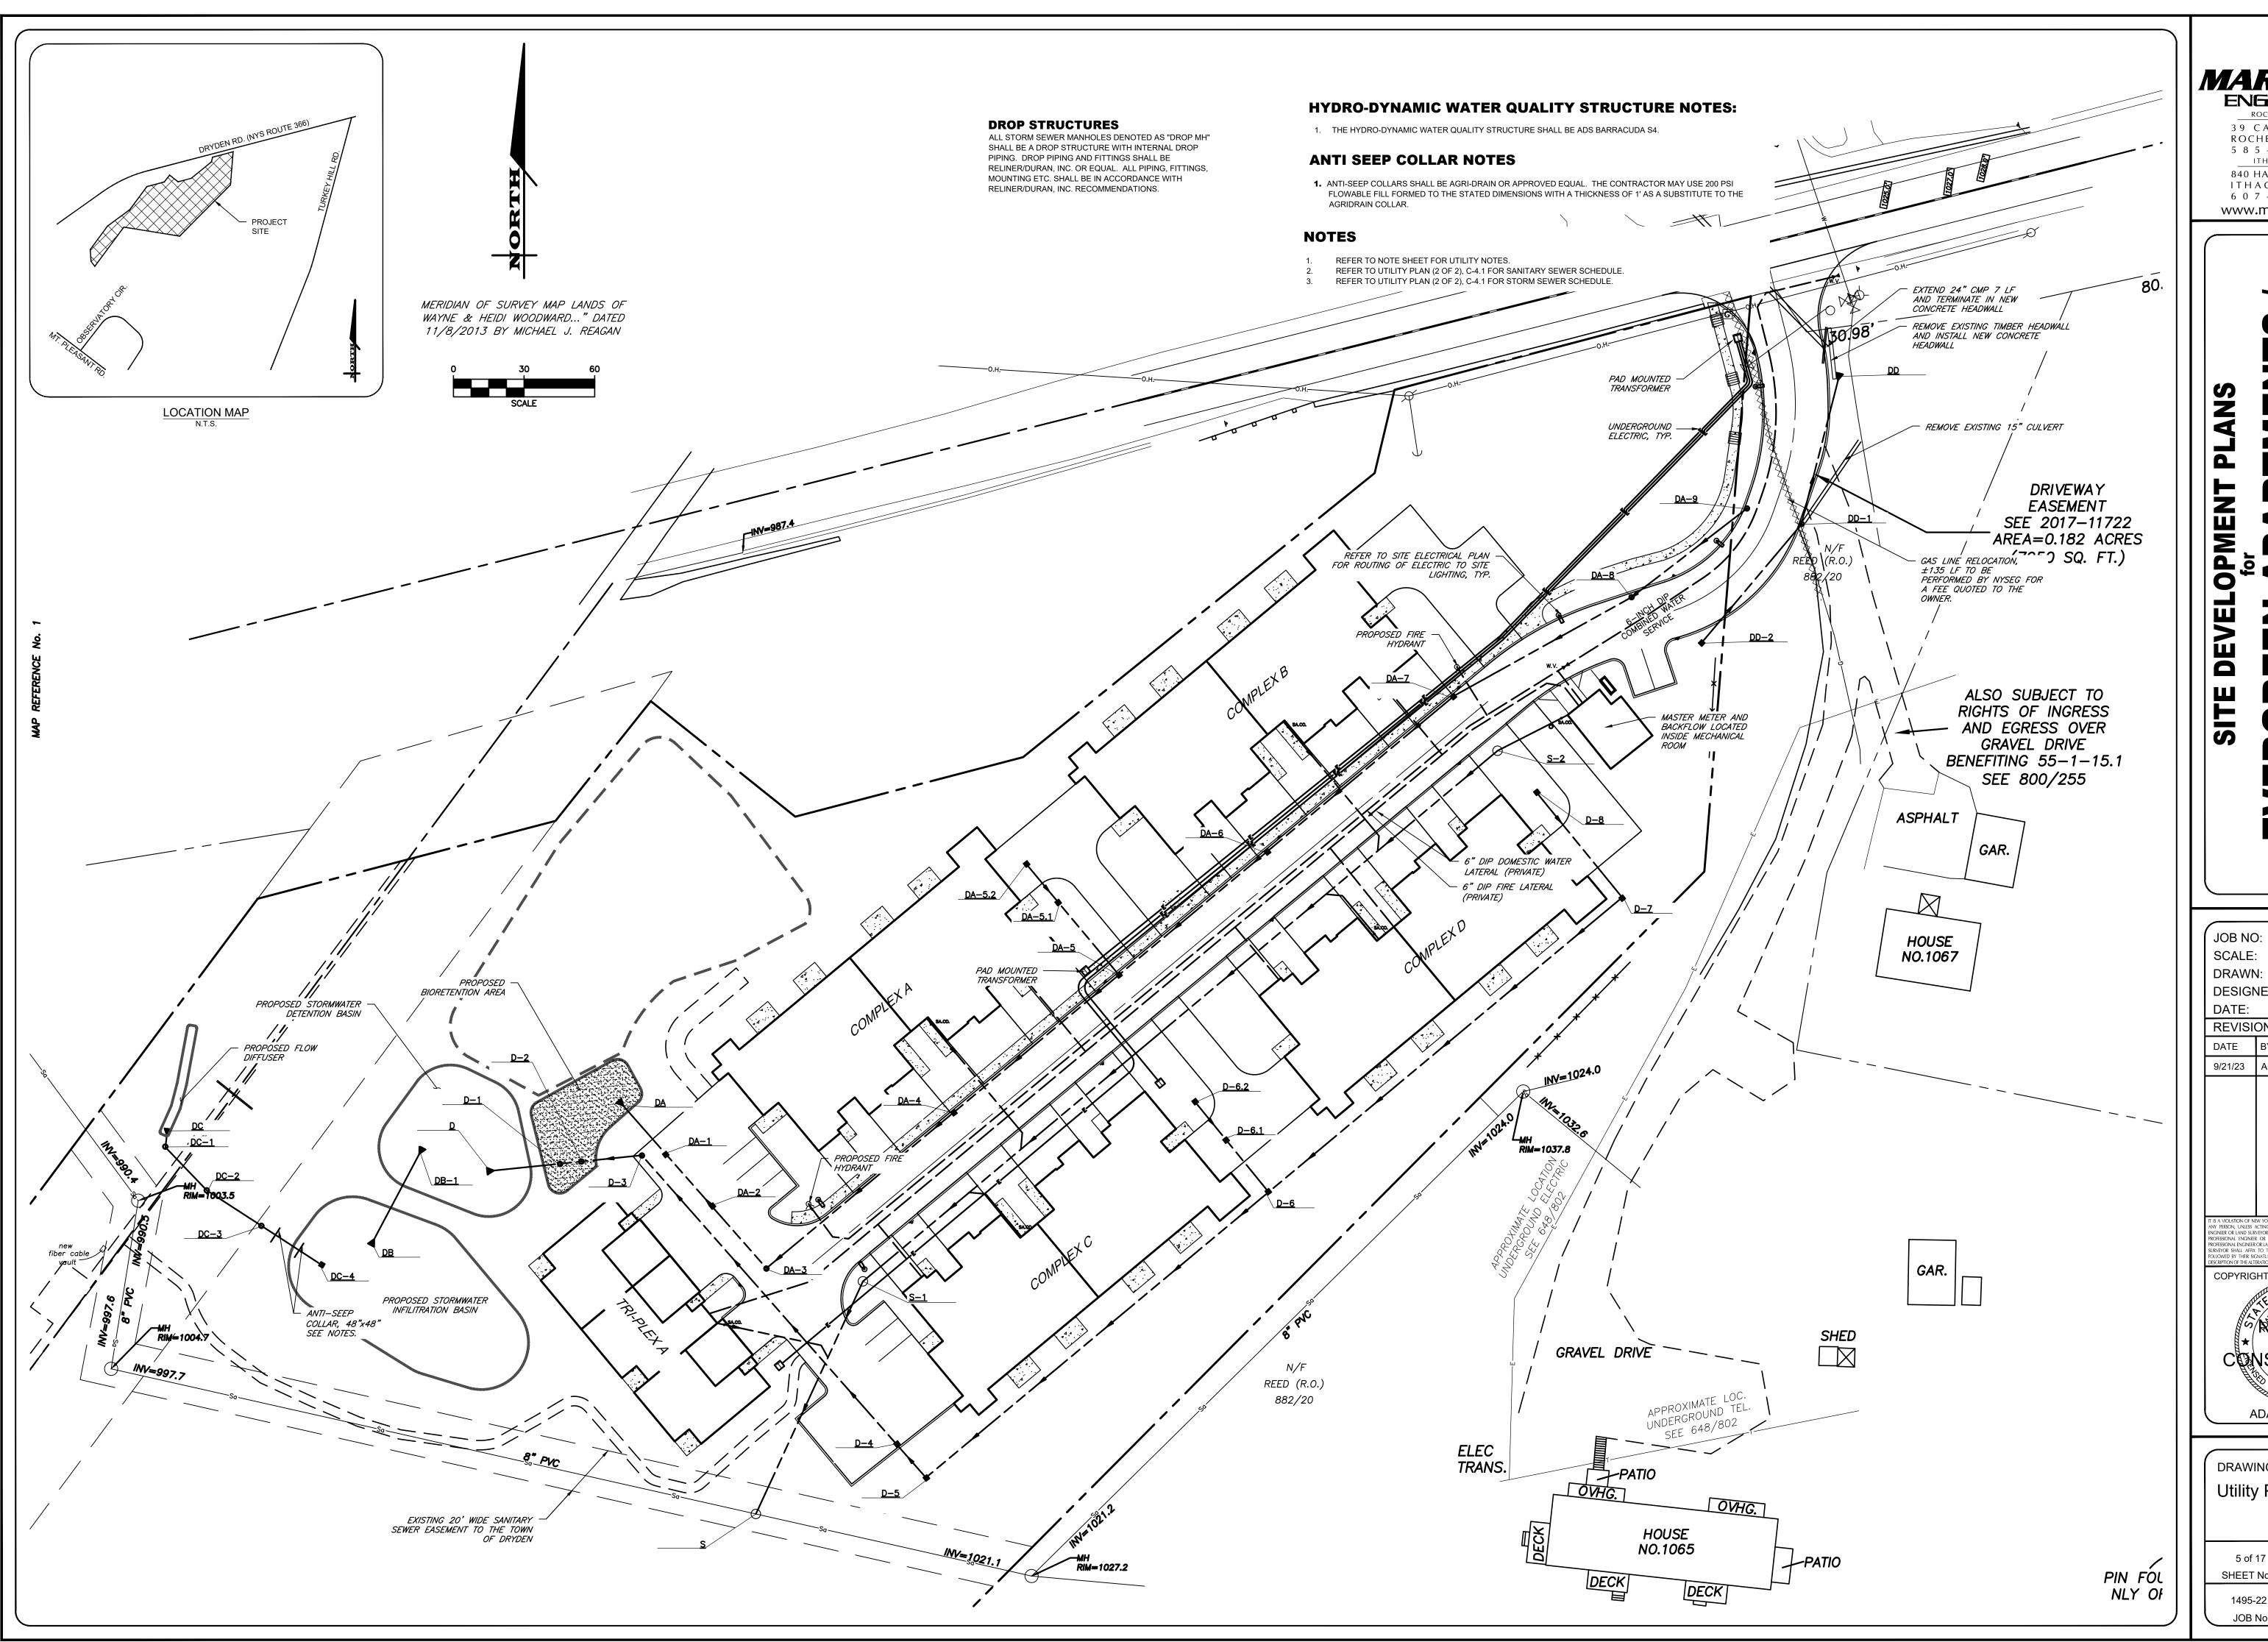

39 CASCADE DRIVE ROCHESTER, NY 14614 5 8 5 - 4 5 8 - 7 7 7 0 ITHACA LOCATION

840 HANSHAW RD, STE 6 ITHACA, NY 14850 6 0 7 - 2 4 1 - 2 9 1 7 www.marathoneng.com

1495-22 1"=30' DESIGNED: 8/30/23 REVISIONS

DATE BY REVISION 9/21/23 AF TOWN SUBMITTAL

COPYRIGHT©2<u>023 M</u>ARATHON ENG

CONSTRUCTION ADAM M. FISHEL

DRAWING TITLE: Utility Plan (1 of 2) SHEET No:

DRAWING No:

1495-22



SANITARY SEWER SCHEDULE

STRUCTURE ID	STRUCTURE TYPE	TOP OF RIM	INVERT OUT	INVERT IN	LENGTH (FT)	PIPE DIA. & MAT'L	SLOPE (%)
S-2 S-2 TO S-1	PROPOSED 4' DIA. MANHOLE	1032.00	1022.40	1022.50	161	6" PVC.	3.00%
S-1 S-1 TO S	PROPOSED 4' DIA. MANHOLE	1023.40	1017.47	1017.57	109	6" PVC.	3.00%
S	PROPOSED 4' DIA. DOG HOUSE	1020.80	1014.10	1014.20	-	-	

(1) INVERT ELEVATION OF EXISTING SANITARY SEWER SHOWN IS APPROXIMATE. CONTRACTOR TO CONFIRM PRIOR TO

MARATHON
ENGINEERING
ROCHESTER LOCATION

3 9 CASCADE DRIVE ROCHESTER, NY 14614 5 8 5 - 4 5 8 - 7 7 7 0 ITHACA LOCATION 840 HANSHAW RD, STE 6 ITHACA, NY 14850 607-241-2917

www.marathoneng.com


DEVE

JOB NO) :	1495-22		
SCALE		1"=30'		
DRAWN	1 :	RLJ		
DESIGN	NED:	AMF		
DATE:		8/30/23		
REVISI	SNC			
DATE	BY	REVISION		
9/21/23	AF	TOWN SUBMITTAL		
		nte education law article 145, section 7209 for		
IGINEER OR LAND SUR OFESSIONAL ENGINEEI	VEYOR, TO A	DER THE DIRECTION OF A LICENSED PROFESSIONAL LITER IN ANY WAY, AN ITEM BEARING THE SEAL OF A SURVEYOR. IF AN ITEM BEARING THE SEAL OF A DIRECTOR SEAL TERRING THE SEAL OF A		

COPYRIGHT© 2023 MARATHON ENG. ADAM M. FISHEL

DRAWING TITLE: Utility Plan (2 of 2)

SHEET No: 1495-22 DRAWING No:

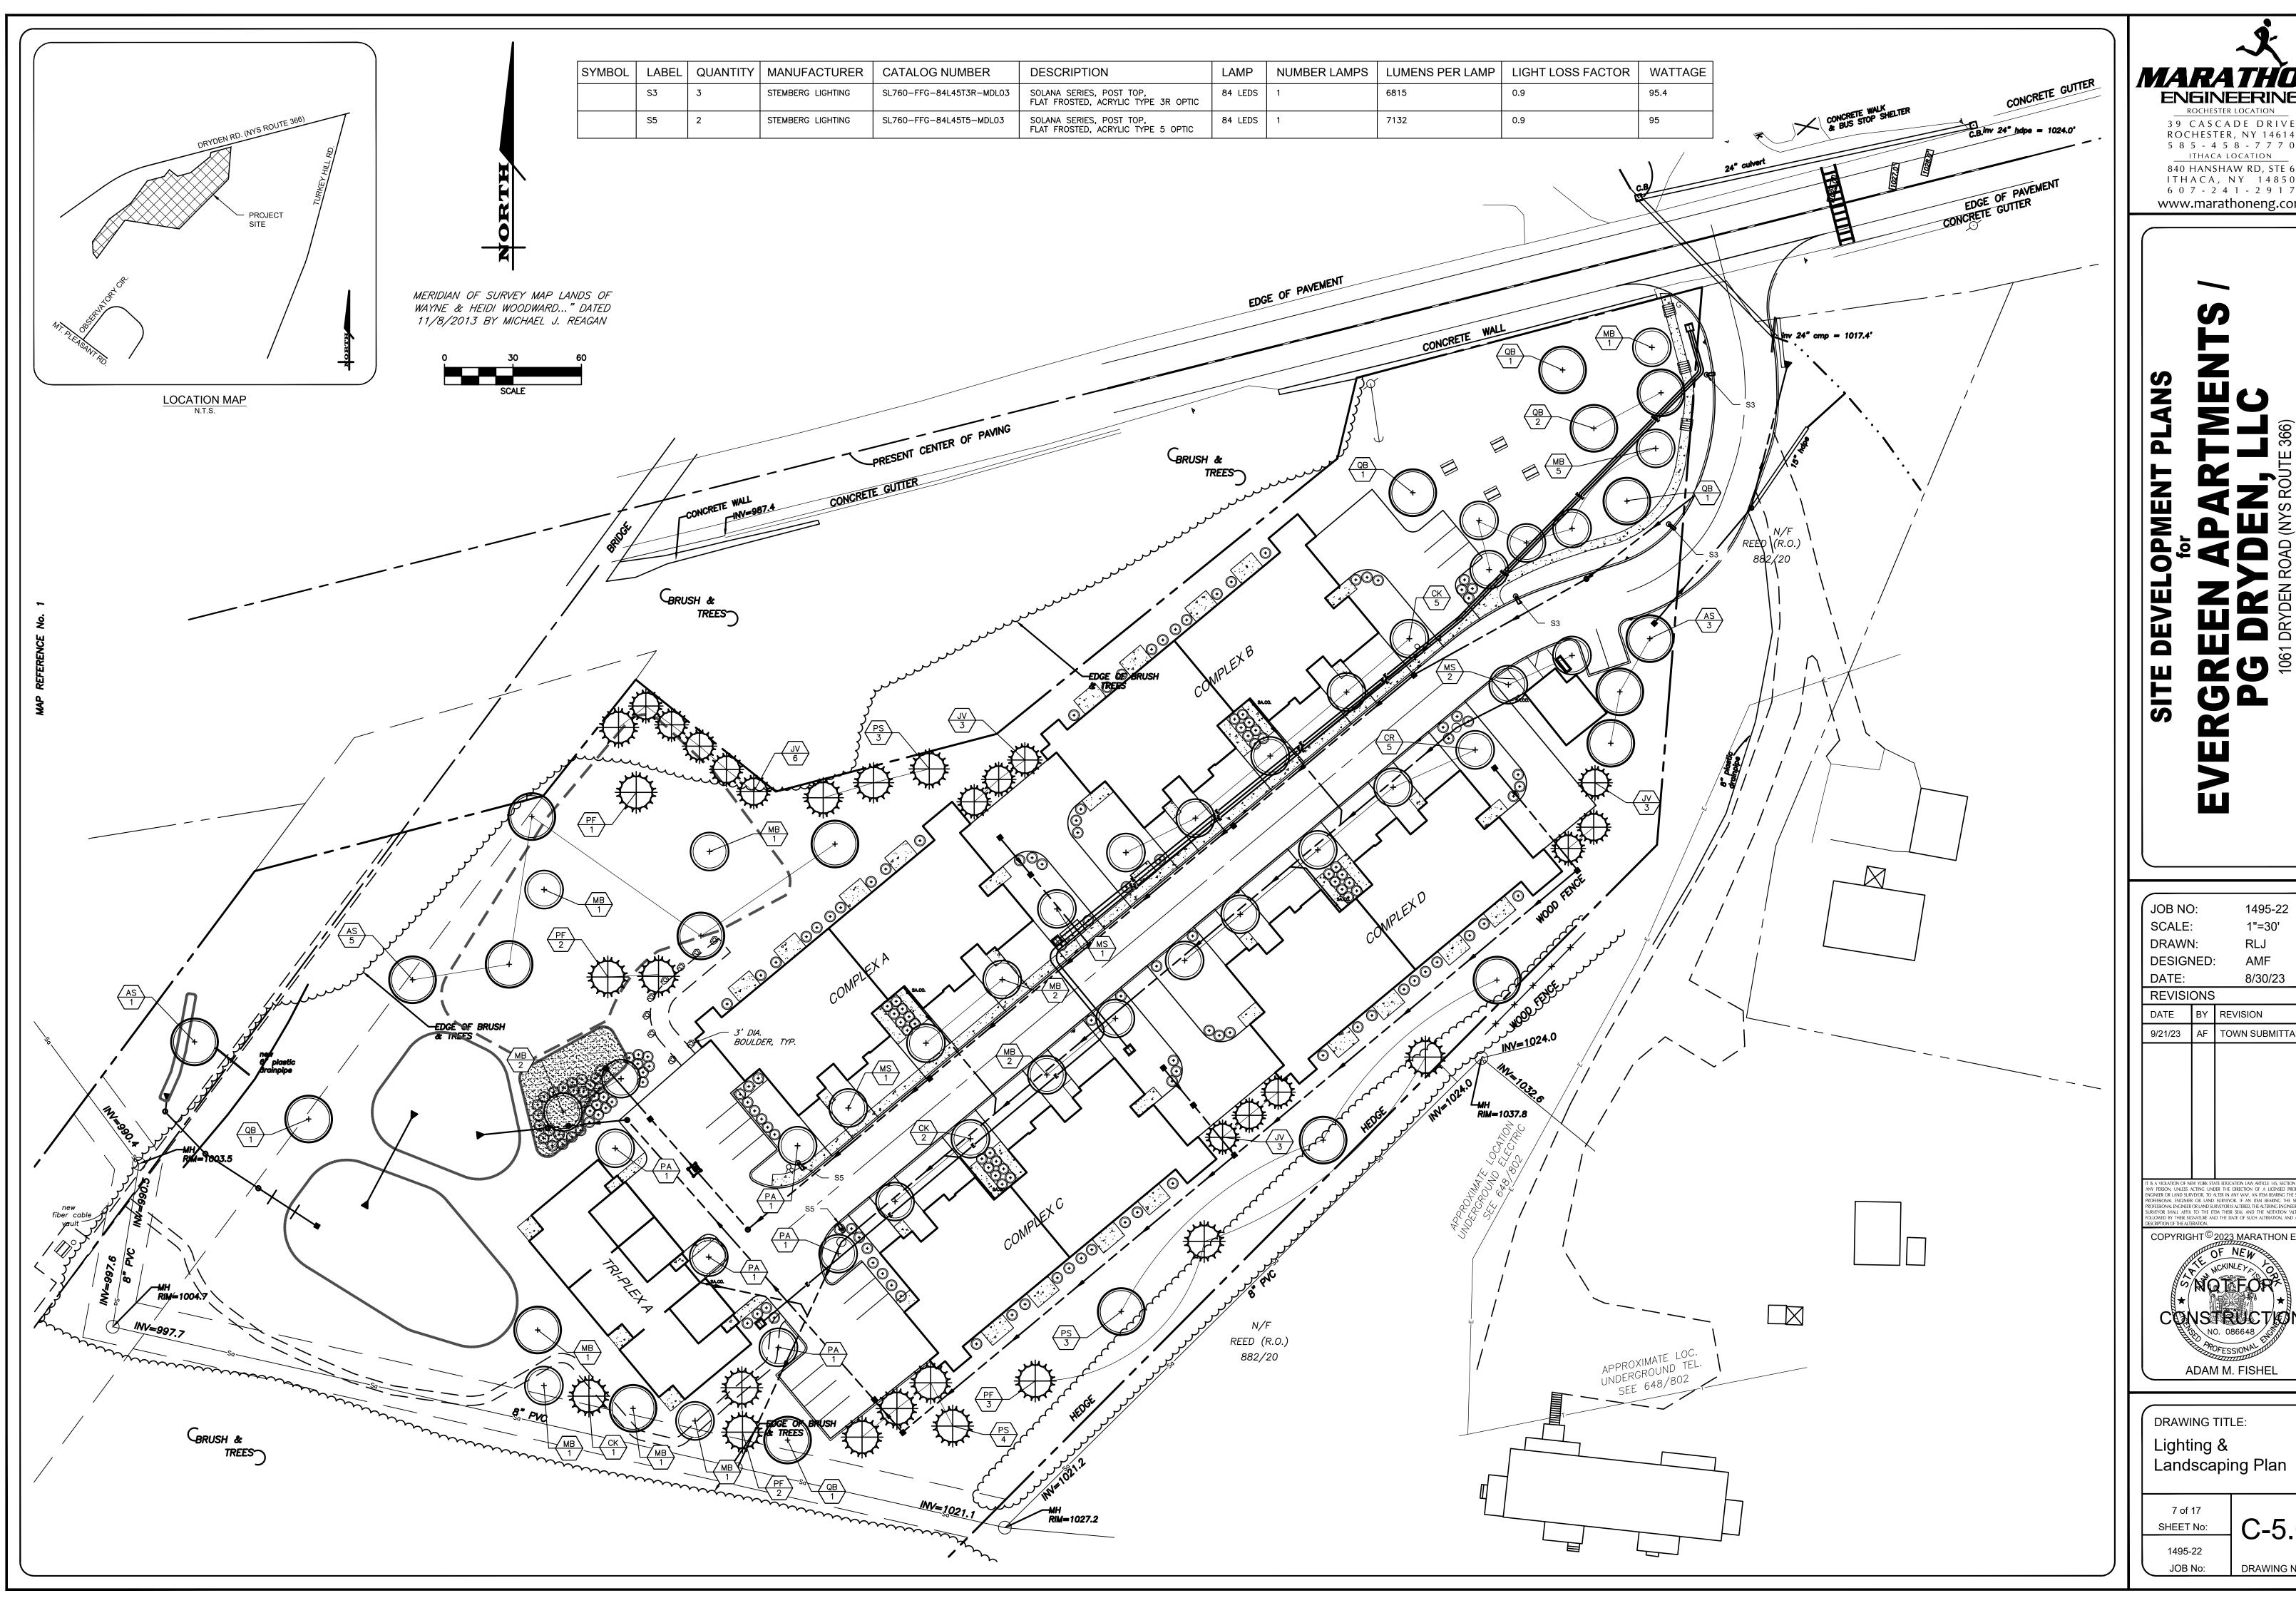

> 39 CASCADE DRIVE ROCHESTER, NY 14614 5 8 5 - 4 5 8 - 7 7 7 0 ITHACA LOCATION 840 HANSHAW RD, STE 6 ITHACA, NY 14850


6 0 7 - 2 4 1 - 2 9 1 7 www.marathoneng.com

1495-22 JOB NO: 1"=30' SCALE: DRAWN: DESIGNED: DATE: 8/30/23 REVISIONS DATE BY REVISION 9/21/23 AF TOWN SUBMITTAL COPYRIGHT[©]2<u>023 M</u>ARATHON ENG

DRAWING TITLE: Lighting & Landscaping Plan

ADAM M. FISHEL

C-5.0 SHEET No: 1495-22 DRAWING No:

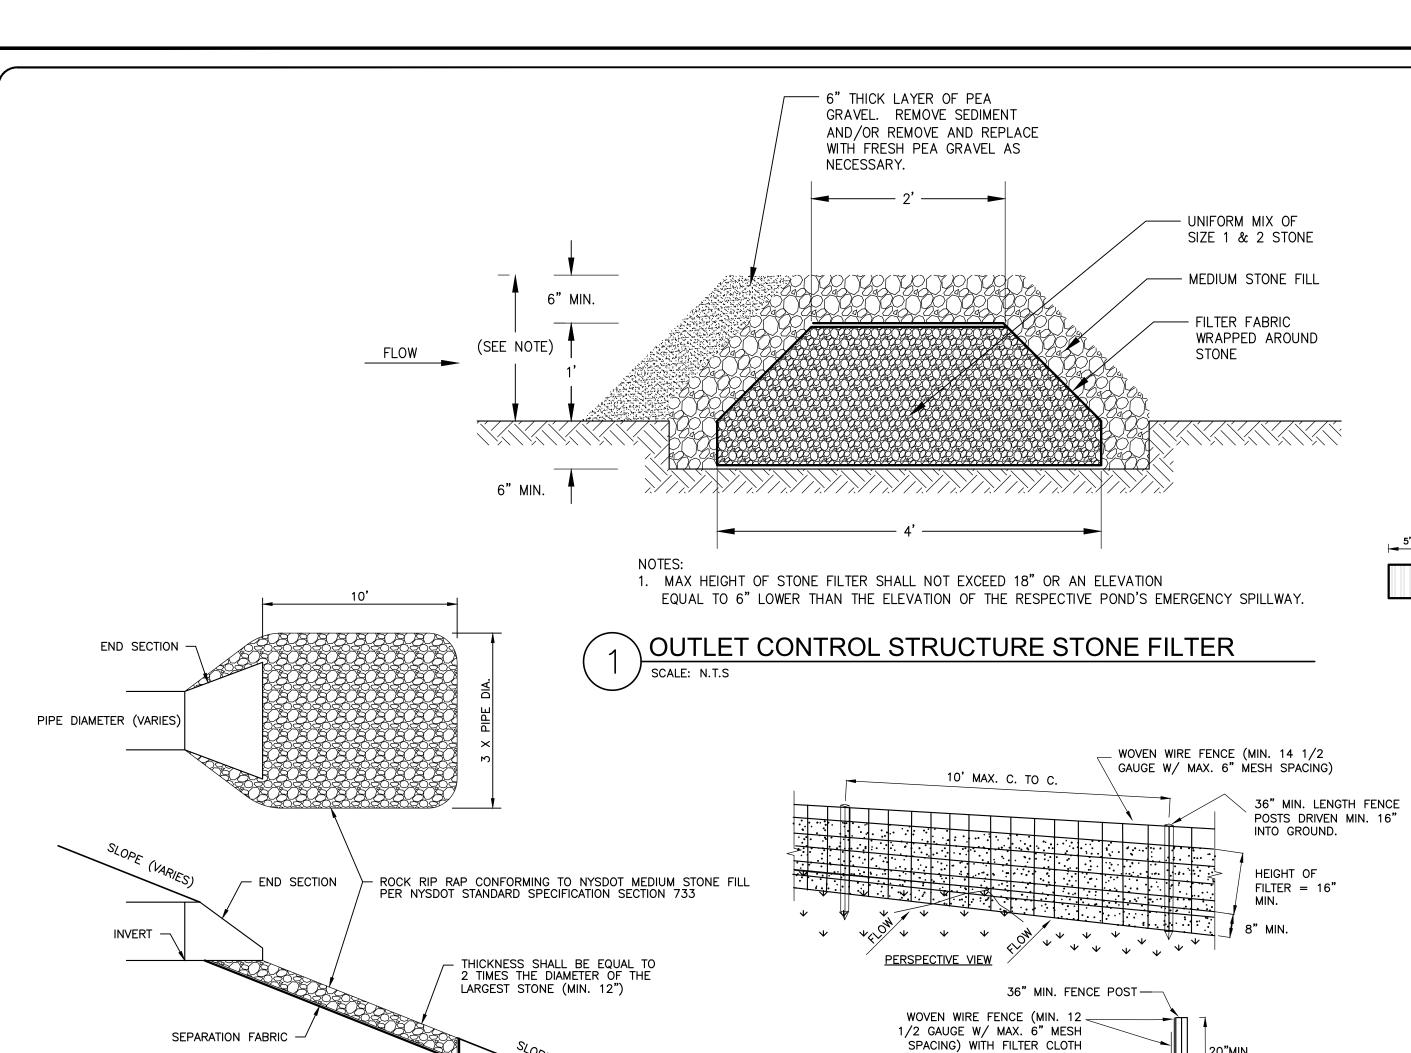

CONSTRUCTION SPECIFICATIONS

1. WOVEN WIRE FENCE TO BE FASTENED SECURELY TO FENCE POSTS WITH WIRE TIES OR STAPLES, POSTS SHALL BE STEEL "T" OF "U" TYPE OF HARDWOOD.

SECTION VIEW

- UNDISTURBED GROUND


- FILTER CLOTH TO BE FASTENED SECURELY TO WOVEN WIRE FENCE WITH TIES SPACED EVERY 24" AT TOP AND MID SECTION. FENCE SHALL BE WOVEN WIRE, 12 1/2 GAUGE, 6" MAXIMUM MESH OPENING.
- 3. WHEN TWO SECTIONS OF FILTER CLOTH ADJOIN EACH OTHER THEY SHALL BE OVERLAPPED BY SIX INCHES AND FOLDED. FILTER CLOTH SHALL BE EITHER FILTER X, MIRAFI 100X, STABLINKKA T140N, OR APPROVED EQUIVALENT.
- 4. PREFABRICATED UNITS SHALL BE GEOFAB, ENVIROFENCE, OR APPROVED EQUIVALENT.
- 5. MAINTENANCE SHALL BE PERFORMED AS NEEDED AND MATERIAL REMOVED WHEN "BULGES" DEVELOP IN THE SILT FENCE.
- 6. ENVIRO-FENCE WITH INTEGRAL MESH IS ACCEPTABLE SUBSTITUTE.


EMBED FILTER CLOTH

COMPACTED SOIL-

A MIN. OF 6" IN GROUND.



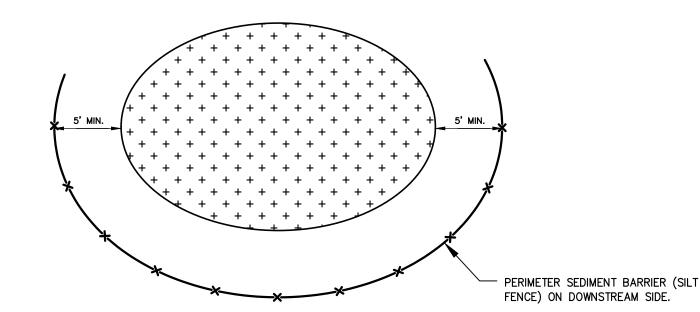

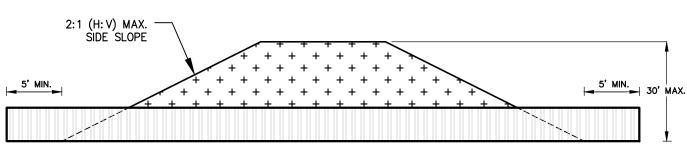



CONSTRUCTION SPECIFICATIONS

- SEDIMENT BARRIER (SILT FENCE) SHALL BE PLACED AROUND THE PERIMETER OF ALL STOCKPILES
 OF ALL ERODIBLE MATERIAL.
- OFFSET SEDIMENT BARRIER FROM STOCKPILE A MINIMUM OF 5' FROM THE TOE OF STOCKPILE FOR SEDIMENT ACCUMULATION.
- 3. IMMEDIATELY STABILIZED STOCKPILED MATERIAL WITH SEED AND MULCH.

STOCKPILE AREA

- 4. INSPECT STOCKPILE PERIMETER CONTROL AFTER EACH RAIN EVENT.
- 5. ONCE SEDIMENT HAS ACCUMULATED TO A HEIGHT OF 50% OF THE SEDIMENT BARRIER HEIGHT, THE CONTRACTOR SHALL REMOVE COLLECTED SEDIMENT AND SPOIL MATERIAL ON STOCKPILE AND RESTABILIZE WITH SEED AND MULCH.

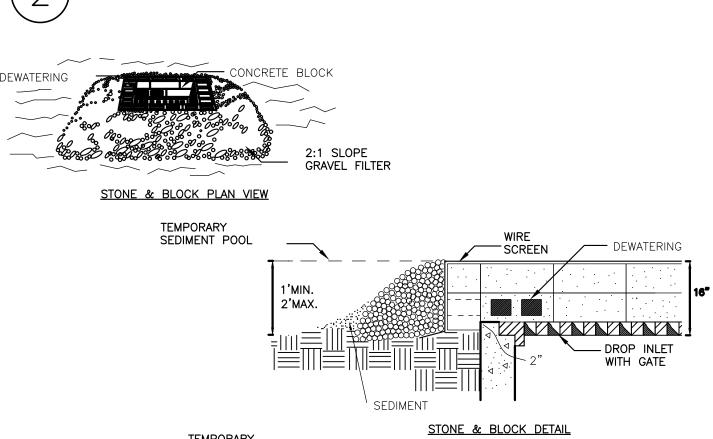

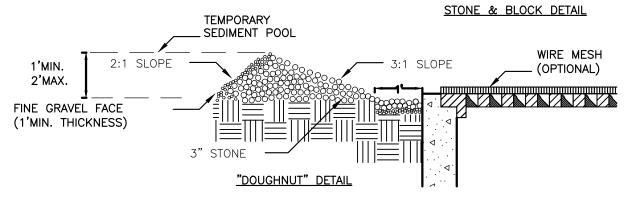

CONSTRUCTION SPECIFICATIONS


- LAY ONE BLOCK ON EACH SIDE OF THE STRUCTURE ON ITS SIDE FOR DEWATERING.
 FOUNDATION SHALL BE 2 INCHES MINIMUM BELOW REST OF INLET AND BLOCKS SHALL BE
 PLACED AGAINST INLET FOR SUPPORT.
 HARDWARE CLOTH OR 1/2" WIRE MESH SHALL BE PLACED OVER BLOCK OPENINGS TO SUPPOR
 STONE.
 USE CLEAN STONE OR GRAVEL 1/2-3/4 INCH IN DIAMETER PLACED 2 INCHES BELOW TOP OF
- THE BLOCK ON A 2:1 SLOPE OR FLATTER.

 4. FOR STONE STRUCTURES ONLY, A 1 FOOT THICK LAYER OF THE FILTER STONE WILL

 BE
 PLACED AGAINST THE 3 INCH STONE AS SHOWN ON THE DRAWINGS.
- 5. MAXIMUM DRAINAGE AREA 1 ACRE

5 STONE & BLOCK DROP INLET PROTECTION

SCALE: N.T.S

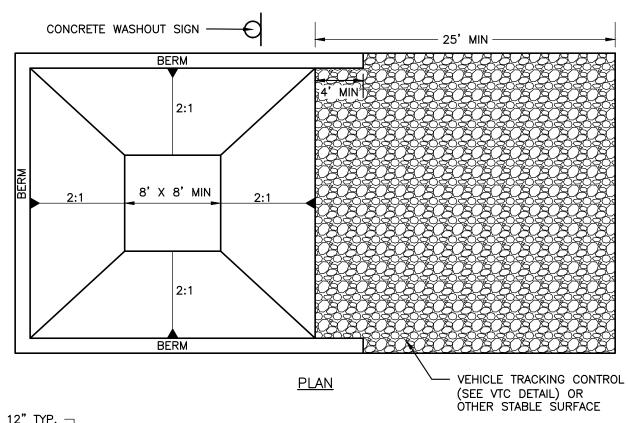

VEHICLE TRACKING CONTROL (SEE VTC DETAIL) OR OTHER STABLE SURFACE

12" TYP. COMPACTED BERM AROUND THE PERIMETER


2% SLOPE

VEHICLE TRACKING CONTROL (SEE VTC DETAIL)

VEHICLE TRACKING CONTROL (SEE VTC DETAIL)

- CONTRACTOR TO VERIFY SIZE REQUIREMENTS BASED ON ANTICIPATED VOLUMES OF CONCRETE WASHOUT.
- 2. CONCRETE WASHOUT SHOULD BE PLACED TO NOT ACCEPT SURFACE RUNOFF EXCEPT THE AREA WHERE TRUCKS SIT FOR WASHOUT.
- 3. IF WATER DOES NOT EVAPORATE AND IS GREATER THAN 75% FULL CONTRACTOR SHALL REMOVE LIQUIDS AS REQUIRED BY THE LOCAL AUTHORITY (SAN SEALER OF VAC TRUCK)
- 4. PROVIDE MINIMUM AGGREGATE OF 10 MIL PLASTIC AS LINER. SECURE LINER TO PREVENT INFILTRATION & REPLACE AS NECESSARY FOR TEARS.



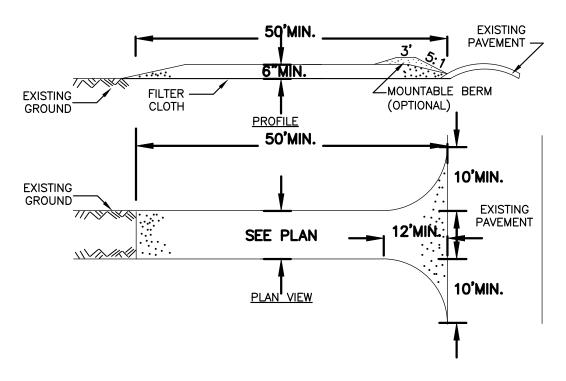

CONSTRUCTION SPECIFICATIONS

- 1. STONE SIZE USE 2" STONE, OR RECLAIMED OR RECYCLED CONCRETE EQUIVALENT.
- 2. LENGTH NOT LESS THAN 50 FEET (EXCEPT ON A SINGLE RESIDENCE LOT WHERE A 30 FOOT MIN. LENGTH WOULD APPLY).
- 3. THICKNESS NOT LESS THAN SIX (6) INCHES.
- 4. WIDTH TWELVE (12) FOOT MINIMUM, BUT NOT LESS THAN THE FULL WIDTH AT POINTS WHERE INGRESS OR EGRESS OCCURS, TWENTY-FOUR (24) FOOT IF SINGLE ENTRANCE TO SITE.
- 5. FILTER CLOTH WILL BE PLACED OVER THE ENTIRE AREA PRIOR TO PLACING OF STONE.
- 6. SURFACE WATER ALL SURFACE WATER FLOWING OR DIVERTED TOWARD CONSTRUCTION ENTRANCES SHALL BE PIPED ACROSS THE ENTRANCE. IF PIPING IS IMPRACTICAL, A MOUNTABLE BERM WITHI 5:1 SLOPES WILL BE PERMITTED.
- 7. MAINTENANCE THE ENTRANCE SHALL BE MAINTAINED IN A CONDITION WHICH WILL PREVENT TRACKING OR FLOWING OF SEDIMENT ONTO PUBLIC RIGHTS—OF—WAY, ALL SEDIMENT SPILLED, DROPPED, TACKED, OR WASHED ONTO PUBLIC RIGHTS—OF—WAY MUST BE REMOVED IMMEDIATELY.
- 8. WHEN WASHING IS REQUIRED, IT SHALL BE DONE ON AN AREA STABILIZED WITH STONE AND WHICH DRAINS INTO AN APPROVED SEDIMENT TRAPPING DEVICE.
- 9. PERIODIC INSPECTION AND NEEDED MAINTENANCE SHALL BE PROVIDED AFTER EACH RAIN.





www.marathoneng.com

RTMENTS/ I, LLC ROUTE 366)

1

 $\mathbf{\Sigma}$

5

DKYDEN ROAD (NYS F TOMPKINS COUNT

WN OF DRYDEN

JOB NO: 1495-22 SCALE: 1"=30' DRAWN: RLJ DESIGNED: AMF 8/30/23 REVISIONS DATE BY REVISION 9/21/23 AF TOWN SUBMITTAL NY PERSON, UNLESS ACTING UNDER THE DIRECTION OF A LICENSED PROFESS NGINEER OR LAND SURVEYOR, TO ALTER IN ANY WAY, AN ITEM BEARING THE SEA SIONAL ENGINEER OR LAND SURVEYOR, IF AN ITEM BEARING THE SEA WED BY THEIR SIGNATURE AND THE DATE OF SUCH ALTERATION, AND A COPYRIGHT[©] 2<u>023 M</u>ARATHON ENG

DRAWING TITLE:

Detail Sheet (1 of 6)

8 of 17
SHEET No:


1495-22

DRAWING No:

CONSTRUCT

NO. 086648

ADAM M. FISHEL

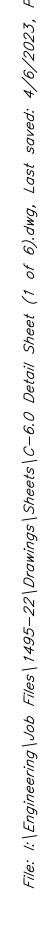

8 STONE CHECK DAM
SCALE: N.T.S

1. STONE WILL BE PLACED ON A FILTER FABRIC FOUNDATION TO THE LINES, GRADES AND

DOWNSTREAM DAM IS AT THE SAME ELEVATION OF THE UPSTREAM DAM.

NOT SUBJECT TO DAMAGE OF BLOCKAGE FROM DISPLACED STONES.

MAXIMUM DRAINAGE AREA - 2 ACRES

2. SET SPACING OF CHECK DAMS TO ASSUME THAT THE ELEVATIONS OF THE CREST OF THE

3. EXTEND THE STONE A MINIMUM OF 1.5 FEET BEYOND THE DITCH BANKS TO PREVENT CUTTING

4. PROTECT THE CHANNEL DOWNSTREAM OF THE LOWEST CHECK DAM FROM SCOUR AND EROSION

5. ENSURE THAT CHANNEL APPURTENANCES SUCH AS CULVERT ENTRANCES BELOW CHECK DAMS ARE

1.) RCP END SECTIONS SHALL CONFORM TO NYSDOT SPEC. # 706-06

PIPE OUTLET PROTECTION

SPACING VARIES DEPENDING ON

CHANNEL SLOPE

NOT TO SCALE

SECTION A-A

FILTER FABRIC-

NOT TO SCALE

CONSTRUCTION SPECIFICATIONS

LOCATION SHOWN ON IN THE PLAN

WITH STONE OR LINER AS APPROPRIATE.

AROUND THE DAM,

1.5' MIN. -

SECTION B-B


NOT TO SCALE

SCALE: N.T.S

NYS DOT LIGHT STONE FILL— 2" TO 9" IN SIZE

JTOFF TRENCH $-\!\!\!\!-$

2.) HDPE PIPE END SECTIONS SHALL CONFORM TO NYSDOT SPEC. # 707-10

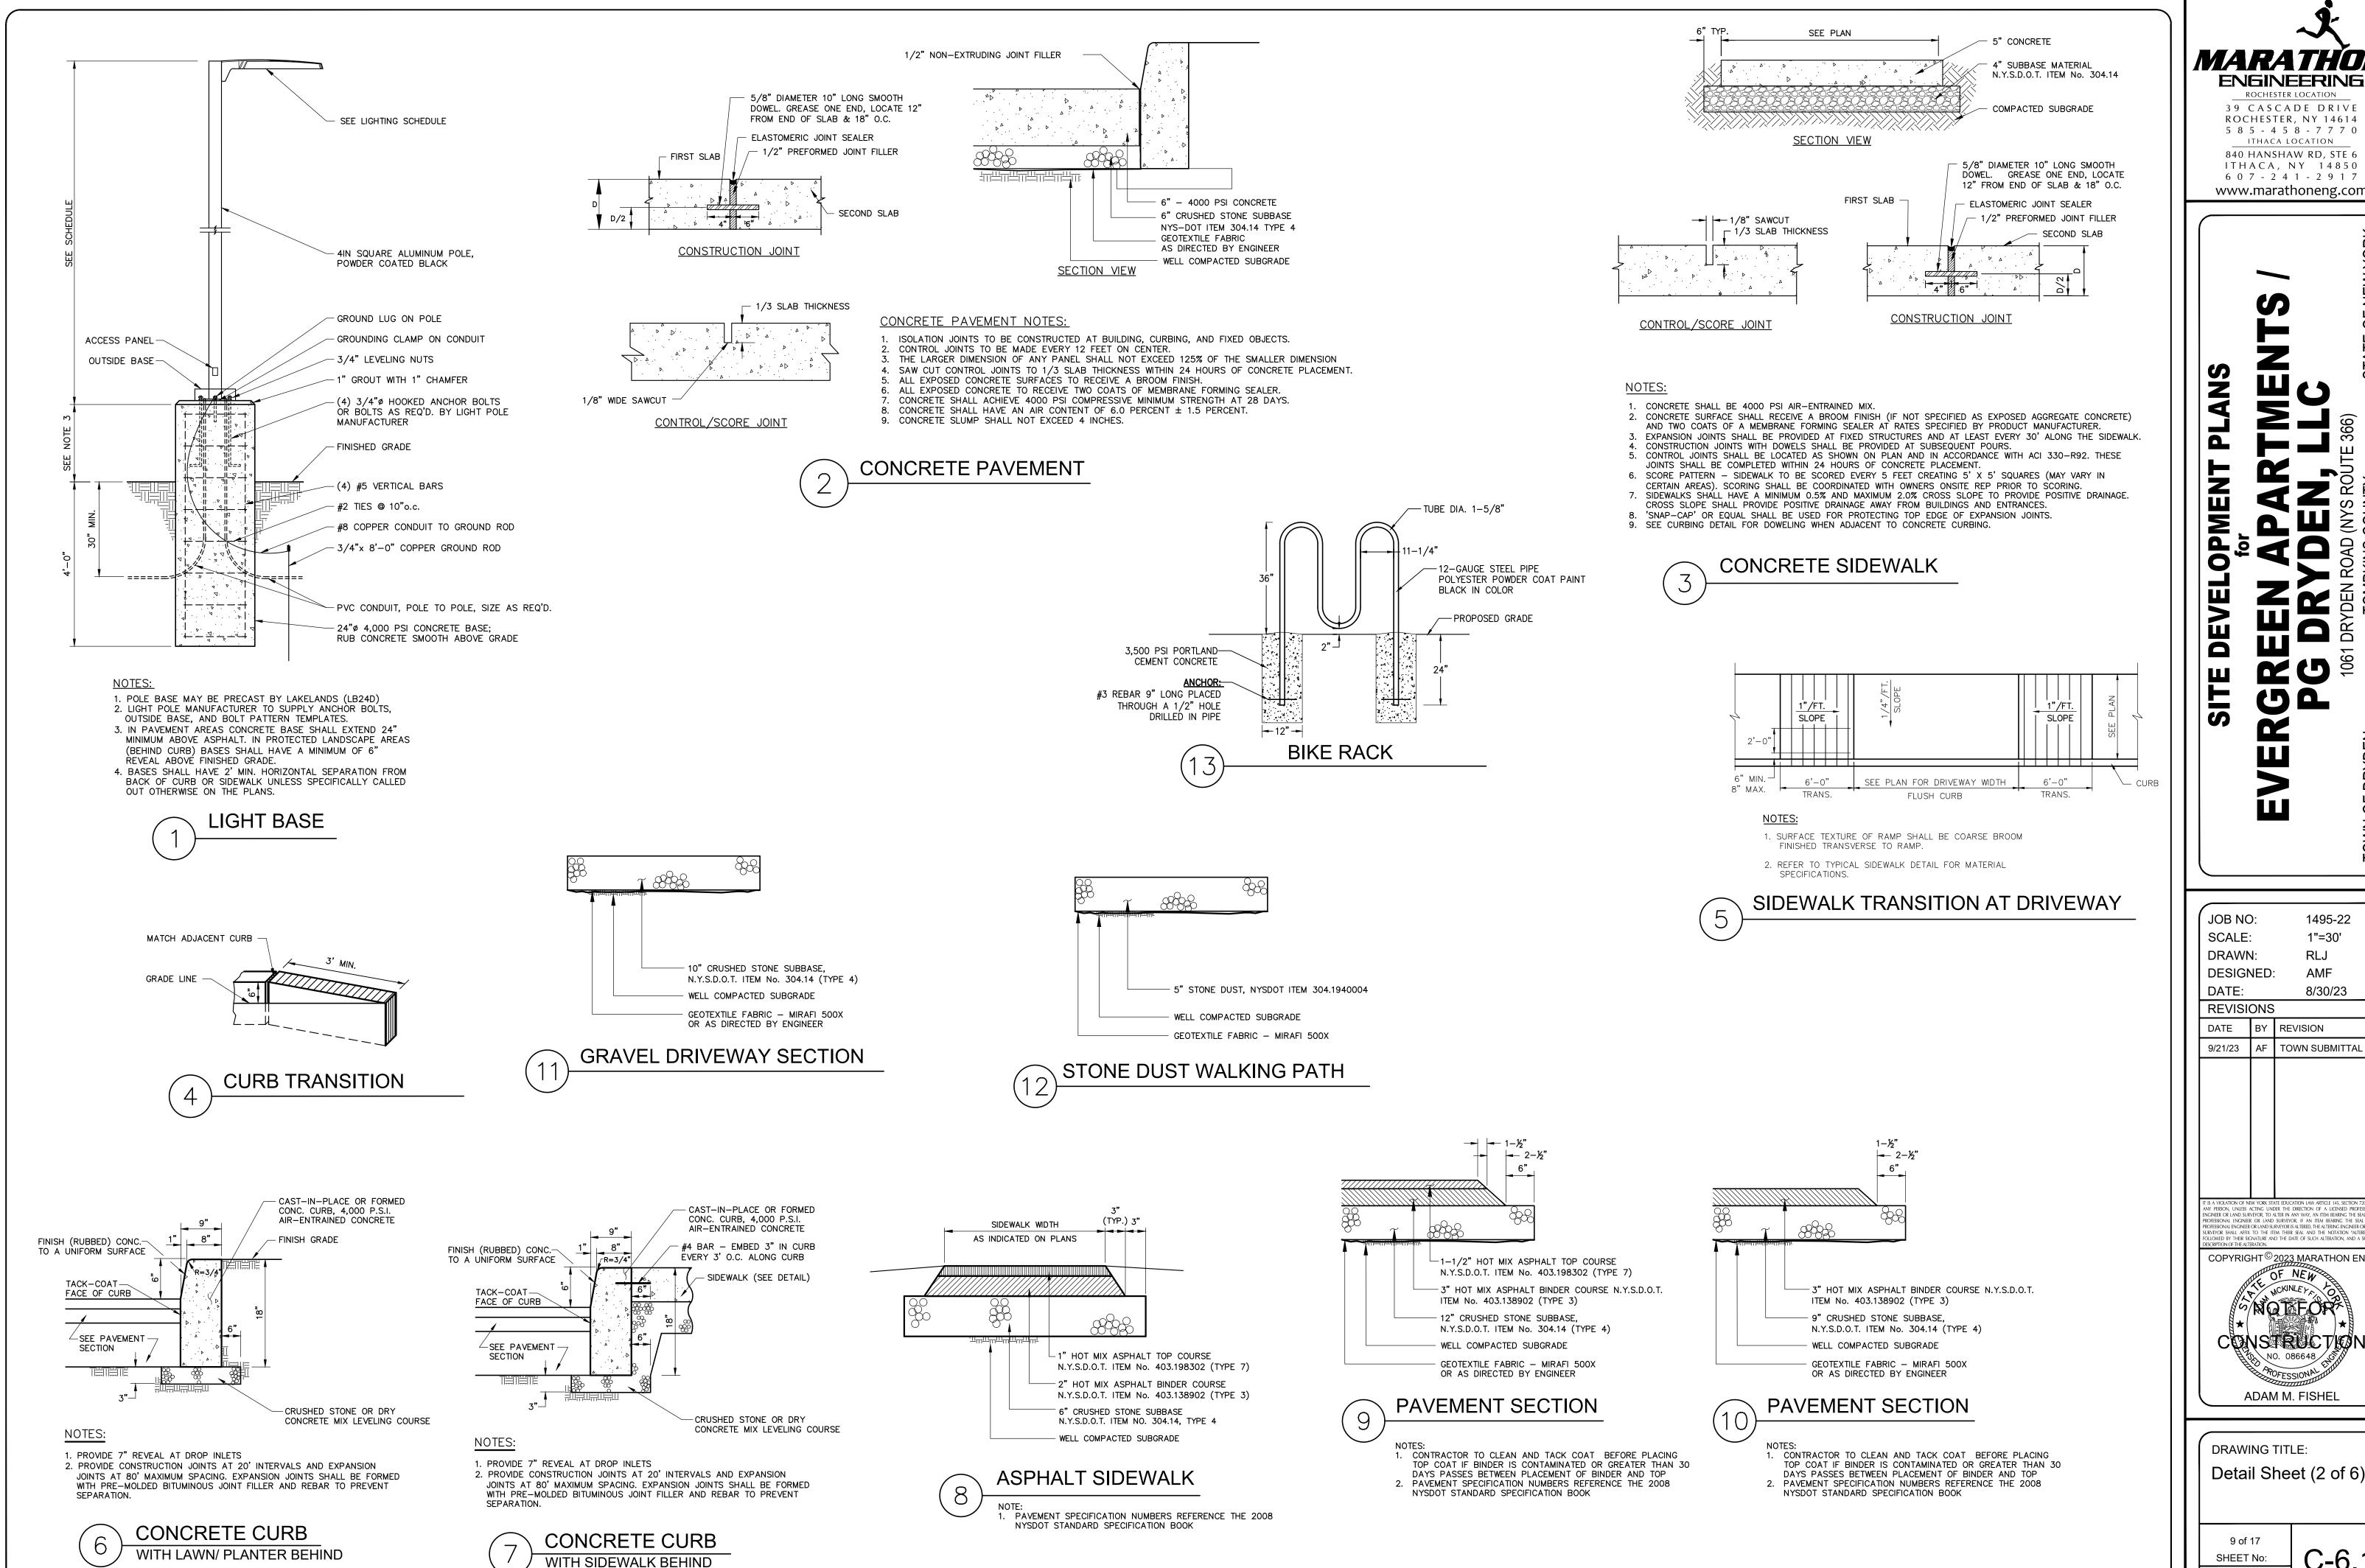

ROCHESTER LOCATION 39 CASCADE DRIVE ROCHESTER, NY 14614 5 8 5 - 4 5 8 - 7 7 7 0

ITHACA LOCATION 840 HANSHAW RD, STE 6 ITHACA, NY 14850

6 0 7 - 2 4 1 - 2 9 1 7 www.marathoneng.com

1495-22 1"=30' RLJ AMF

DESIGNED: 8/30/23 REVISIONS

DATE BY REVISION 9/21/23 AF TOWN SUBMITTAL

PERSON, UNLESS ACTING UNDER THE DIRECTION OF A LICENSED PROFES IONAL ENGINEER OR LAND SURVEYOR, IF AN ITEM BEARING THE SEAL SURVEYOR SHALL AFFIX TO THE ITEM THEIR SEAL AND THE NOTATION "ALTERIFOLLOWED BY THEIR SIGNATURE AND THE DATE OF SUCH ALTERATION, AND A SUPERCONTROLLOR THE AUTOMOTOR THE DATE OF THE AUTOMOTOR THE AUT

COPYRIGHT© 2023 MARATHON ENG CONSTRUCTION


ADAM M. FISHEL

DRAWING TITLE:

SHEET No: 1495-22

DRAWING No:

JOB No:

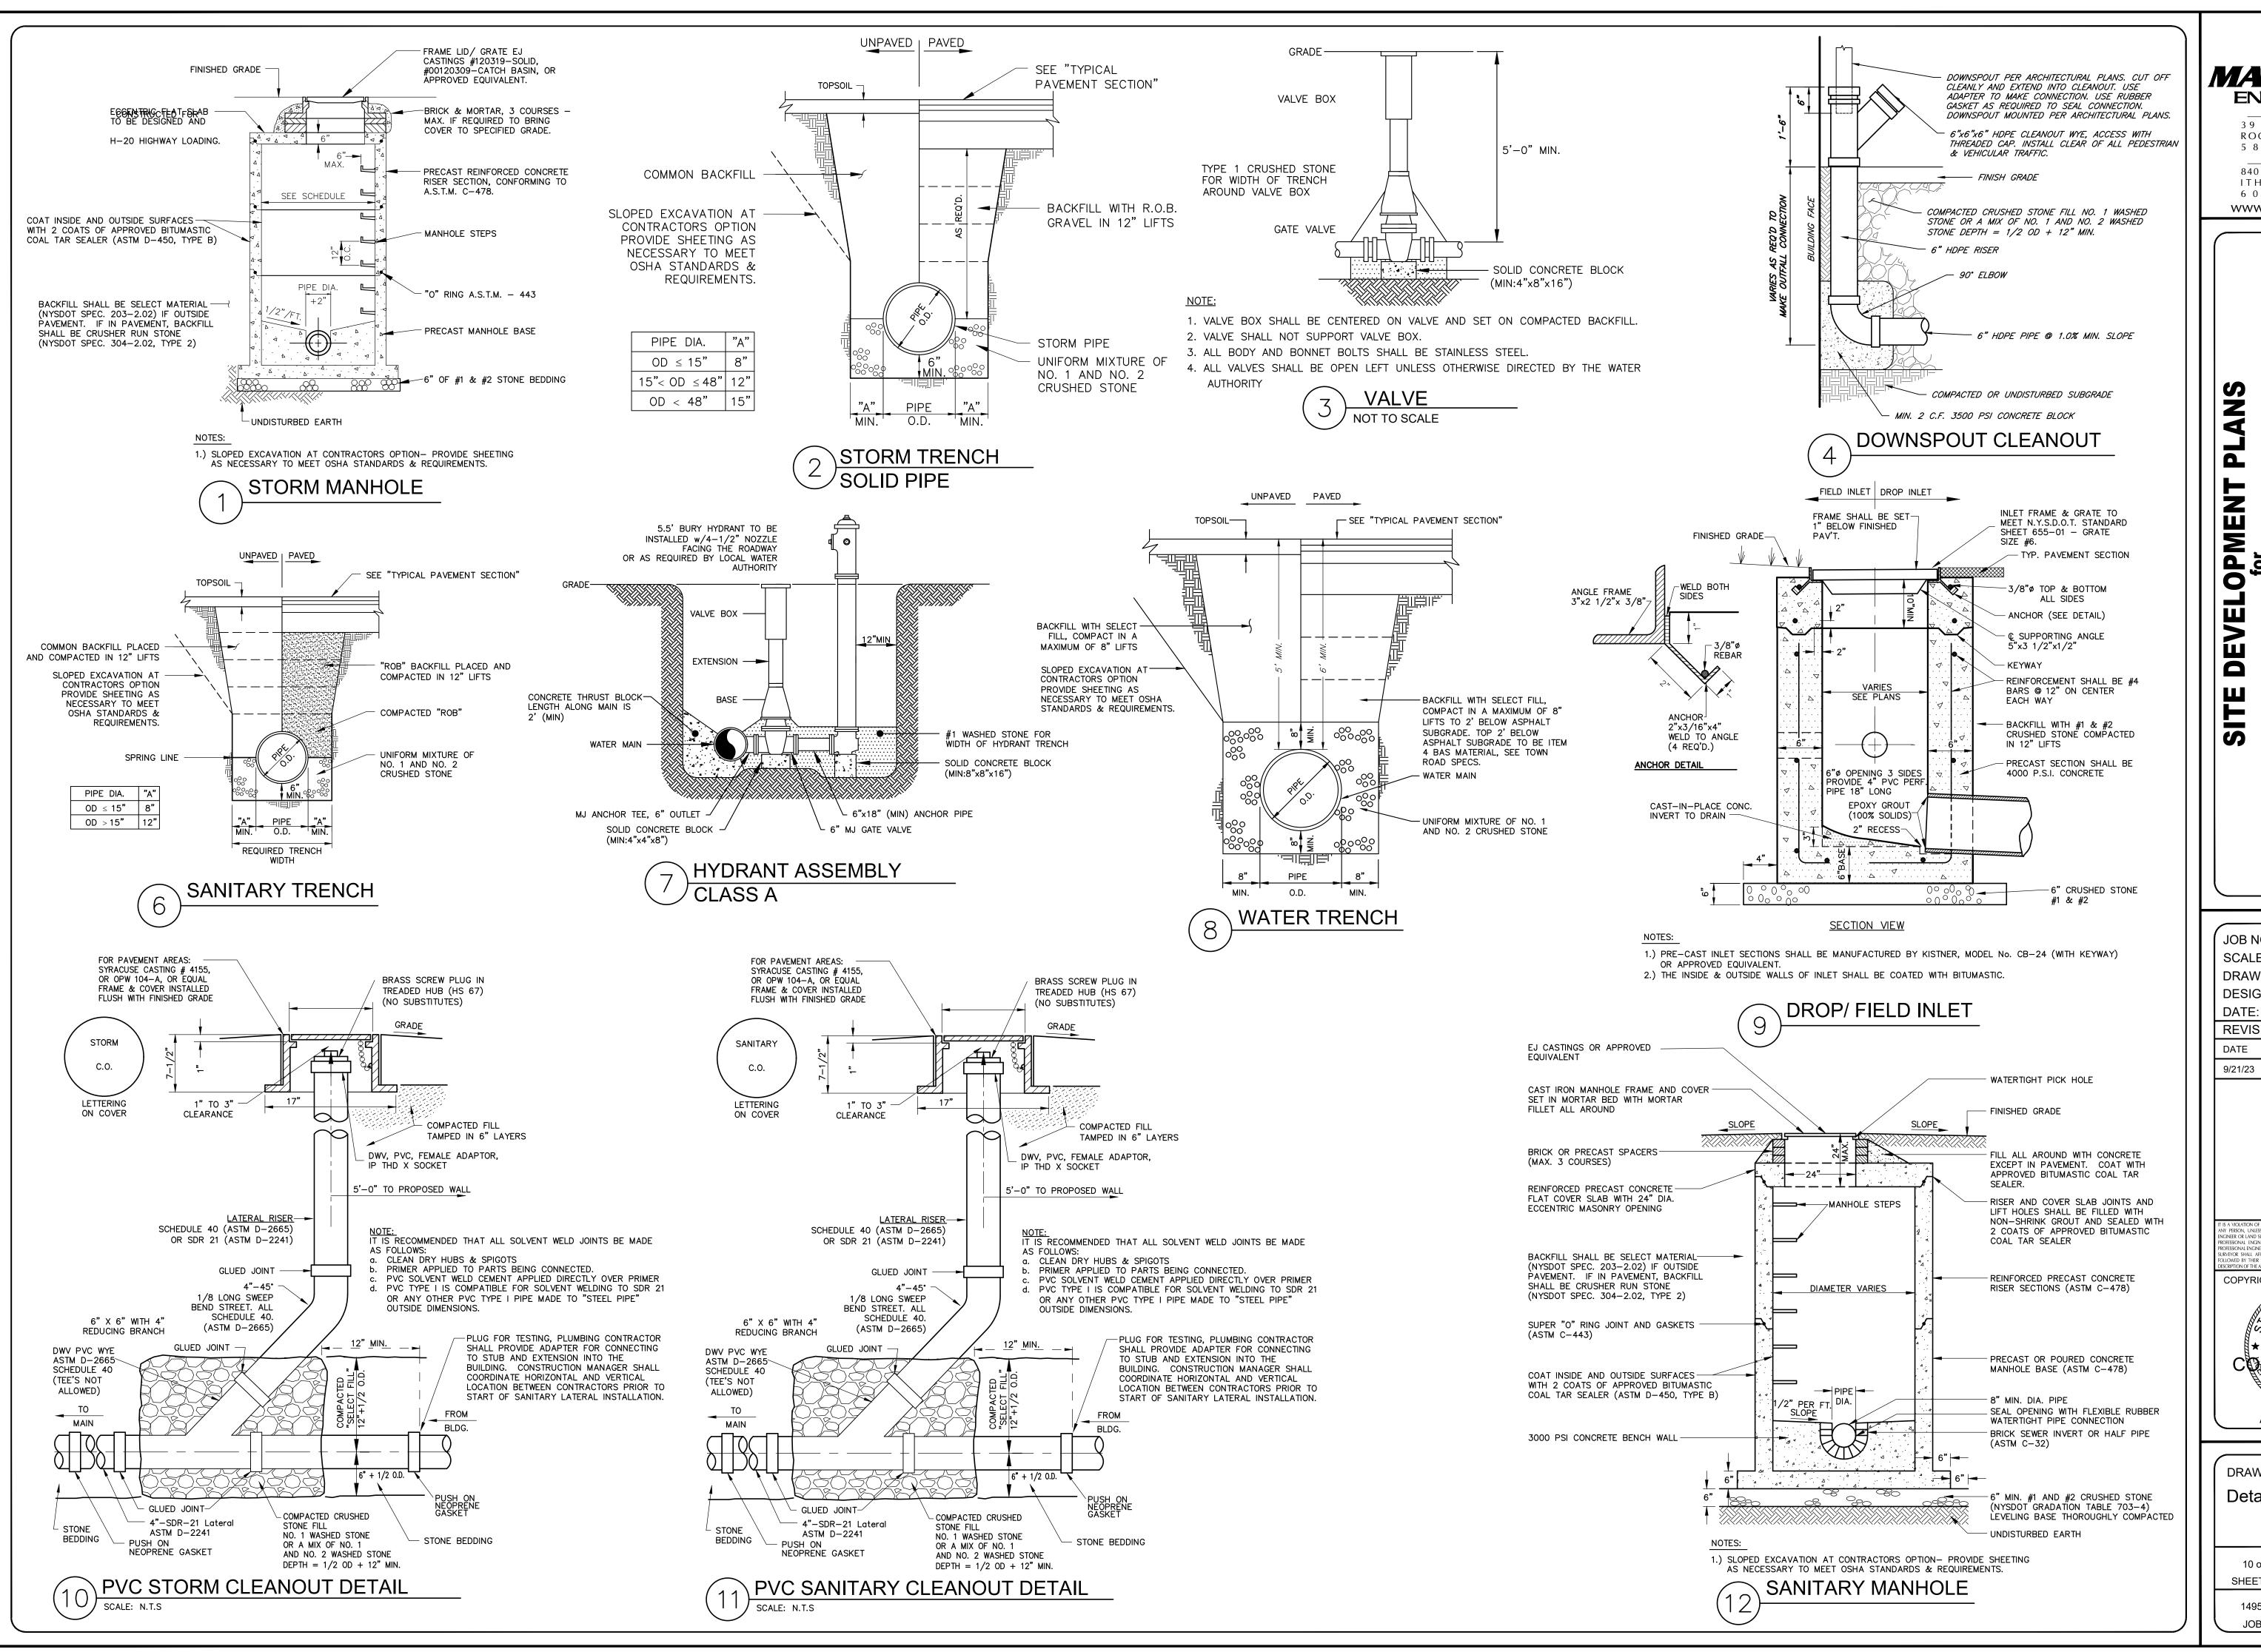



39 CASCADE DRIVE ROCHESTER, NY 14614 5 8 5 - 4 5 8 - 7 7 7 0 ITHACA LOCATION

840 HANSHAW RD, STE 6 ITHACA, NY 14850 6 0 7 - 2 4 1 - 2 9 1 7 www.marathoneng.com

NEW

1495-22 1"=30'

JOB NO: SCALE: DRAWN: DESIGNED: **AMF** 8/30/23

REVISIONS DATE BY REVISION 9/21/23 AF TOWN SUBMITTAL

IY PERSON, UNLESS ACTING UNDER THE DIRECTION OF A LICENSED PROFESSI GINEER OR LAND SURVEYOR, TO ALTER IN ANY WAY, AN ITEM BEARING THE SEAL IONAL ENGINEER OR LAND SURVEYOR, IF AN ITEM BEARING THE SEAL OWED BY THEIR SIGNATURE AND THE DATE OF SUCH ALTERATION, AND A S COPYRIGHT©2<u>023 M</u>ARATHON ENG

MCKINLEY CONSTRUCTION NO. 086648


ADAM M. FISHEL

DRAWING TITLE: Detail Sheet (3 of 6) SHEET No:

DRAWING No:

1495-22

JOB No:

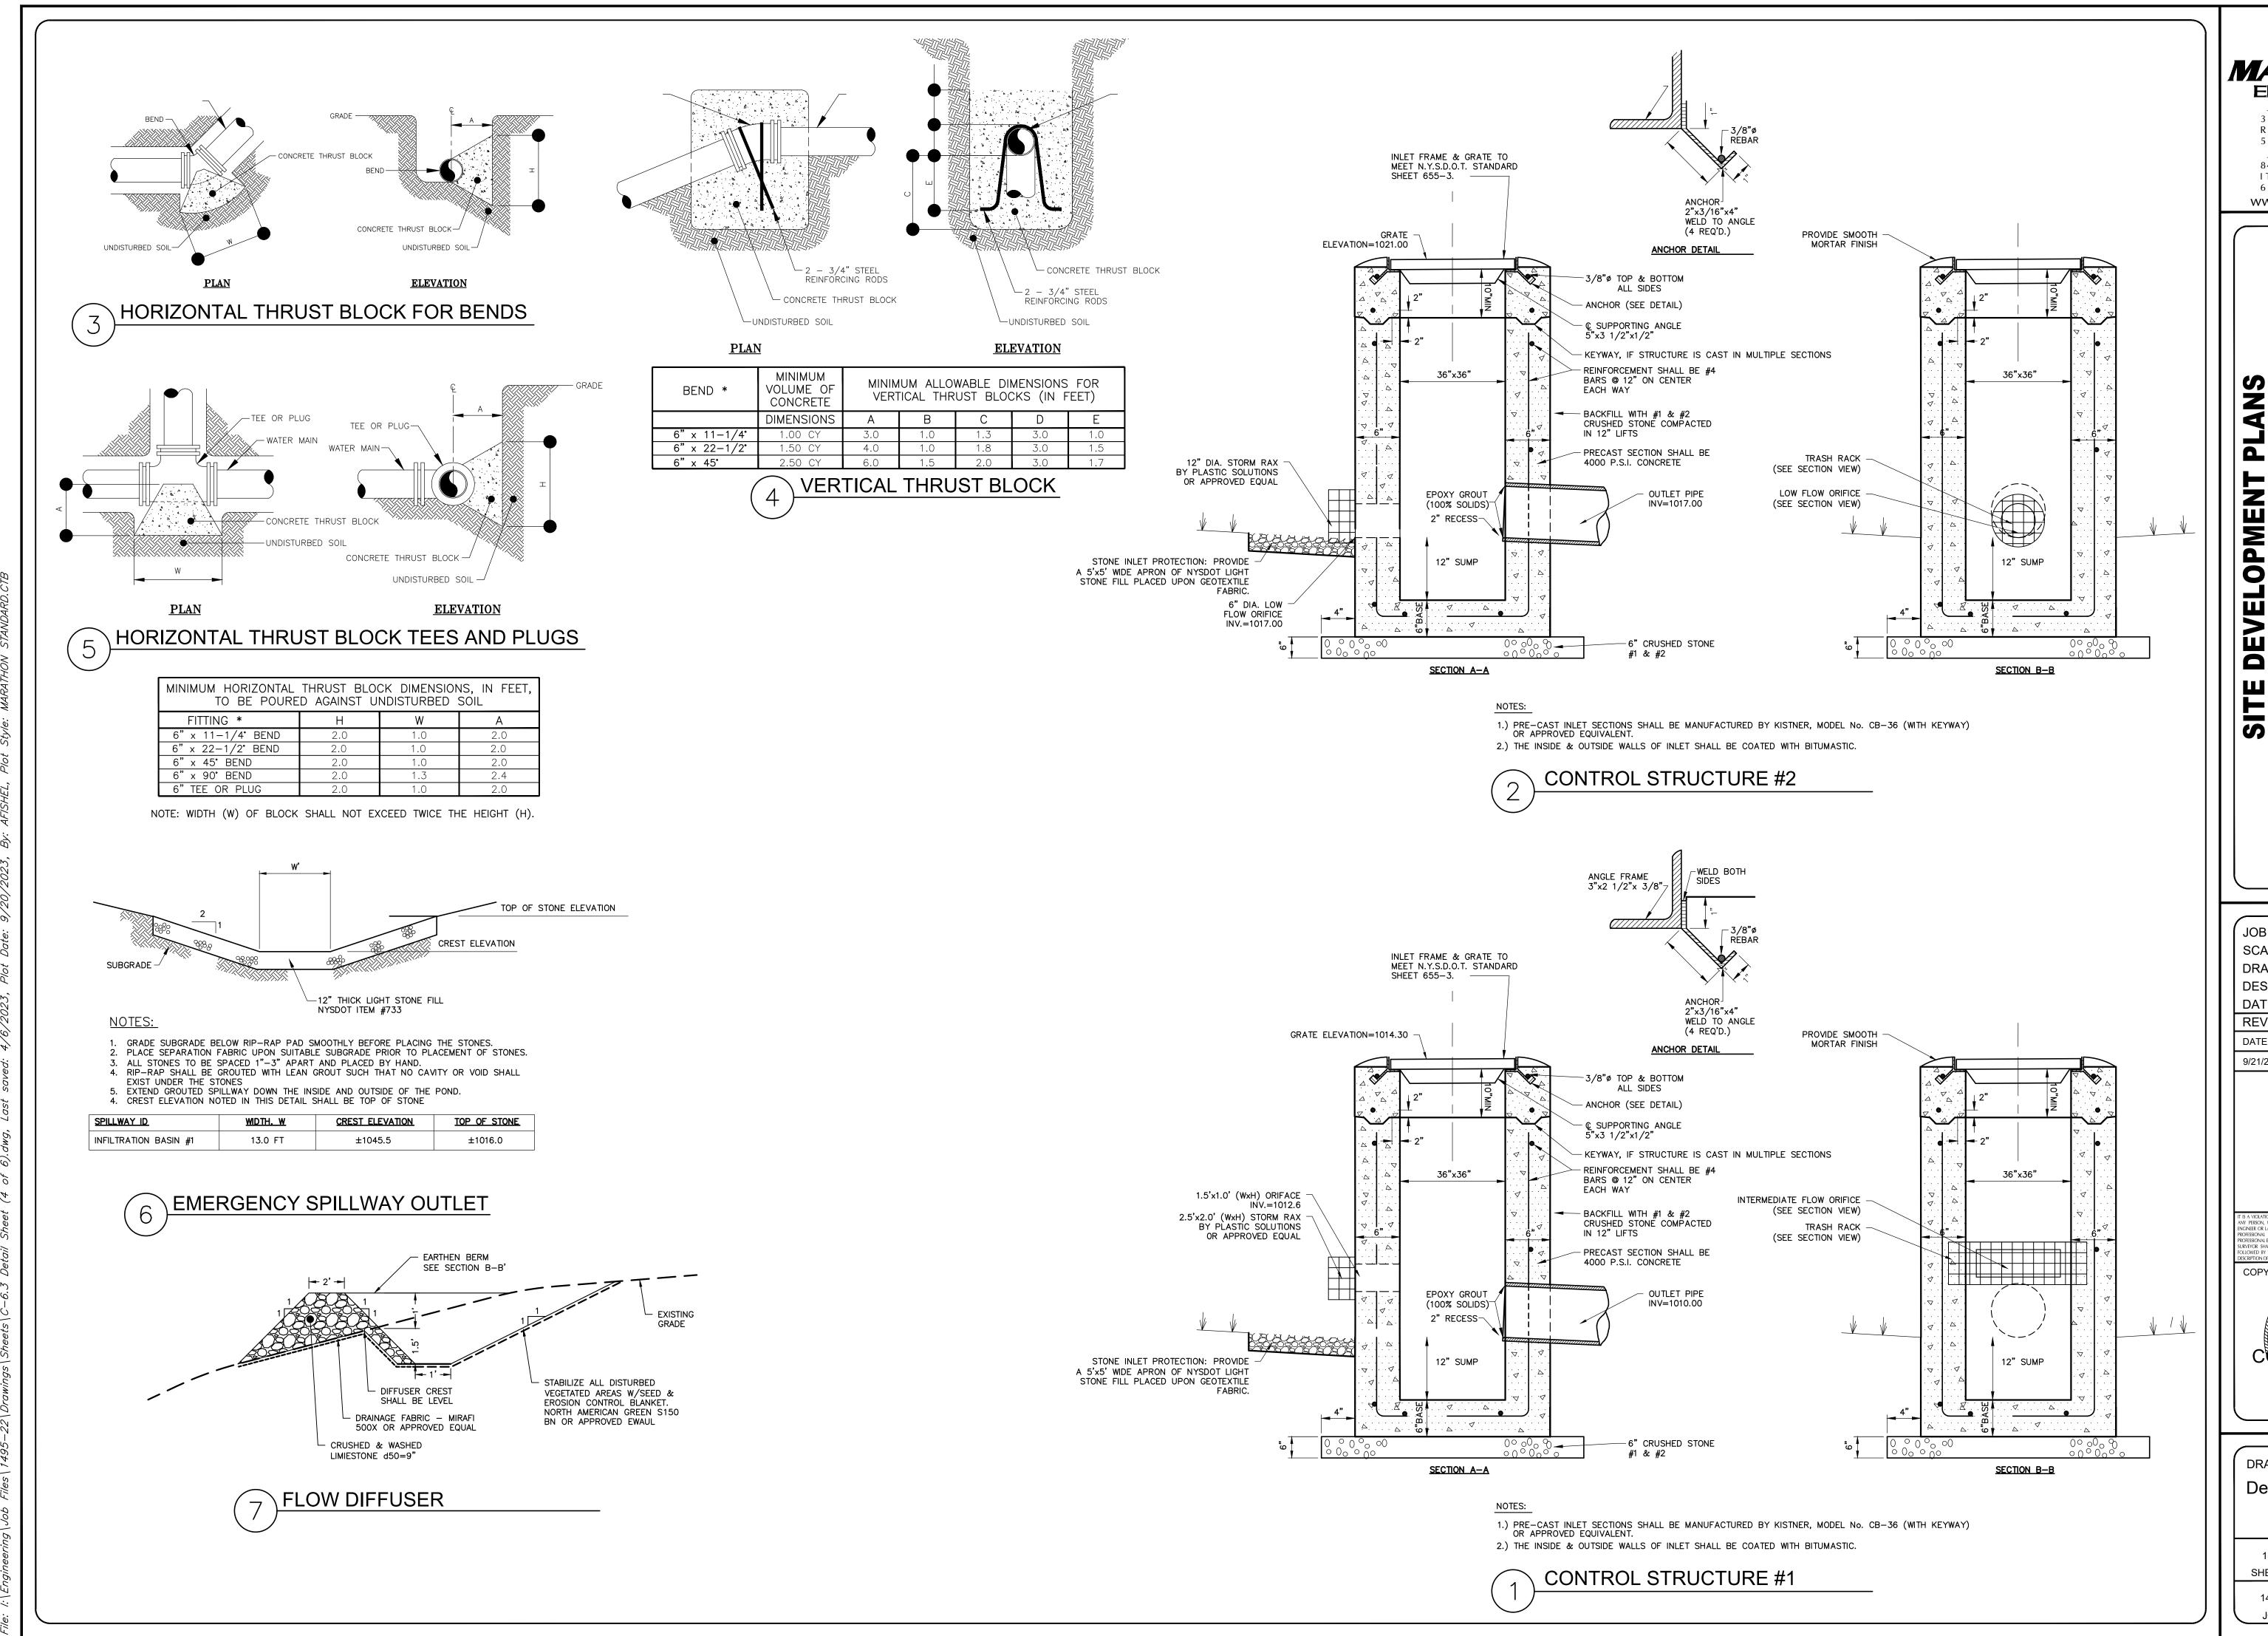

39 CASCADE DRIVE ROCHESTER, NY 14614 5 8 5 - 4 5 8 - 7 7 7 0 ITHACA LOCATION 840 HANSHAW RD, STE 6

ROCHESTER LOCATION

ITHACA, NY 14850 6 0 7 - 2 4 1 - 2 9 1 7

www.marathoneng.com

JOB NO: 1495-22 SCALE: 1"=30' DRAWN: AMF 8/30/23

DESIGNED: DATE: REVISIONS DATE BY REVISION

9/21/23 AF TOWN SUBMITTAL


NY PERSON, UNLESS ACTING UNDER THE DIRECTION OF A LICENSED PROFESSI NGINEER OR LAND SURVEYOR, TO ALTER IN ANY WAY, AN ITEM BEARING THE SEAL ROFESSIONAL ENGINEER OR LAND SURVEYOR. IF AN ITEM BEARING THE SEAL SURVEYOR SHALL AFFIX TO THE ITEM THEIR SEAL AND THE NOTATION "ALTEREI FOLLOWED BY THEIR SIGNATURE AND THE DATE OF SUCH ALTERATION, AND A SPOSED PROPORTION OF THE ARTER AND THE DATE OF SUCH ALTERATION, AND A SPOSED PROPORTION OF THE ARTER AND THE COPYRIGHT©2<u>023 M</u>ARATHON ENG

CONSTRUCTION

ADAM M. FISHEL

DRAWING TITLE: Detail Sheet (4 of 6)

11 of 17 SHEET No: 1495-22 JOB No: DRAWING No:

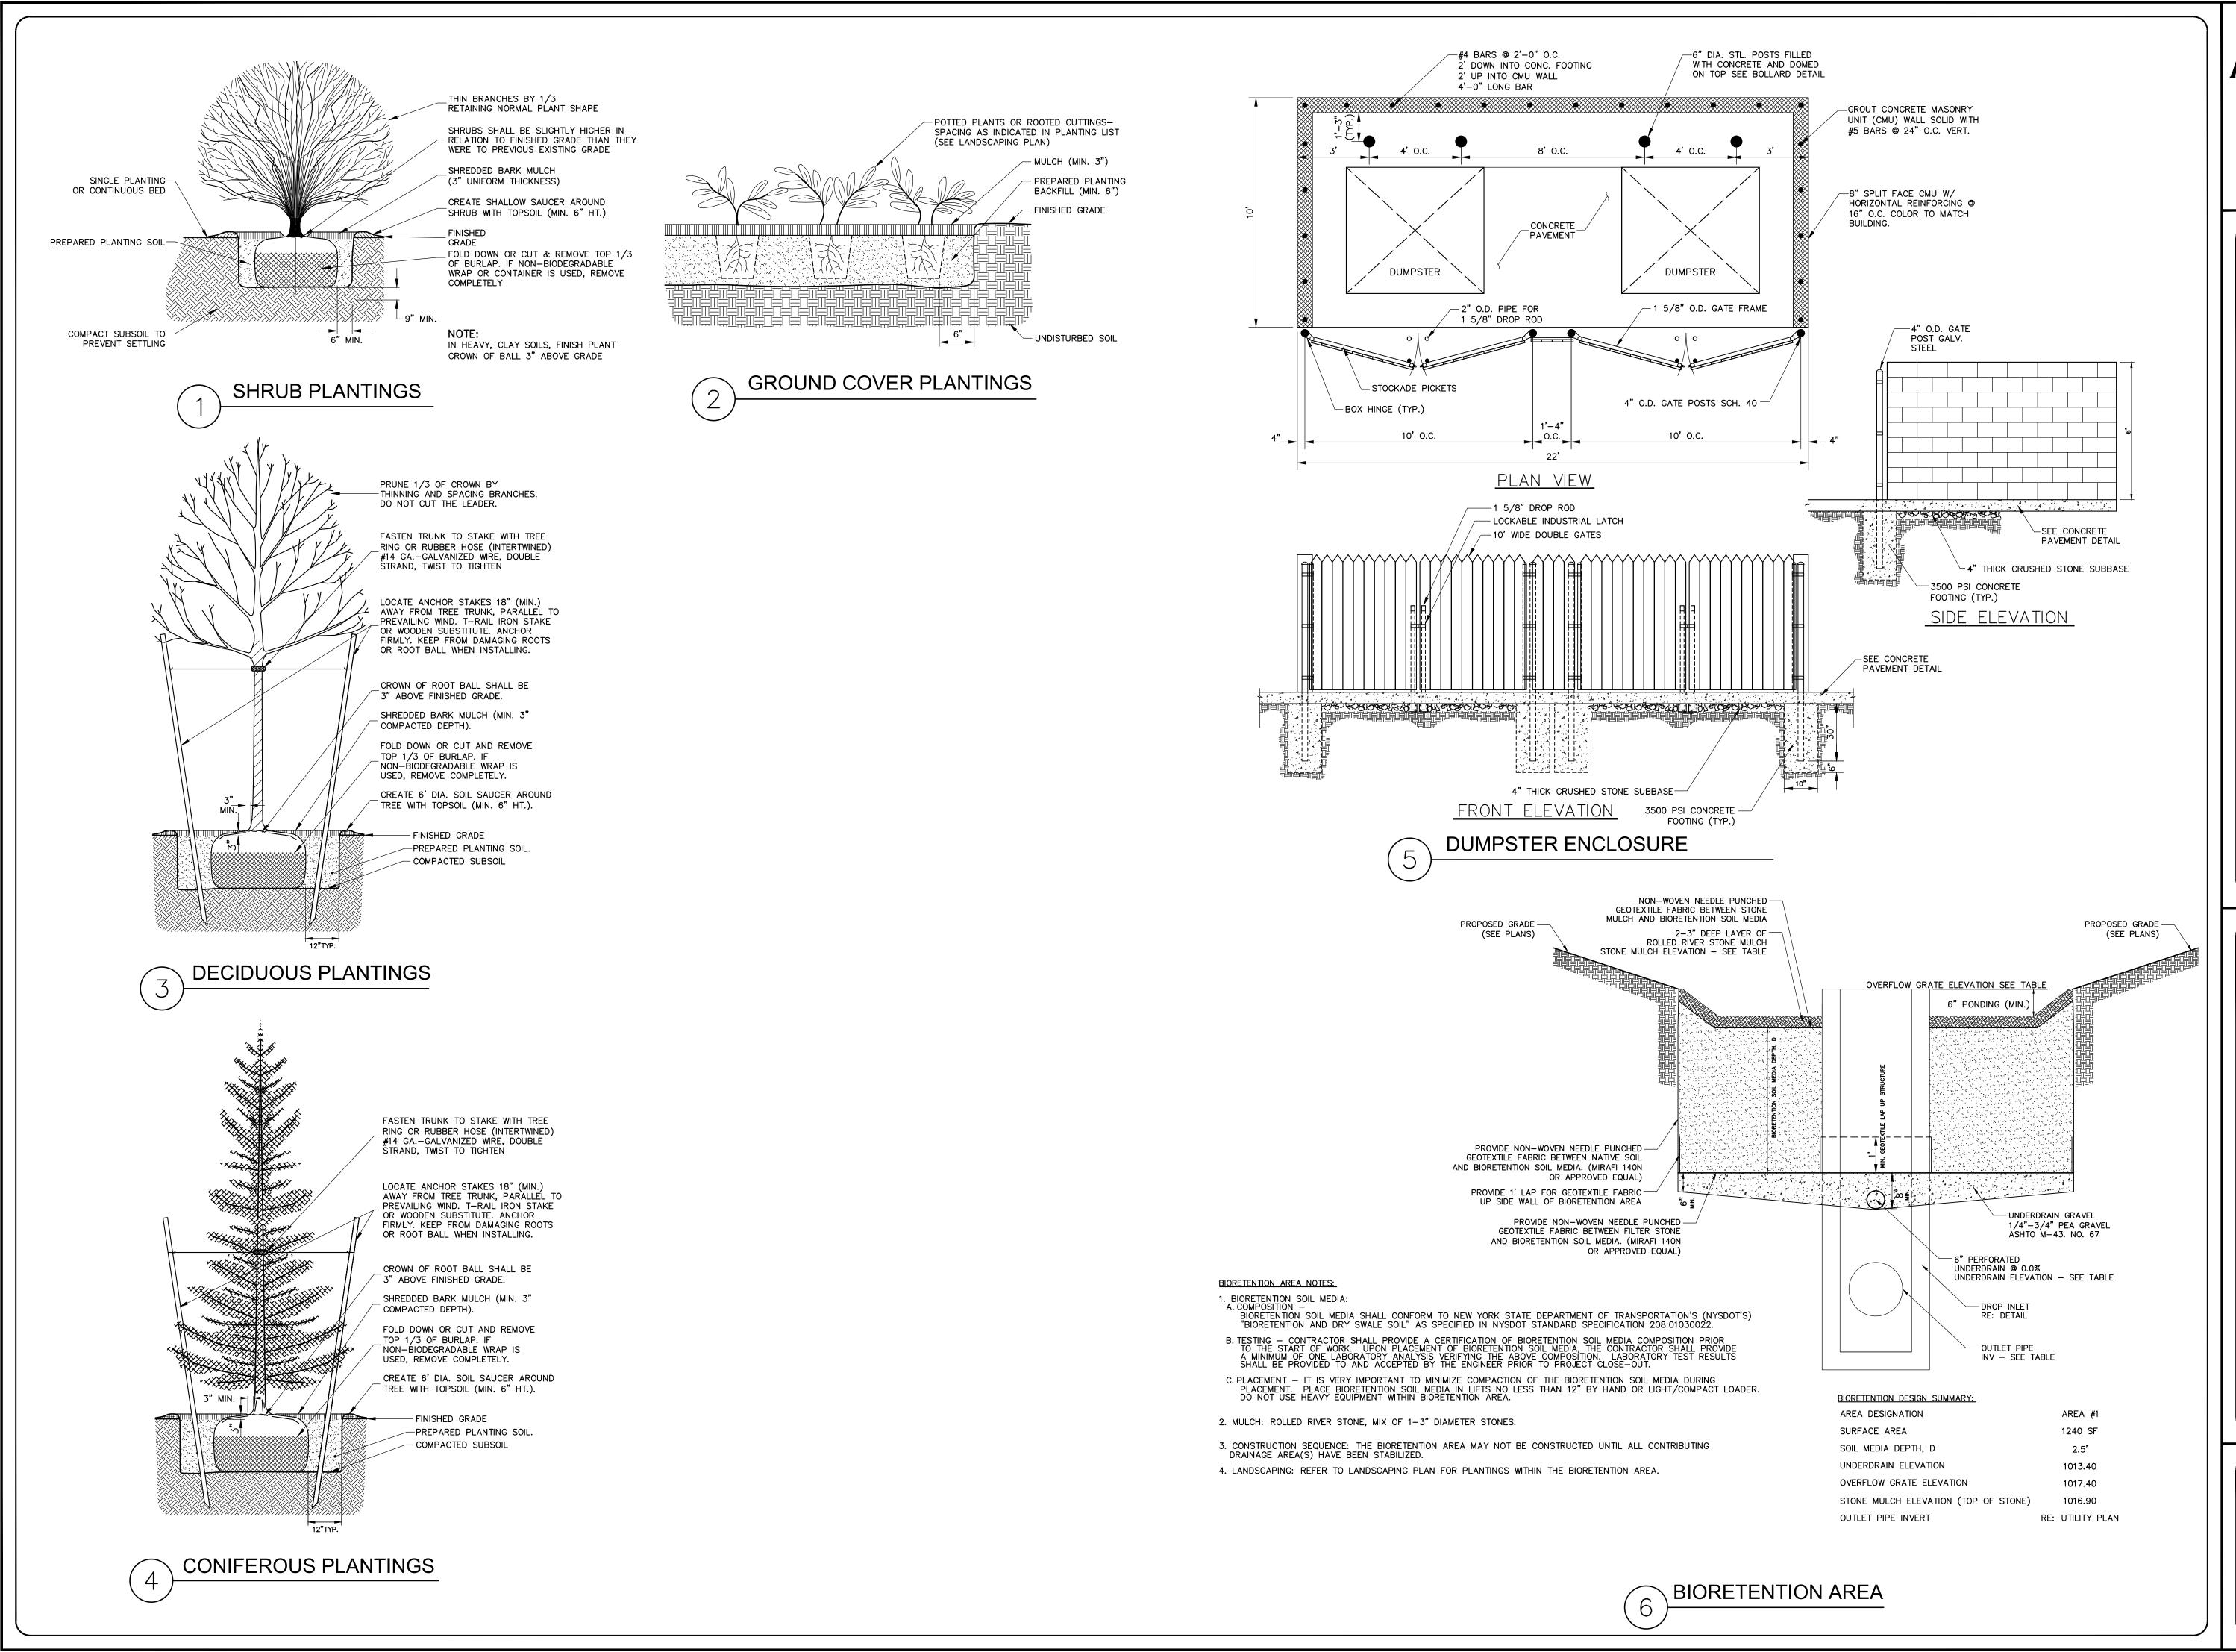

> 39 CASCADE DRIVE ROCHESTER, NY 14614 5 8 5 - 4 5 8 - 7 7 7 0 ITHACA LOCATION 840 HANSHAW RD, STE 6 ITHACA, NY 14850

6 0 7 - 2 4 1 - 2 9 1 7

www.marathoneng.com

1

 \geq

S

JOB NO:

SCALE:

1495-22 1"=30' AMF

DRAWN: DESIGNED: 8/30/23 REVISIONS DATE BY REVISION 9/21/23 AF TOWN SUBMITTAL

IY PERSON, UNLESS ACTING UNDER THE DIRECTION OF A LICENSED PROFESS GINEER OR LAND SURVEYOR, TO ALTER IN ANY WAY, AN ITEM BEARING THE SEA SIONAL ENGINEER OR LAND SURVEYOR. IF AN ITEM BEARING THE SEAL


SURVEYOR SHALL AFFIX TO THE ITEM THEIR SEAL AND THE NOTATION "ALTEREI FOLLOWED BY THEIR SIGNATURE AND THE DATE OF SUCH ALTERATION, AND A SPI DESCRIPTION OF THE ALTERATION. COPYRIGHT $^{\odot}$ 2023 MARATHON ENG.

CONSTRUCTION NO. 086648 ADAM M. FISHEL

DRAWING TITLE: Detail Sheet (5 of 6) SHEET No:

DRAWING No:

1495-22

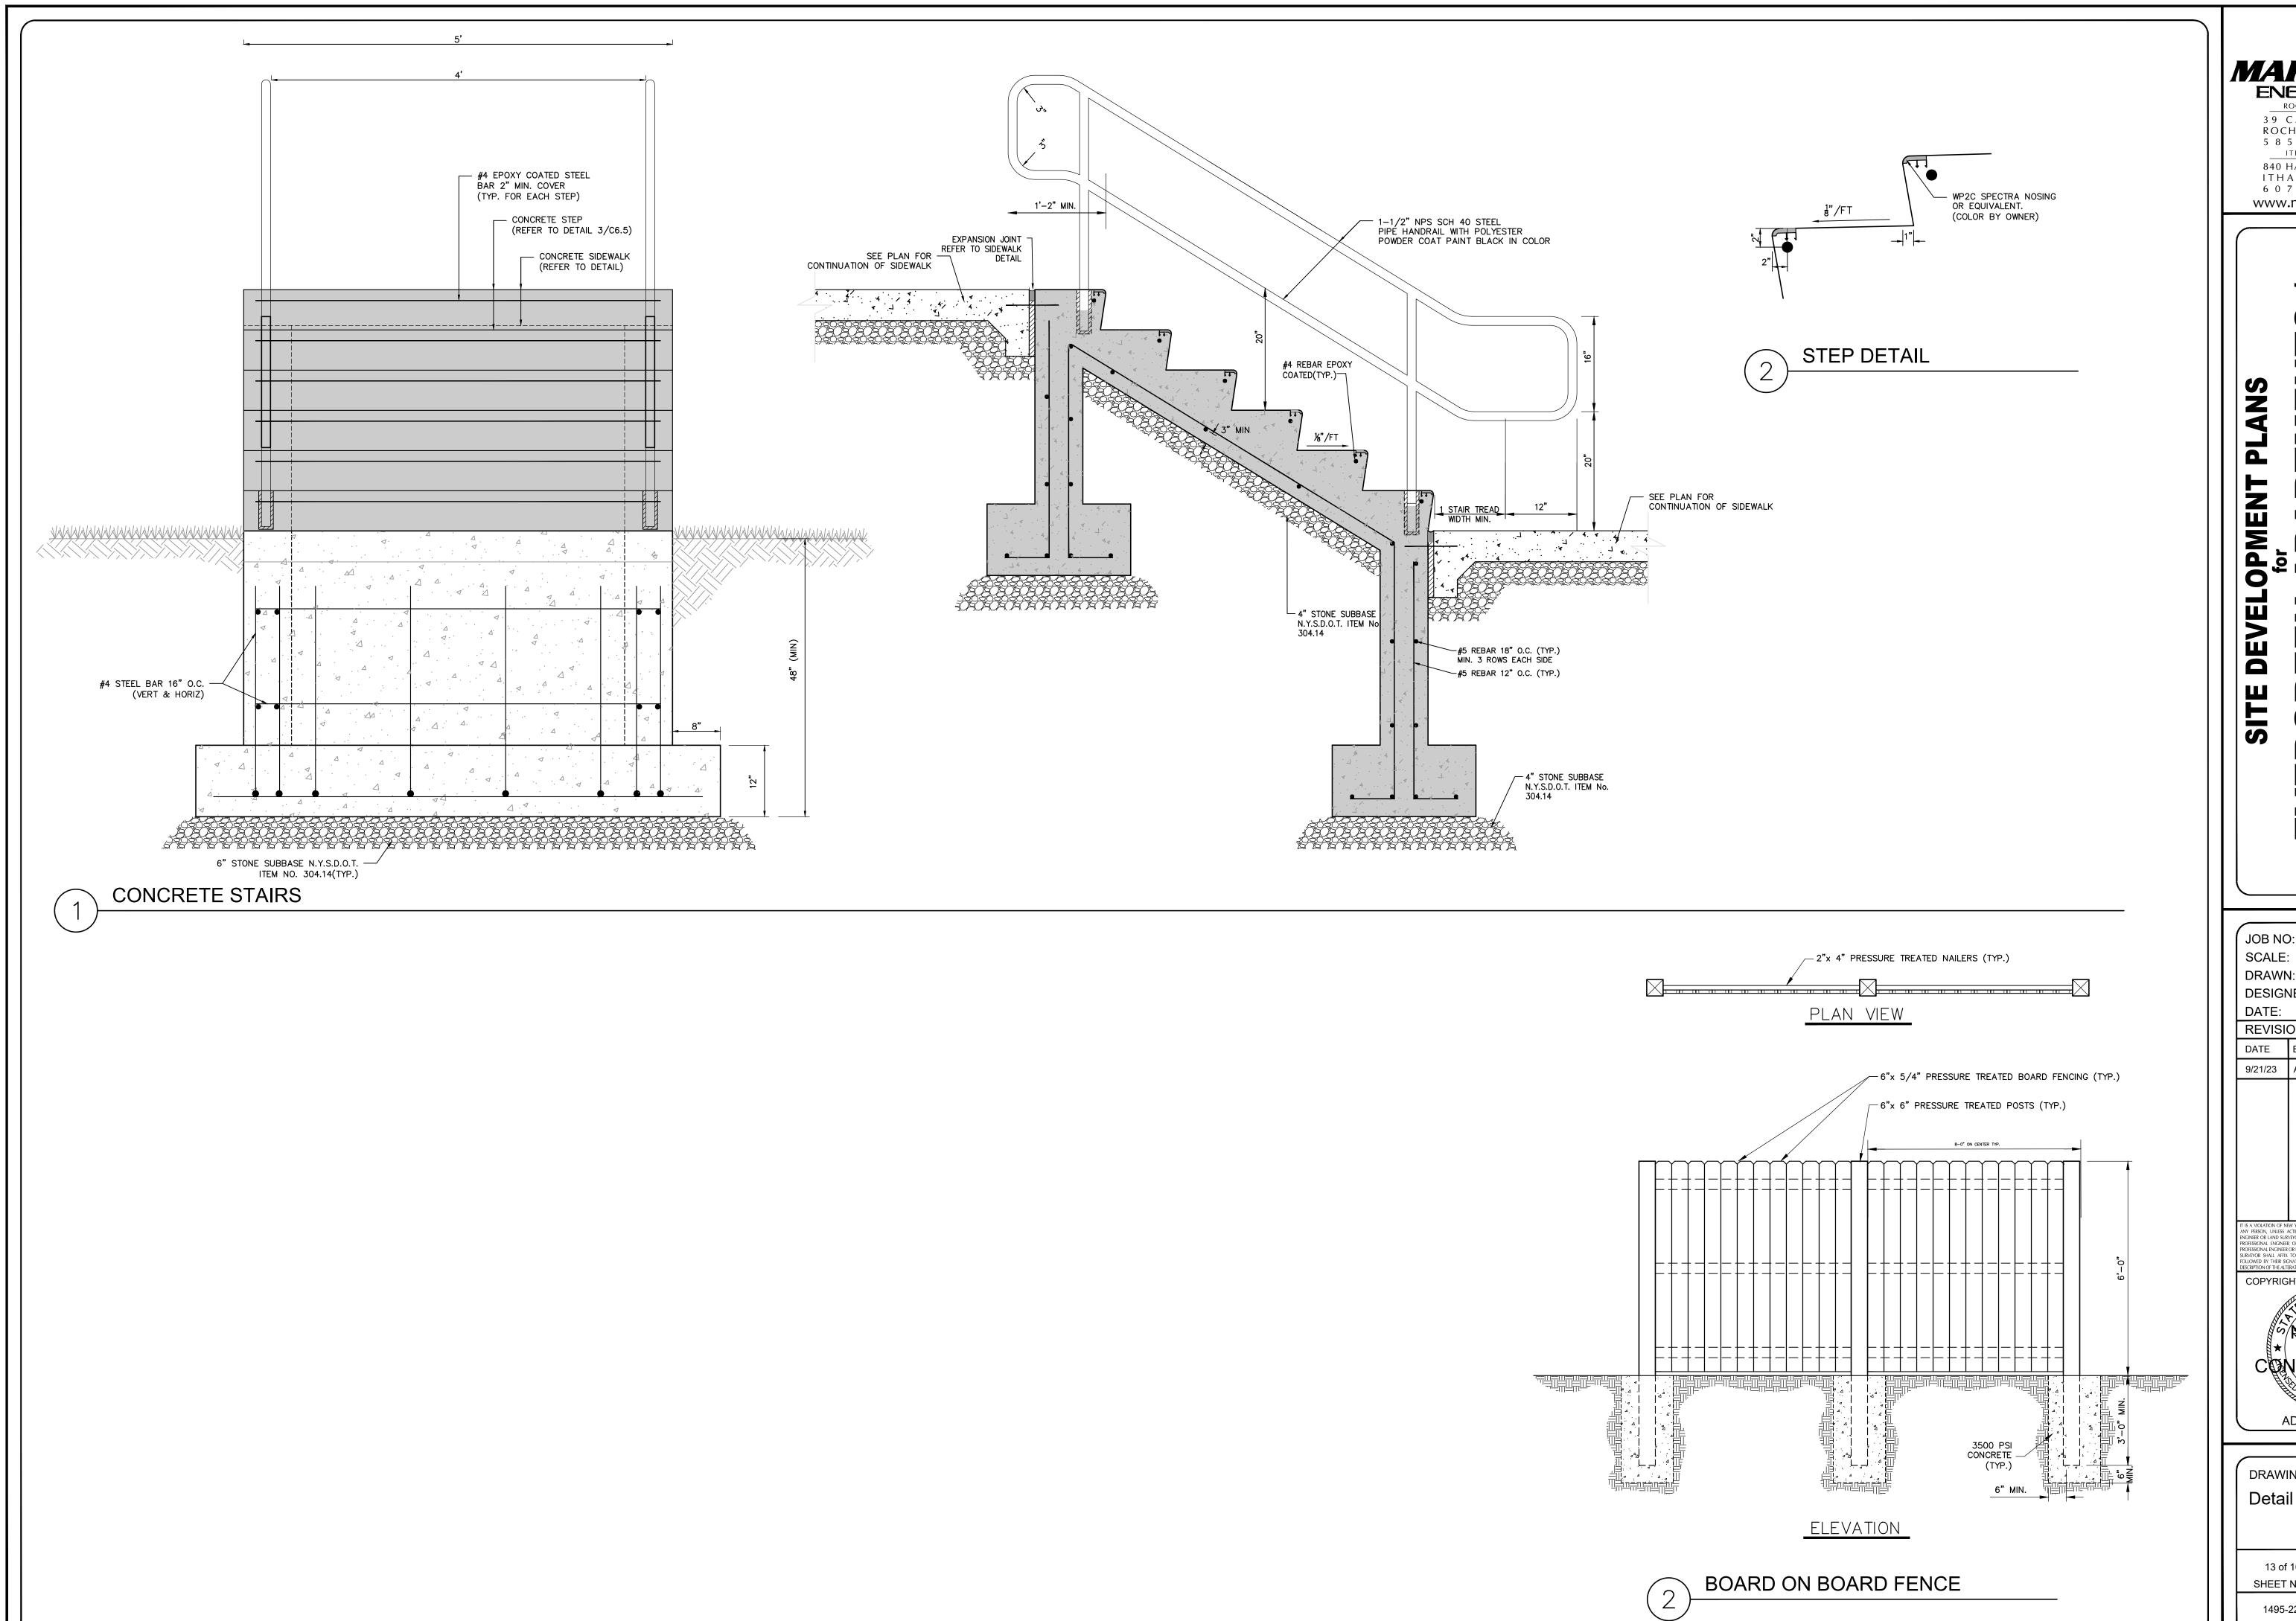

3 9 CASCADE DRIVE ROCHESTER, NY 14614 5 8 5 - 4 5 8 - 7 7 7 0 ITHACA LOCATION 840 HANSHAW RD, STE 6 ITHACA, NY 14850

6 0 7 - 2 4 1 - 2 9 1 7 www.marathoneng.com

TMENTS /

COAD (NYS ROUTE 366)

1061 DRYDEN ROAD (NYS ROAD TOMPKINS COUNTY

JOB NO: 1495-22 SCALE: 1"=30' DRAWN: RLJ DESIGNED: AMF

DESIGNED: AMF
DATE: 8/30/23

REVISIONS

DATE BY REVISION

9/21/23 AF TOWN SUBMITT

DATE BY REVISION

9/21/23 AF TOWN SUBMITTAL

IT IS A VIOLATION OF NEW YORK STATE EDUCATION LAW ARTICLE 145, SECTION 7209 FO ANY PERSON, UNLESS ACTING UNDER THE DIRECTION OF A LICENSED PROFESSIONA ENGINEER OR LAND SURVEYOR, TO ALITER IN ANY WAY, AN ITEM BEARING THE SEAL OF, PROFESSIONAL ENGINEER OR LAND SURVEYOR IS ALTERED, THE MEARING THE SEAL OF, PROFESSIONAL ENGINEER OR LAND SURVEYOR IS ALTERED, THE ALTERING ENGINEER OR LAND SURVEYOR SHALL AFIX TO THE ITEM THEIR SEAL AND THE NOTATION "ALTERED BY FOLLOWED BY THEIR SIGNATURE AND THE DATE OF SUCH ALTERATION, AND A SPECIFIC DESCRIPTION OF THE ALTERATION.

COPYRIGHT © 2023 MARATHON ENG.

DRAWING TITLE:


Detail Sheet (6 of 6)

13 of 16
SHEET No:

13 of 16
SHEET No:

1495-22
JOB No:

DRAWING No:

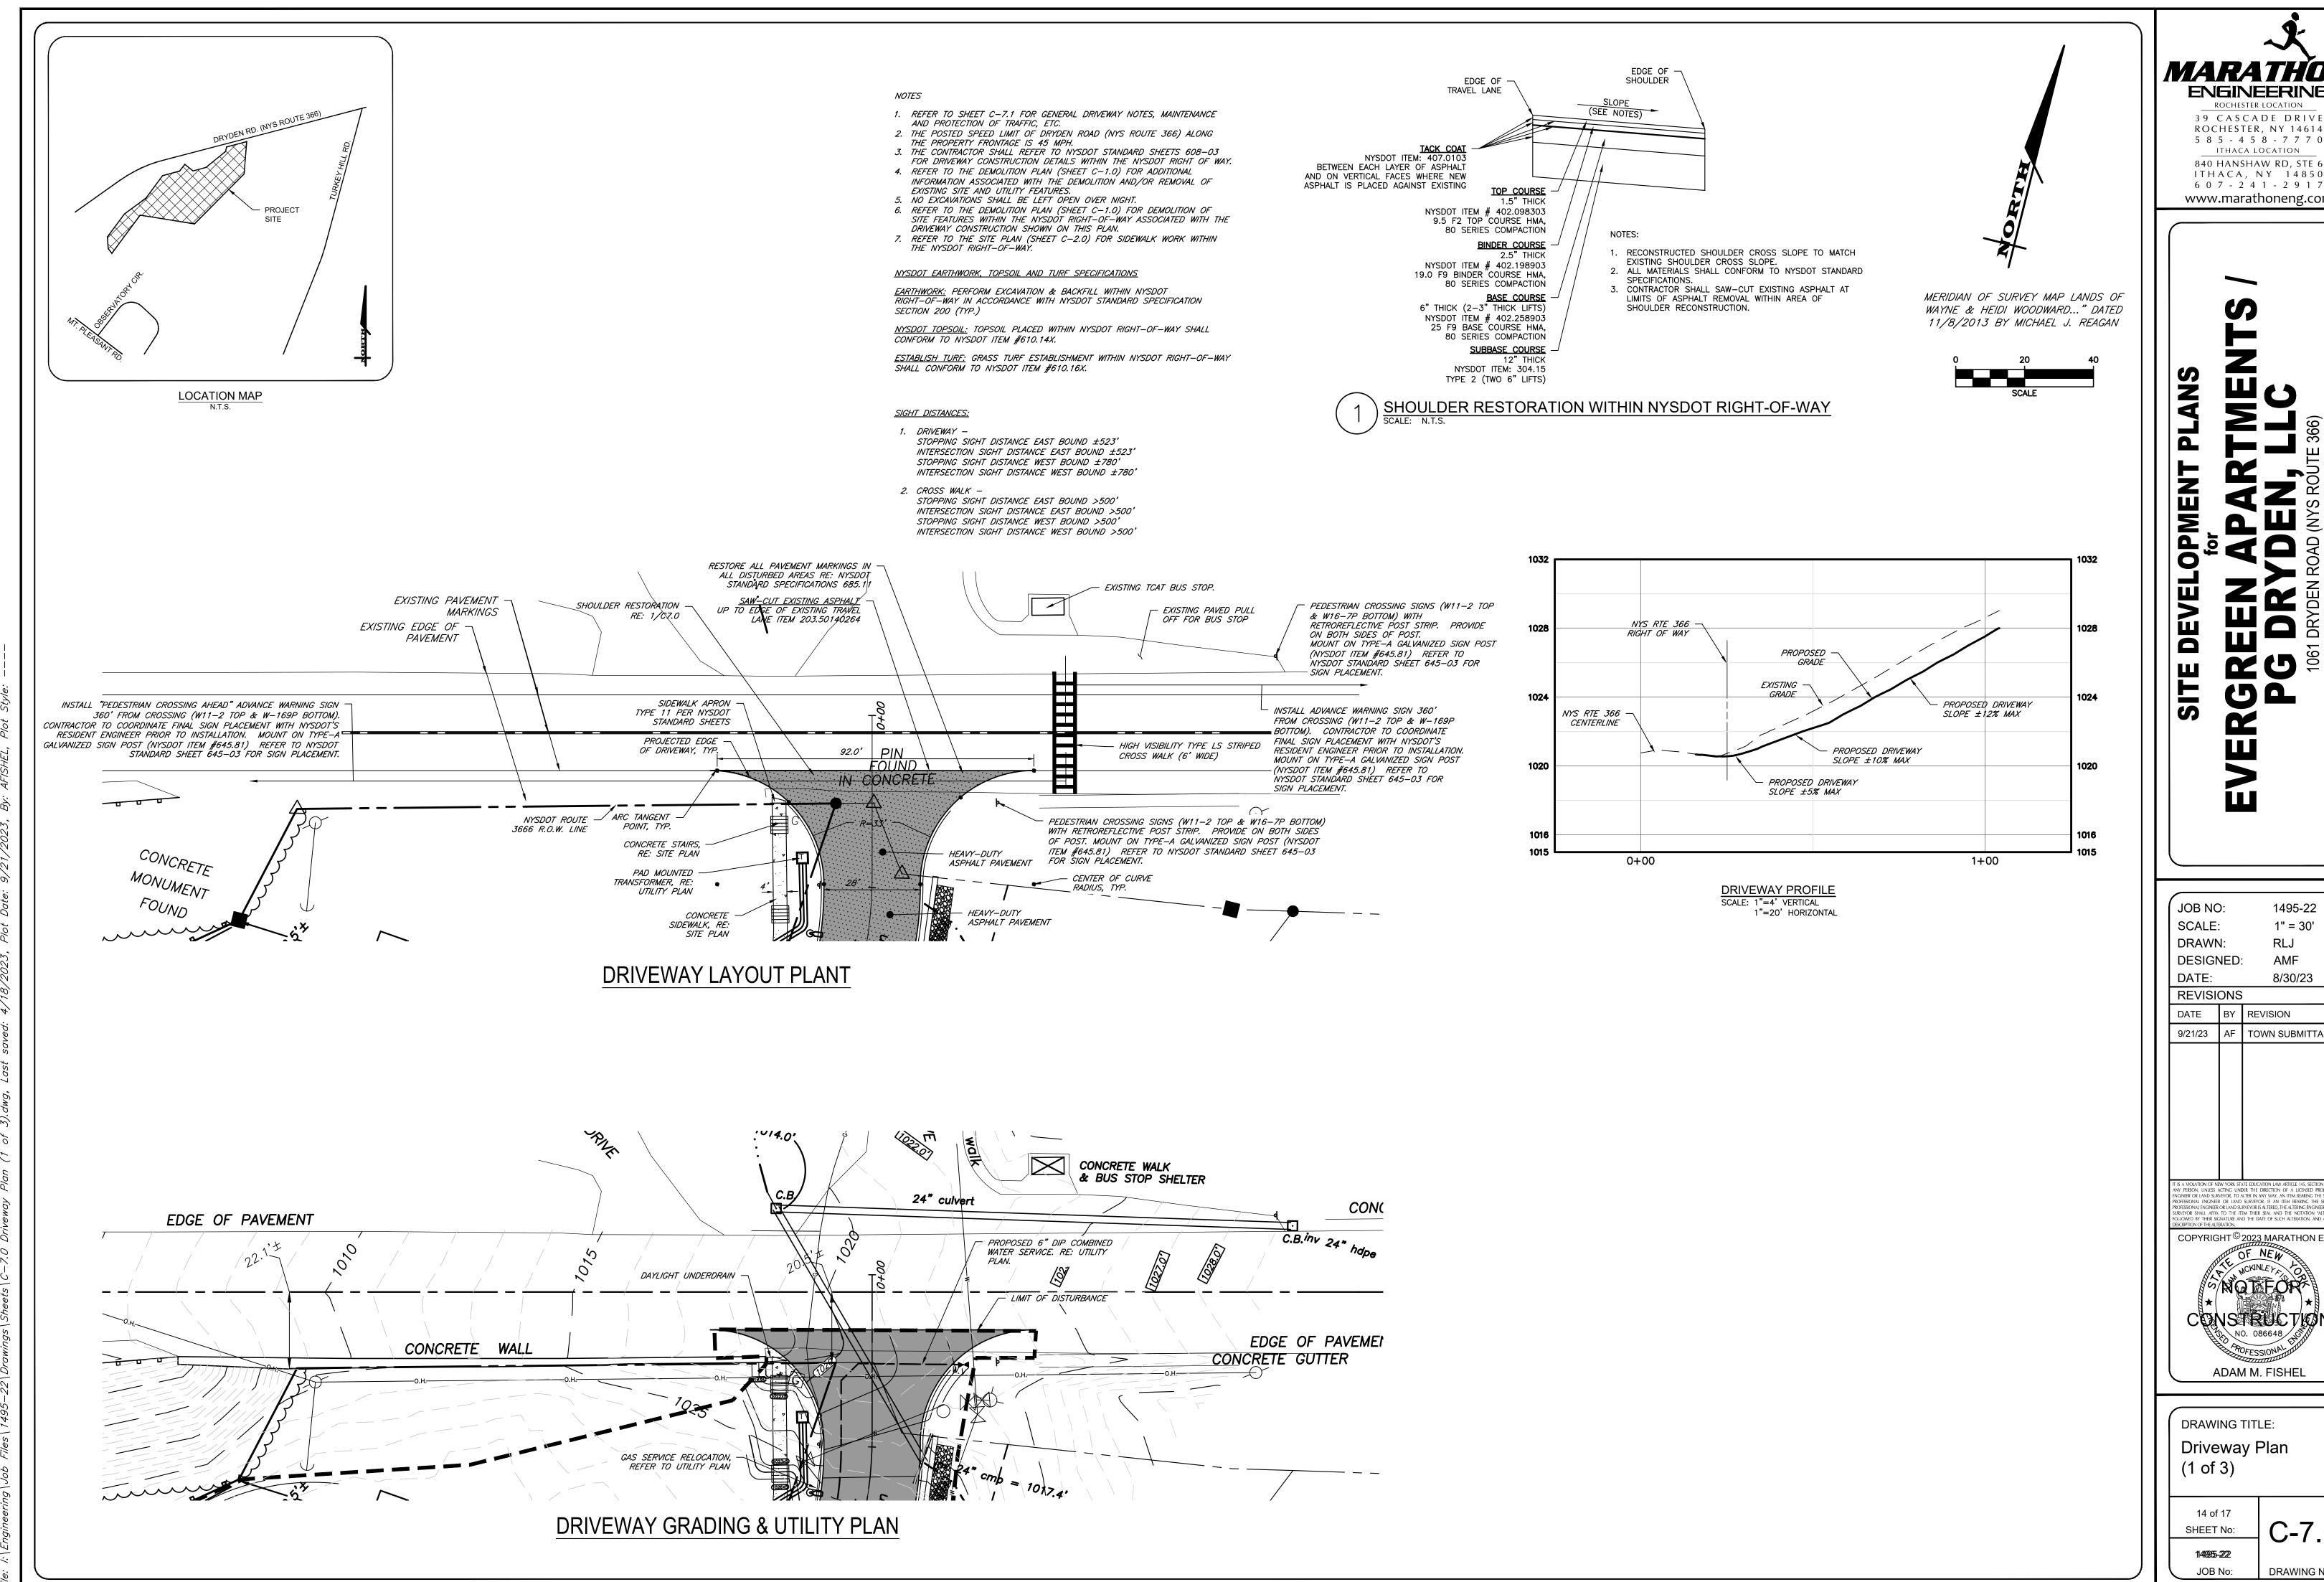

39 CASCADE DRIVE ROCHESTER, NY 14614 5 8 5 - 4 5 8 - 7 7 7 0 ITHACA LOCATION 840 HANSHAW RD, STE 6 ITHACA, NY 14850

6 0 7 - 2 4 1 - 2 9 1 7 www.marathoneng.com

1495-22 1" = 30' RLJ AMF

8/30/23

DATE BY REVISION 9/21/23 AF TOWN SUBMITTAL


COPYRIGHT[©] 2<u>023 M</u>ARATHON ENC

ADAM M. FISHEL

DRAWING TITLE: Driveway Plan (1 of 3)

SHEET No:

C-7.011419955-222 DRAWING No:

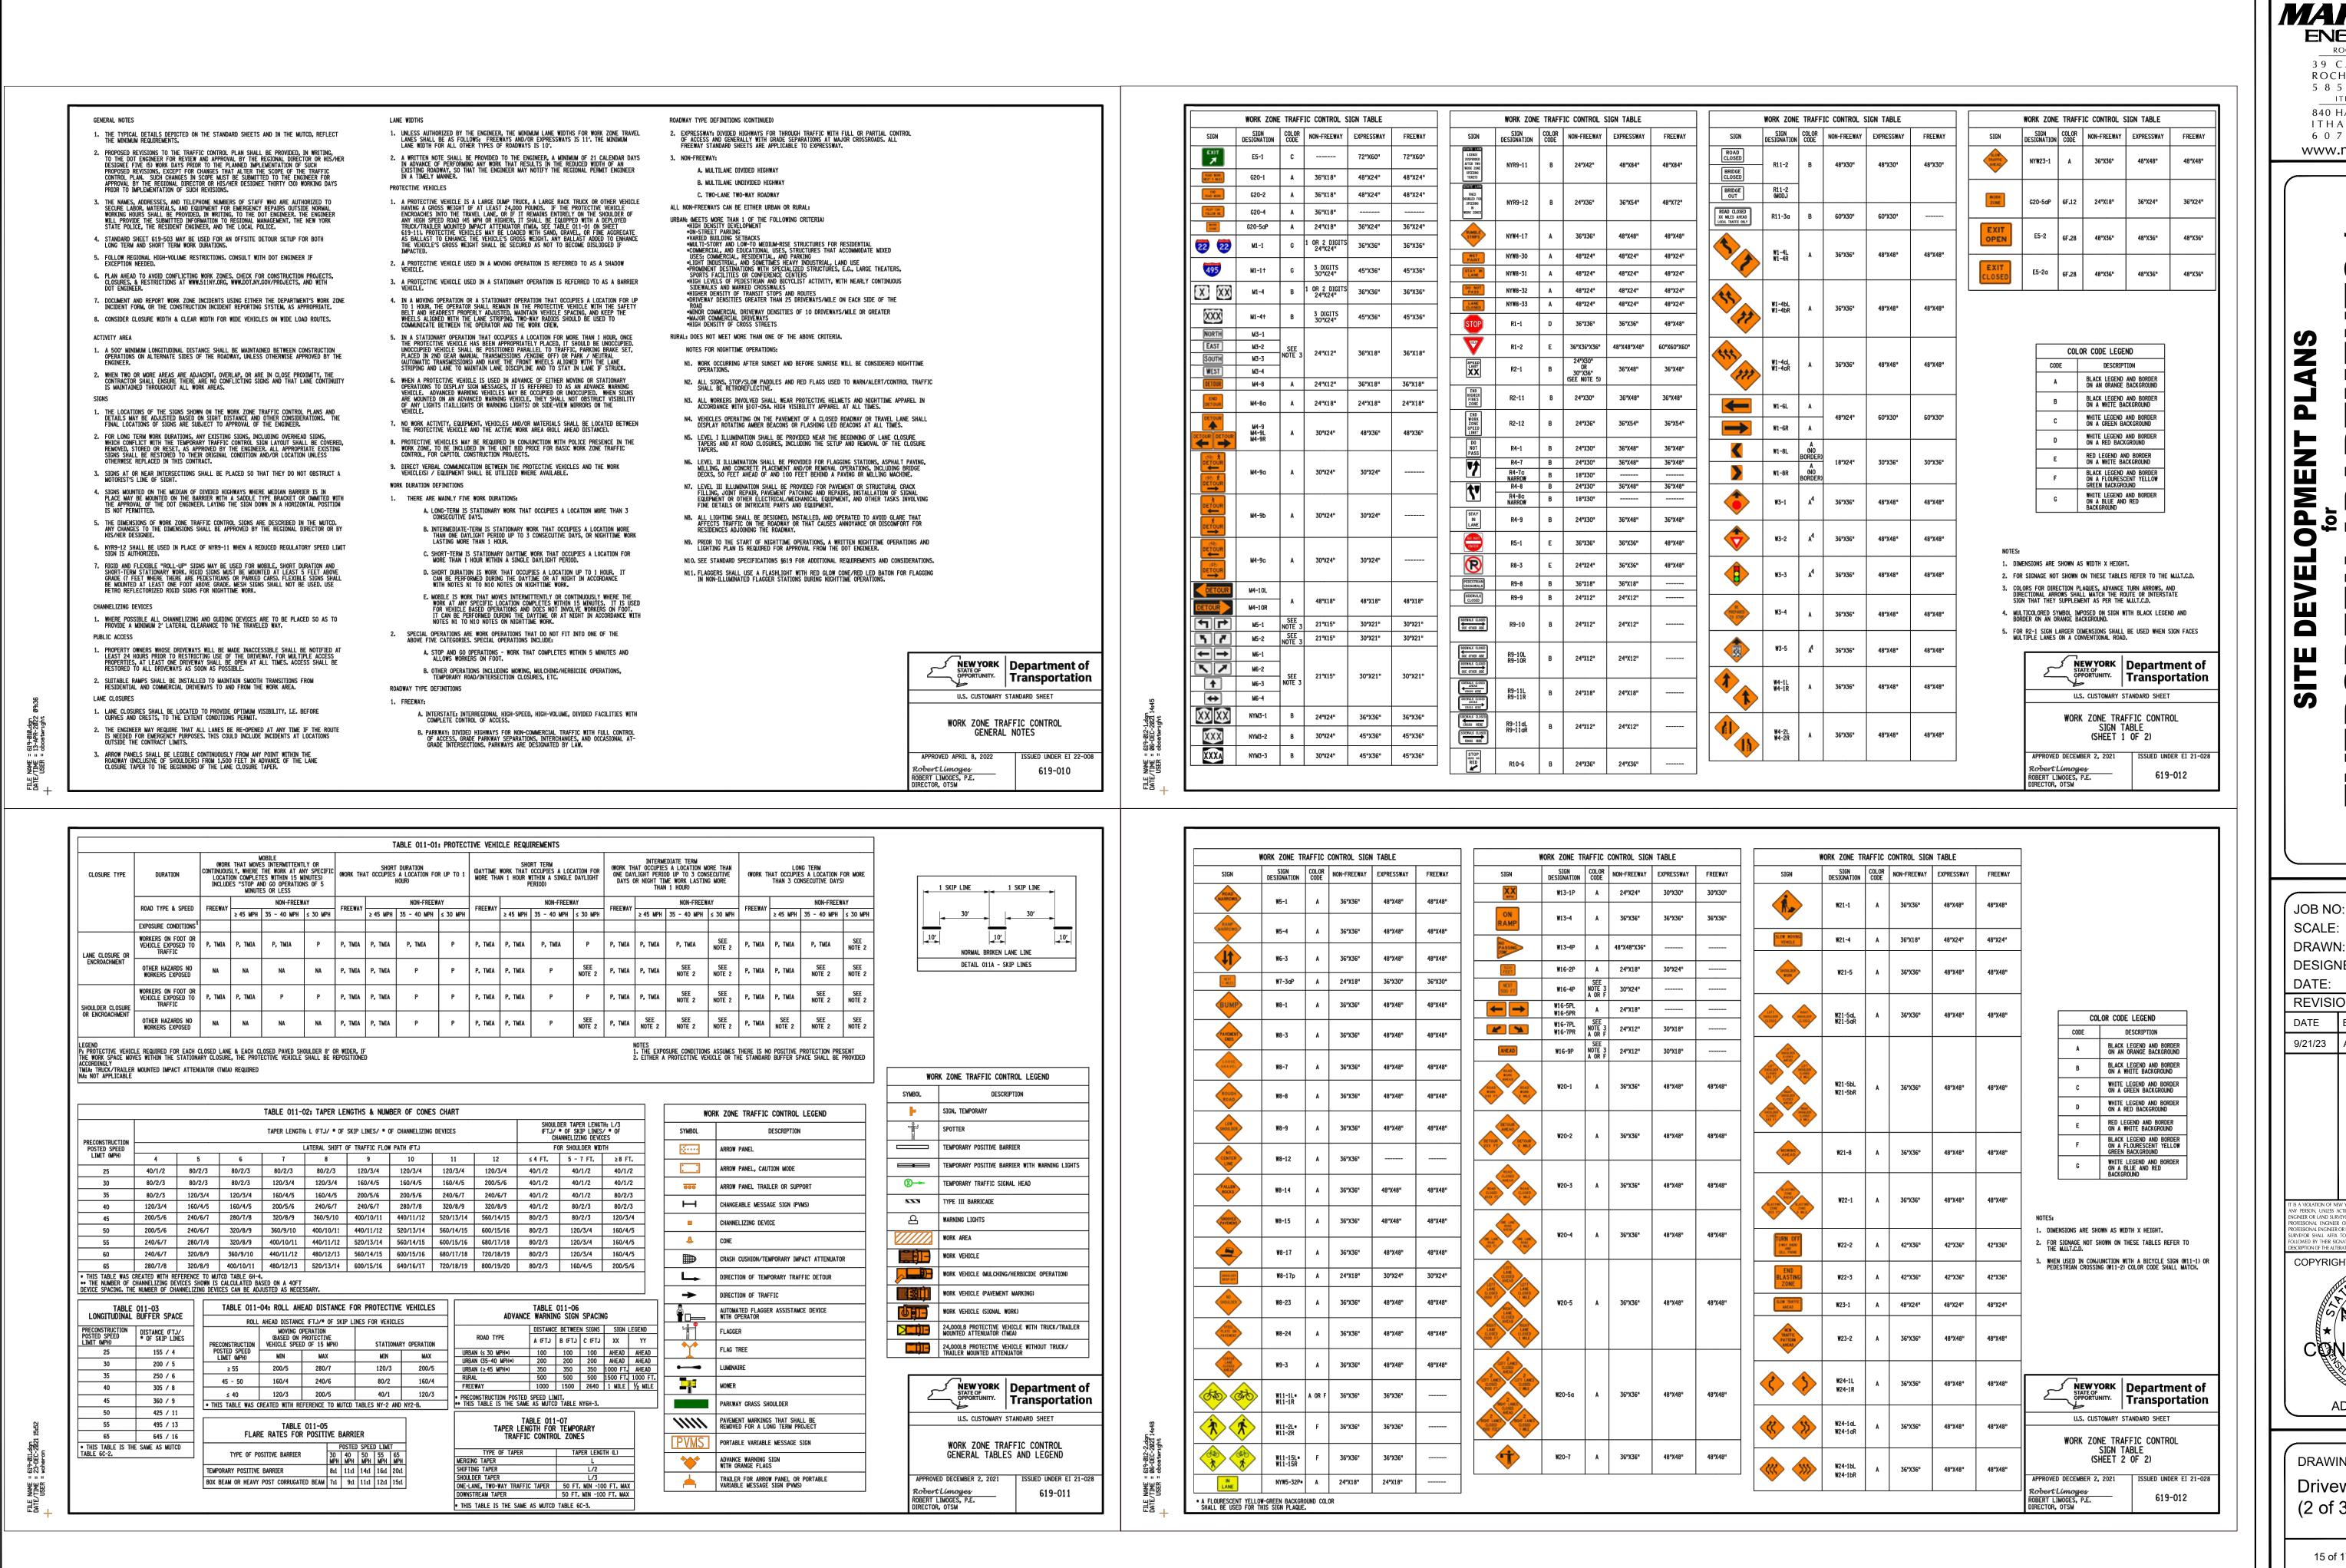

MARATHON **ENGINEERING**

> 39 CASCADE DRIVE ROCHESTER, NY 14614 5 8 5 - 4 5 8 - 7 7 7 0 ITHACA LOCATION 840 HANSHAW RD, STE 6 ITHACA, NY 14850

ROCHESTER LOCATION

6 0 7 - 2 4 1 - 2 9 1 7

www.marathoneng.com

(D)

OF

1495-22 NA RLJ **AMF**

DESIGNED: 8/30/23 REVISION

REVISIONS DATE BY 9/21/23 AF TOWN SUBMITTAL

any person, unless acting under the direction of a licensed professi Engineer or land surveyor, to alter in any way, an item bearing the seal SIONAL ENGINEER OR LAND SURVEYOR, IF AN ITEM BEARING THE SEAL

COPYRIGHT© 2023 MARATHON ENG

MCKINLEY CONSTRUCT NO. 086648 ADAM M. FISHEL


DRAWING TITLE: Driveway Plan (2 of 3)


> 15 of 17 1141925-222

> > DRAWING No:

SHEET No:

JOB No:

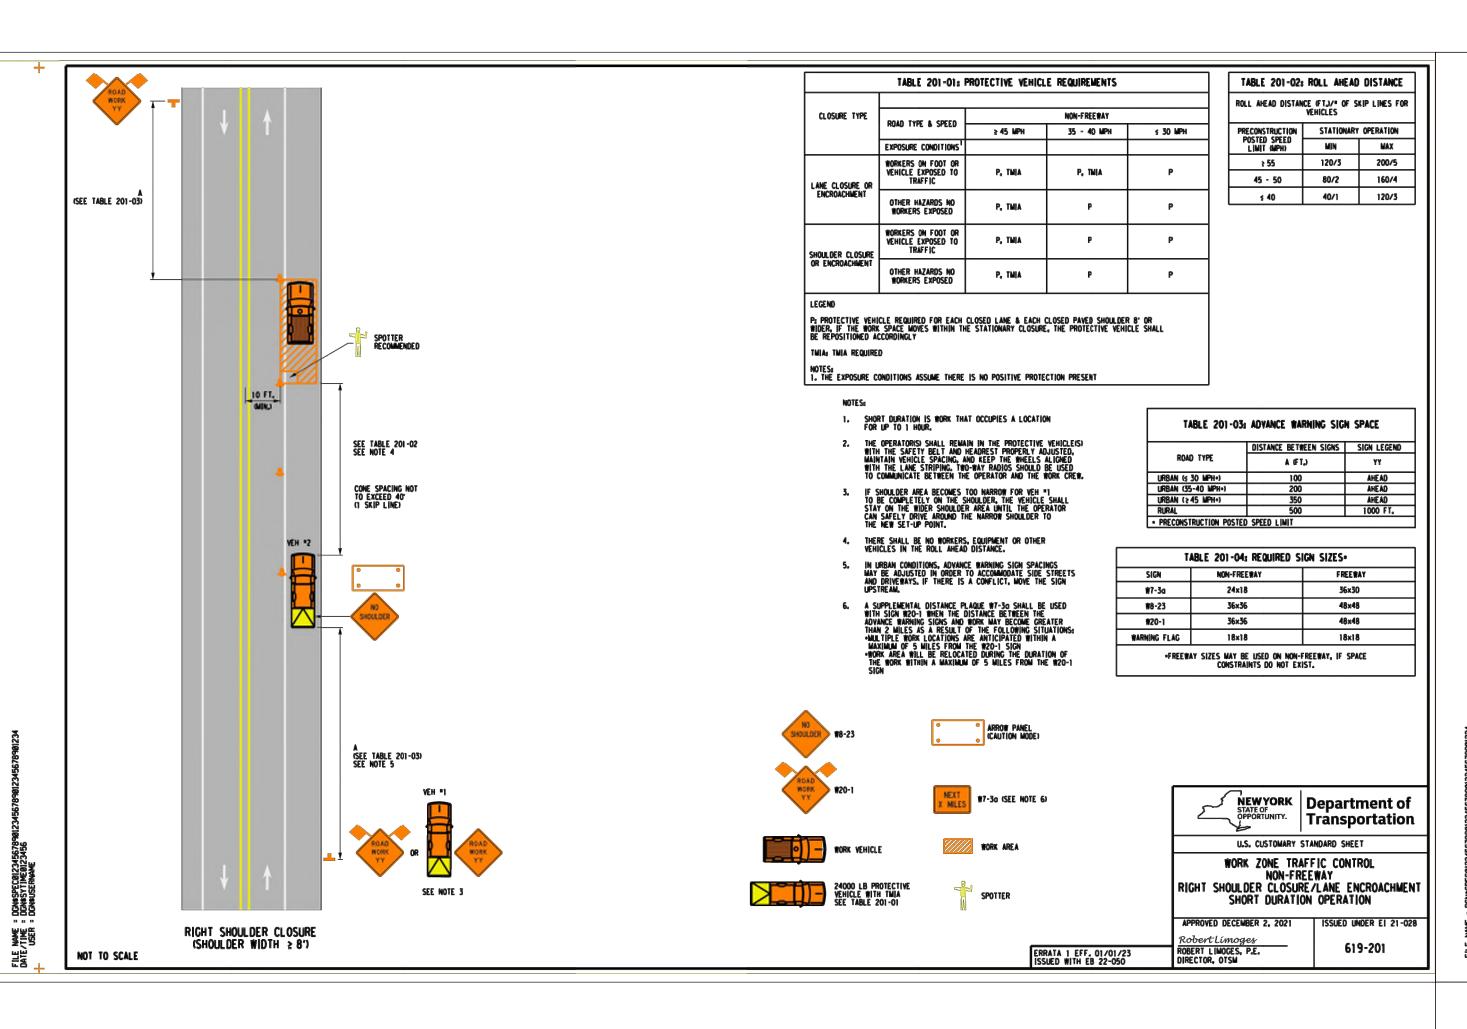

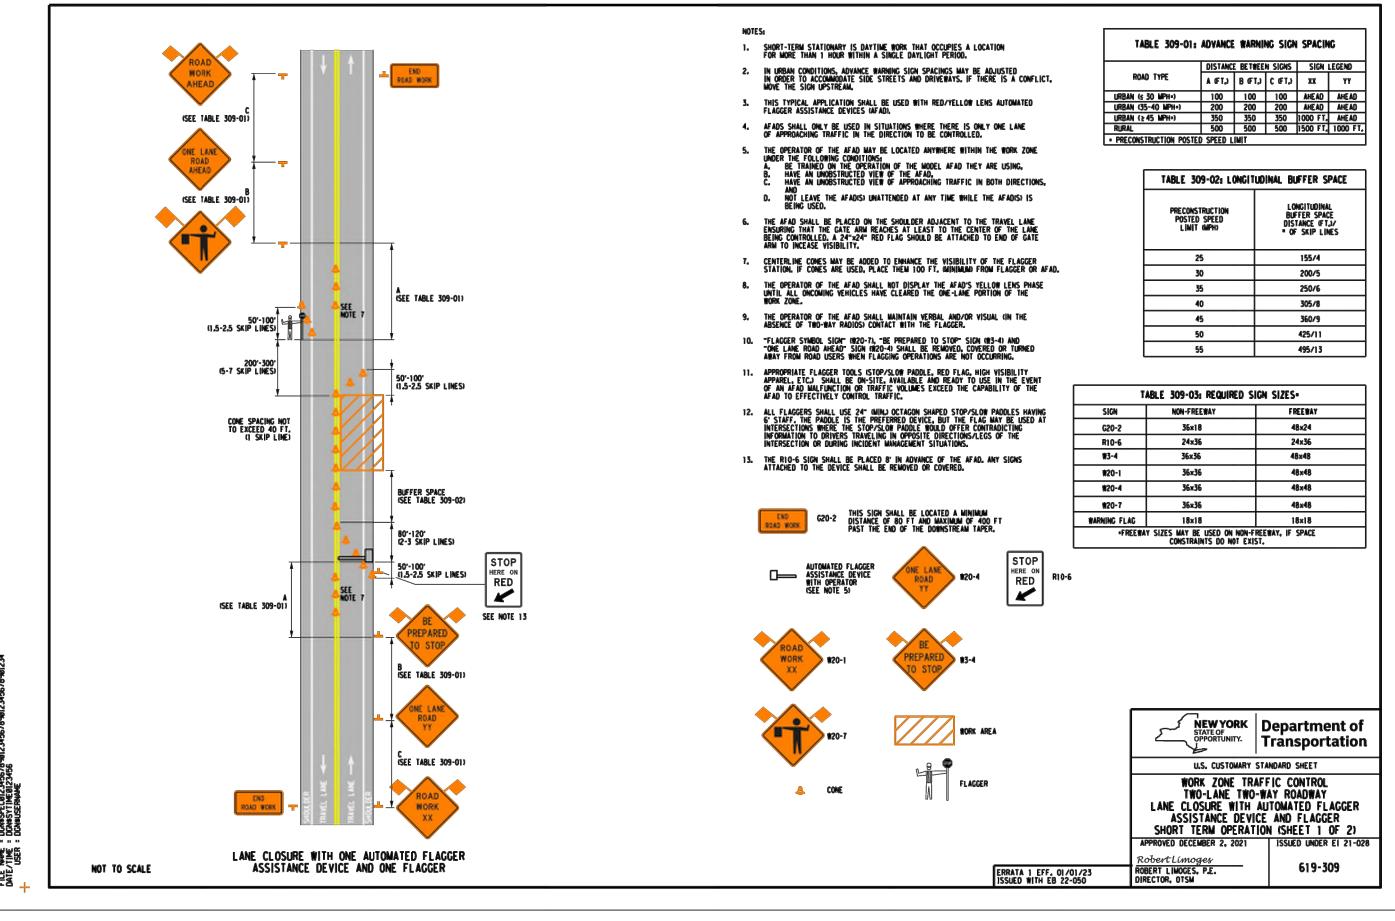

1. WORK ZONE TRAFFIC CONTROL REVISIONS

PROPOSED REVISIONS TO THE WORK ZONE TRAFFIC CONTROL (WZTC) PLAN OR MODIFICATIONS TO THE 619 STANDARD SHEETS SHALL BE SUBMITTED TO THE ENGINEER FOR THE REVIEW AND APPROVAL BY THE REGIONAL TRAFFIC ENGINEER PRIOR TO THE PLANNED IMPLEMENTATION OF SUCH REVISIONS OR MODIFICATIONS. THE CONTRACTOR SHALL NOT IMPLEMENT THE PROPOSED REVISIONS WITHOUT APPROVAL FROM THE REGIONAL TRAFFIC ENGINEER. WHEN APPLICABLE, NYSDOT WORK ZONE TRAFFIC CONTROL (WZTC) TYPICAL APPLICATIONS SHALL BE USED. TYPICALS CAN BE FOUND AT Miles / Anthonor del sugar / red - sone-institle - control

2. TRAVEL LANE WIDTHS IN WORK ZONES

WHERE NOT SHOWN IN THE WZTC PLANS OR OTHERWISE AUTHORIZED BY NYS DOT (OR THE ENGINEER), TRAVEL LANE WIDTHS IN WORK ZONES SHALL BE A MINIMUM OF 11 FT ON FREEWAYS, RAMPS, EXPRESSWAYS AND MULTI-LANE* CONVENTIONAL ROADWAYS AND 10 FT ON ALL OTHER CONVENTIONAL ROADWAYS *(MULTI-LANE ROADWAYS ARE THOSE WITH TWO OR MORE THRU LANES IN ONE OR BOTH DIRECTIONS.)

3. DAILY LANE, RAMP AND SHOULDER CLOSURE RESTRICTIONS

WORK ZONES SHALL BE RESTRICTED TO ONE SIDE OF THE ROADWAY AT A TIME IN EACH DIRECTION ON DIVIDED ROADWAYS, UNLESS THE CONTRACTOR SHALL SCHEDULE WORK SO THAT ALL TRAVEL LANES AND RAMPS IN EACH DIRECTION ARE OPEN WHEN THE CONTRACTOR'S OPERATIONS ARE CLOSED DOWN OR SUBSTANTIALLY CLOSED DOWN. DAILY CLOSURES MAY OCCUR OFF OF LONG-TERM CLOSURES AND SHALL BE SUBJECT TO DAILY CLOSURE RESTRICTIONS. WORK ZONES SHALL BE RESTRICTED TO ONE SIDE OF THE ROADWAY AT A TIME ON UNDIVIDED HIGHWAYS.

4. FLAGGING OPERATIONS

WHEN A PEDESTRIAN APPROACHES A FLAGGER STATION, THE FLAGGER SHALL STOP TRAFFIC AND DIRECT THE PEDESTRIAN TO A SAFE ROUTE THROUGH THE WORK AREA. FLAGGERS SHALL COORDINATE THE FLAGGING OF THE WORK ZONE TO ENSURE PEDESTRIANS CAN SAFELY PROCEED THROUGH THE AREA. IF THERE IS MORE THAN THE OCCASIONAL PEDESTRIAN WITHIN THE PROJECT LIMITS, REFER TO THE SITE SPECIFIC PEDESTRIAN WZTC PLAN.

5. HOLIDAY CLOSURE RESTRICTIONS

DAILY LANE, RAMP AND SHOULDER CLOSURES SHALL NOT BE PERMITTED ON DATES LISTED BELOW DURING THE FOLLOWING HOLIDAY

6:00 AM FRIDAY, MAY 27, 2022 THRU 6:00 AM TUESDAY, MAY 31, 2022 - (MEMORIAL DAY HOLIDAY) 6:00 AM FRIDAY, JULY 1, 2022 THRU 6:00 AM TUESDAY, JULY 5, 2022 - (JULY 4TH HOLIDAY) 6:00 AM FRIDAY, SEPTEMBER 2, 2022 THRU 6:00 AM TUESDAY, SEPTEMBER 6, 2022 - (LABOR DAY HOLIDAY)

6:00 AM WEDNESDAY, NOVEMBER 23, 2022 THRU 6:00 AM MONDAY, NOVEMBER 28, 2022 - (THANKSGIVING HOLIDAY) 6:00 AM FRIDAY, DECEMBER 23, 2022 THRU 6:00 AM TUESDAY, DECEMBER 27, 2022 - (CHRISTMAS HOLIDAY) 6:00 AM FRIDAY, DECEMBER 30, 2022 THRU 6:00 AM TUESDAY, JANUARY 3, 2023 - (NEW YEAR'S HOLIDAY)

6. <u>NOTIFICATION REQUIREMENTS</u>

REGION 3 HAS A WORK ZONE TRAFFIC CONTROL (WZTC) NOTIFICATION POLICY WHICH REQUIRES ENGINEERS TO NOTIFY THE REGIONAL TRANSPORTATION MANAGEMENT CENTER (RTMC) PRIOR TO ALLOWING A CONTRACTOR TO IMPLEMENT WORK ZONE TRAFFIC CONTROL ACTIVITIES WITHIN THE HIGHWAY RIGHT OF WAY, WORK ZONE NOTIFICATION IS REQUIRED FOR THE FOLLOWING: FREEWAYS AND EXPRESSWAYS: ALL LANE, SHOULDER, ROAD, RAMP OR BRIDGE CLOSURES.

DISAPPROVAL TO PERFORM THE UNREPORTED WZTC ACTIVITY UNTIL THE ABOVE NOTIFICATIONS REQUIREMENTS ARE SATISFIED.

(THIS INCLUDES MOBILE OPERATIONS WHICH OCCUPY THE LANES OR SHOULDERS) ALL OTHER STATE HIGHWAYS: ALL LANE CLOSURES WHOSE DURATION WILL BE GREATER THAN 2 HOURS AND ALL ROAD/BRIDGE CLOSURES. THE CONTRACTOR SHALL REPORT PROPOSED WZTC ACTIVITIES NOTED ABOVE TO THE ENGINEER BY 8:00 AM OF THE BUSINESS WEEK DAY

(I.E. MONDAY THROUGH FRIDAY EXCLUDING HOLIDAYS) PRECEDING THE PROPOSED WZTC ACTIVITY. FAILURE TO DO SO WILL RESULT IN

NO PLANNED WZTC ACTIVITY SHALL BE IMPLEMENTED WITHOUT FIRST RECEIVING CLEARANCE FROM THE RTMC.

7. VEHICLE RESTRICTIONS

THE CONTRACTOR SHALL REPORT ANY RESTRICTION (AS DEFINED BELOW) ON HIGHWAYS, RAMPS, OR BRIDGES AT LEAST SIX (6) BUSINESS WEEKDAYS IN ADVANCE OF THE RESTRICTION. SIX (6) DAYS LEAD TIME IS NECESSARY TO PROVIDE THE RTMC ADEQUATE TIME TO PREVENT ISSUANCE OF SPECIAL HAULING PERMITS THAT WOULD ROUTE OVERSIZE VEHICLES OVER THE RESTRICTED SECTION OF THIS CONTRACT.

1: COMPLETE CLOSURE OF A HIGHWAY, RAMP OR BRIDGE. 2: INSTALLATION OF BARRIER OR CHANNELIZING DEVICES THAT RESULT IN AN UNOBSTRUCTED WIDTH LESS THAN 18 FEET ALONG A HIGHWAY, RAMP OR BRIDGE.

RESTRICTIONS SHALL BE DEFINED AS ONE OR MORE OF THE FOLLOWING:

TOMPKINS COUNTY: EMERGENCY CONTROL CENTER (607) 273-7288

3: SUITABLE DRIVING SURFACES OF LESS THAN 18 FEET IN WIDTH.

4: AVAILABLE VERTICAL CLEARANCE ABOVE THE HIGHWAY IS LESS THAN 14 FEET IN HEIGHT. 5: WORK WOULD LIMIT VEHICLE LENGTH (I.E. TURNING ABILITY) 6: CHANGING THE LOAD CAPACITY OF A HIGHWAY, RAMP OR BRIDGE.

THE CONTRACTOR SHALL ALSO GIVE VERBAL NOTIFICATION AT LEAST SEVEN (7) BUSINESS DAYS (I.E. MONDAY THROUGH FRIDAY EXCLUDING HOLIDAYS) PRIOR TO AND AT THE END OF A RESTRICTION ON ANY ROADWAY TO THE:

8. ACCESS

THE CONTRACTOR SHALL ENSURE THAT ACTIVE LANES OF TRAFFIC ON FREEWAYS ARE NOT CROSSED BY PEDESTRIAN WORKERS. FOR ALL

OTHER HIGHWAYS. THE CONTRACTOR SHALL ENSURE THAT PEDESTRIAN WORKERS CROSS ACTIVE LANES OF TRAFFIC ONLY AT PROPERLY PLAN ADDRESS ACCESS TO EACH WORK AND STAGING AREA.

CHANNELIZING DEVICE SPACING (CENTER TO CENTER) SHALL BE 40' MAXIMUM FOR POSTED SPEED LIMITS 40 MPH OR GREATER AND 20' MAXIMUM FOR POSTED SPEED LIMITS 35 MPH OR LESS. STANDARD CONES AND TUBULAR MARKERS SHALL NOT BE USED FOR CHANNELIZATION AND DELINEATION DURING THE HOURS OF DARKNESS, WHICH IS DEFINED AS THE PERIOD BETWEEN SUNSET AND SUNRISE.


ALL CONSTRUCTION SIGNS SHALL BE MOUNTED AT A HEIGHT OF 7 FEET ABOVE THE EDGE OF THE TRAVEL LANE. SIGNS SHALL NOT ENCROACH MORE THAN 4" INTO SHOULDERS USED BY PEDESTRIANS OR BICYCLES.

WHERE SHOULDER WIDTHS ARE LIMITED AND SIGNS CANNOT BE ERECTED BEYOND THE SHOULDER, CONSTRUCTION SIGNS MAY NEED TO BE MOUNTED ON CONCRETE MEDIAN BARRIERS, BRIDGE PARAPETS, ETC. PRIOR TO ERECTING THOSE SIGNS THE CONTRACTOR SHALL PROVIDE MOUNTING DETAILS TO THE ENGINEER FOR APPROVAL SEVEN (7) DAYS PRIOR TO ERECTING THE CONSTRUCTION SIGNS.

10. DELINEATORS

SINGLE LARGE DELINEATORS WITH RETROREFLECTIVE ASTM TYPE IX SHEETING 6" X 12", SHALL BE INSTALLED AT 20 FOOT INTERVALS FOR ALL LOCATIONS WHERE TEMPORARY CONCRETE BARRIER IS USED AND FOR ALL LOCATIONS WHERE PERMANENT CONCRETE BARRIER, GUIDE RAILING, AND/OR BRIDGE RAILING IS ADJACENT TO A LANE AND/OR SHOULDER WHERE THE WIDTH IS LESS THAN EXISTING. THE COLOR OF THE RETROREFLECTIVE DELINEATOR SURFACE SHALL MATCH THE COLOR OF THE EDGE OF PAVEMENT MARKINGS AS VIEWED BY APPROACHING TRAFFIC. DELINEATORS SHALL BE CLEARLY VISIBLE UNDER NORMAL CONDITIONS FROM A DISTANCE OF 1000 FEET WHEN ILLUMINATED BY THE HIGHBEAMS OF STANDARD AUTOMOBILE HEADLIGHTS. THE COST (INCLUDING REMOVAL) SHALL BE INCLUDED IN THE PRICE BID FOR ITEM 619.01, BASIC WORK ZONE TRAFFIC CONTROL.

THE CONTRACTOR'S FAILURE TO COMPLY WITH THE REQUIREMENTS AS STATED ABOVE WILL BE CONSIDERED UNSATISFACTORY TEMPORARY WORK ZONE TRAFFIC CONTROL. PAYMENT WILL BE WITHHELD FOR THE VARIOUS CONTRACT ITEMS WHICH CONTAIN WORK ZONE TRAFFIC CONTROL PROVISIONS IN ACCORDANCE WITH TABLE 619-7 FOR EACH DAY THAT FAILURE TO COMPLY OCCURS. FAILURE TO COMPLY WILL ALSO RESULT IN THE ASSESSMENT OF LIQUIDATED DAMAGES FOR EACH VIOLATION.

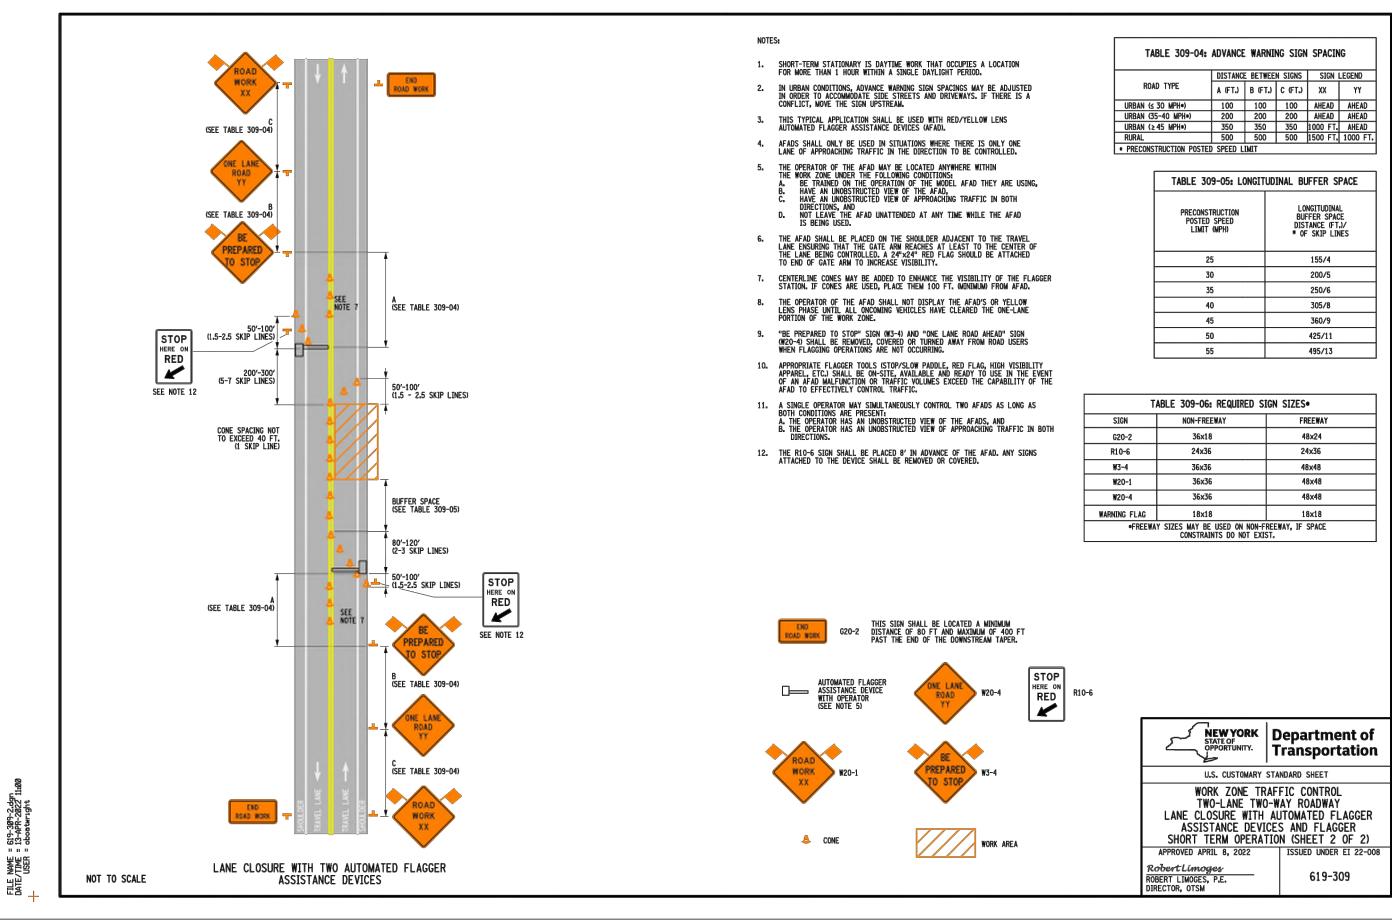

MARATHON **ENGINEERING**

> 39 CASCADE DRIVE ROCHESTER, NY 14614 5 8 5 - 4 5 8 - 7 7 7 0 ITHACA LOCATION 840 HANSHAW RD, STE 6 ITHACA, NY 14850 6 0 7 - 2 4 1 - 2 9 1 7

www.marathoneng.com

A

ME

0

VE

SITE

JOB NO: 1495-22 SCALE: NA DRAWN: RLJ DESIGNED: AMF DATE: 8/30/23

REVISIONS DATE BY REVISION 9/21/23 AF TOWN SUBMITTAL

ANY PERSON, UNLESS ACTING UNDER THE DIRECTION OF A LICENSED PROFES SIONAL ENGINEER OR LAND SURVEYOR, IF AN ITEM BEARING THE SEAL


WED BY THEIR SIGNATURE AND THE DATE OF SUCH ALTERATION, AND A S COPYRIGHT[©] 2<u>023 M</u>ARATHON ENG MCKINLEY) CONSTRUCT ∖NO. 086648

ADAM M. FISHEL

DRAWING TITLE: **DRIVEWAY PLAN** (3 OF 3)

> 16 of 17 SHEET No: 1141925-222

JOB No: DRAWING No:

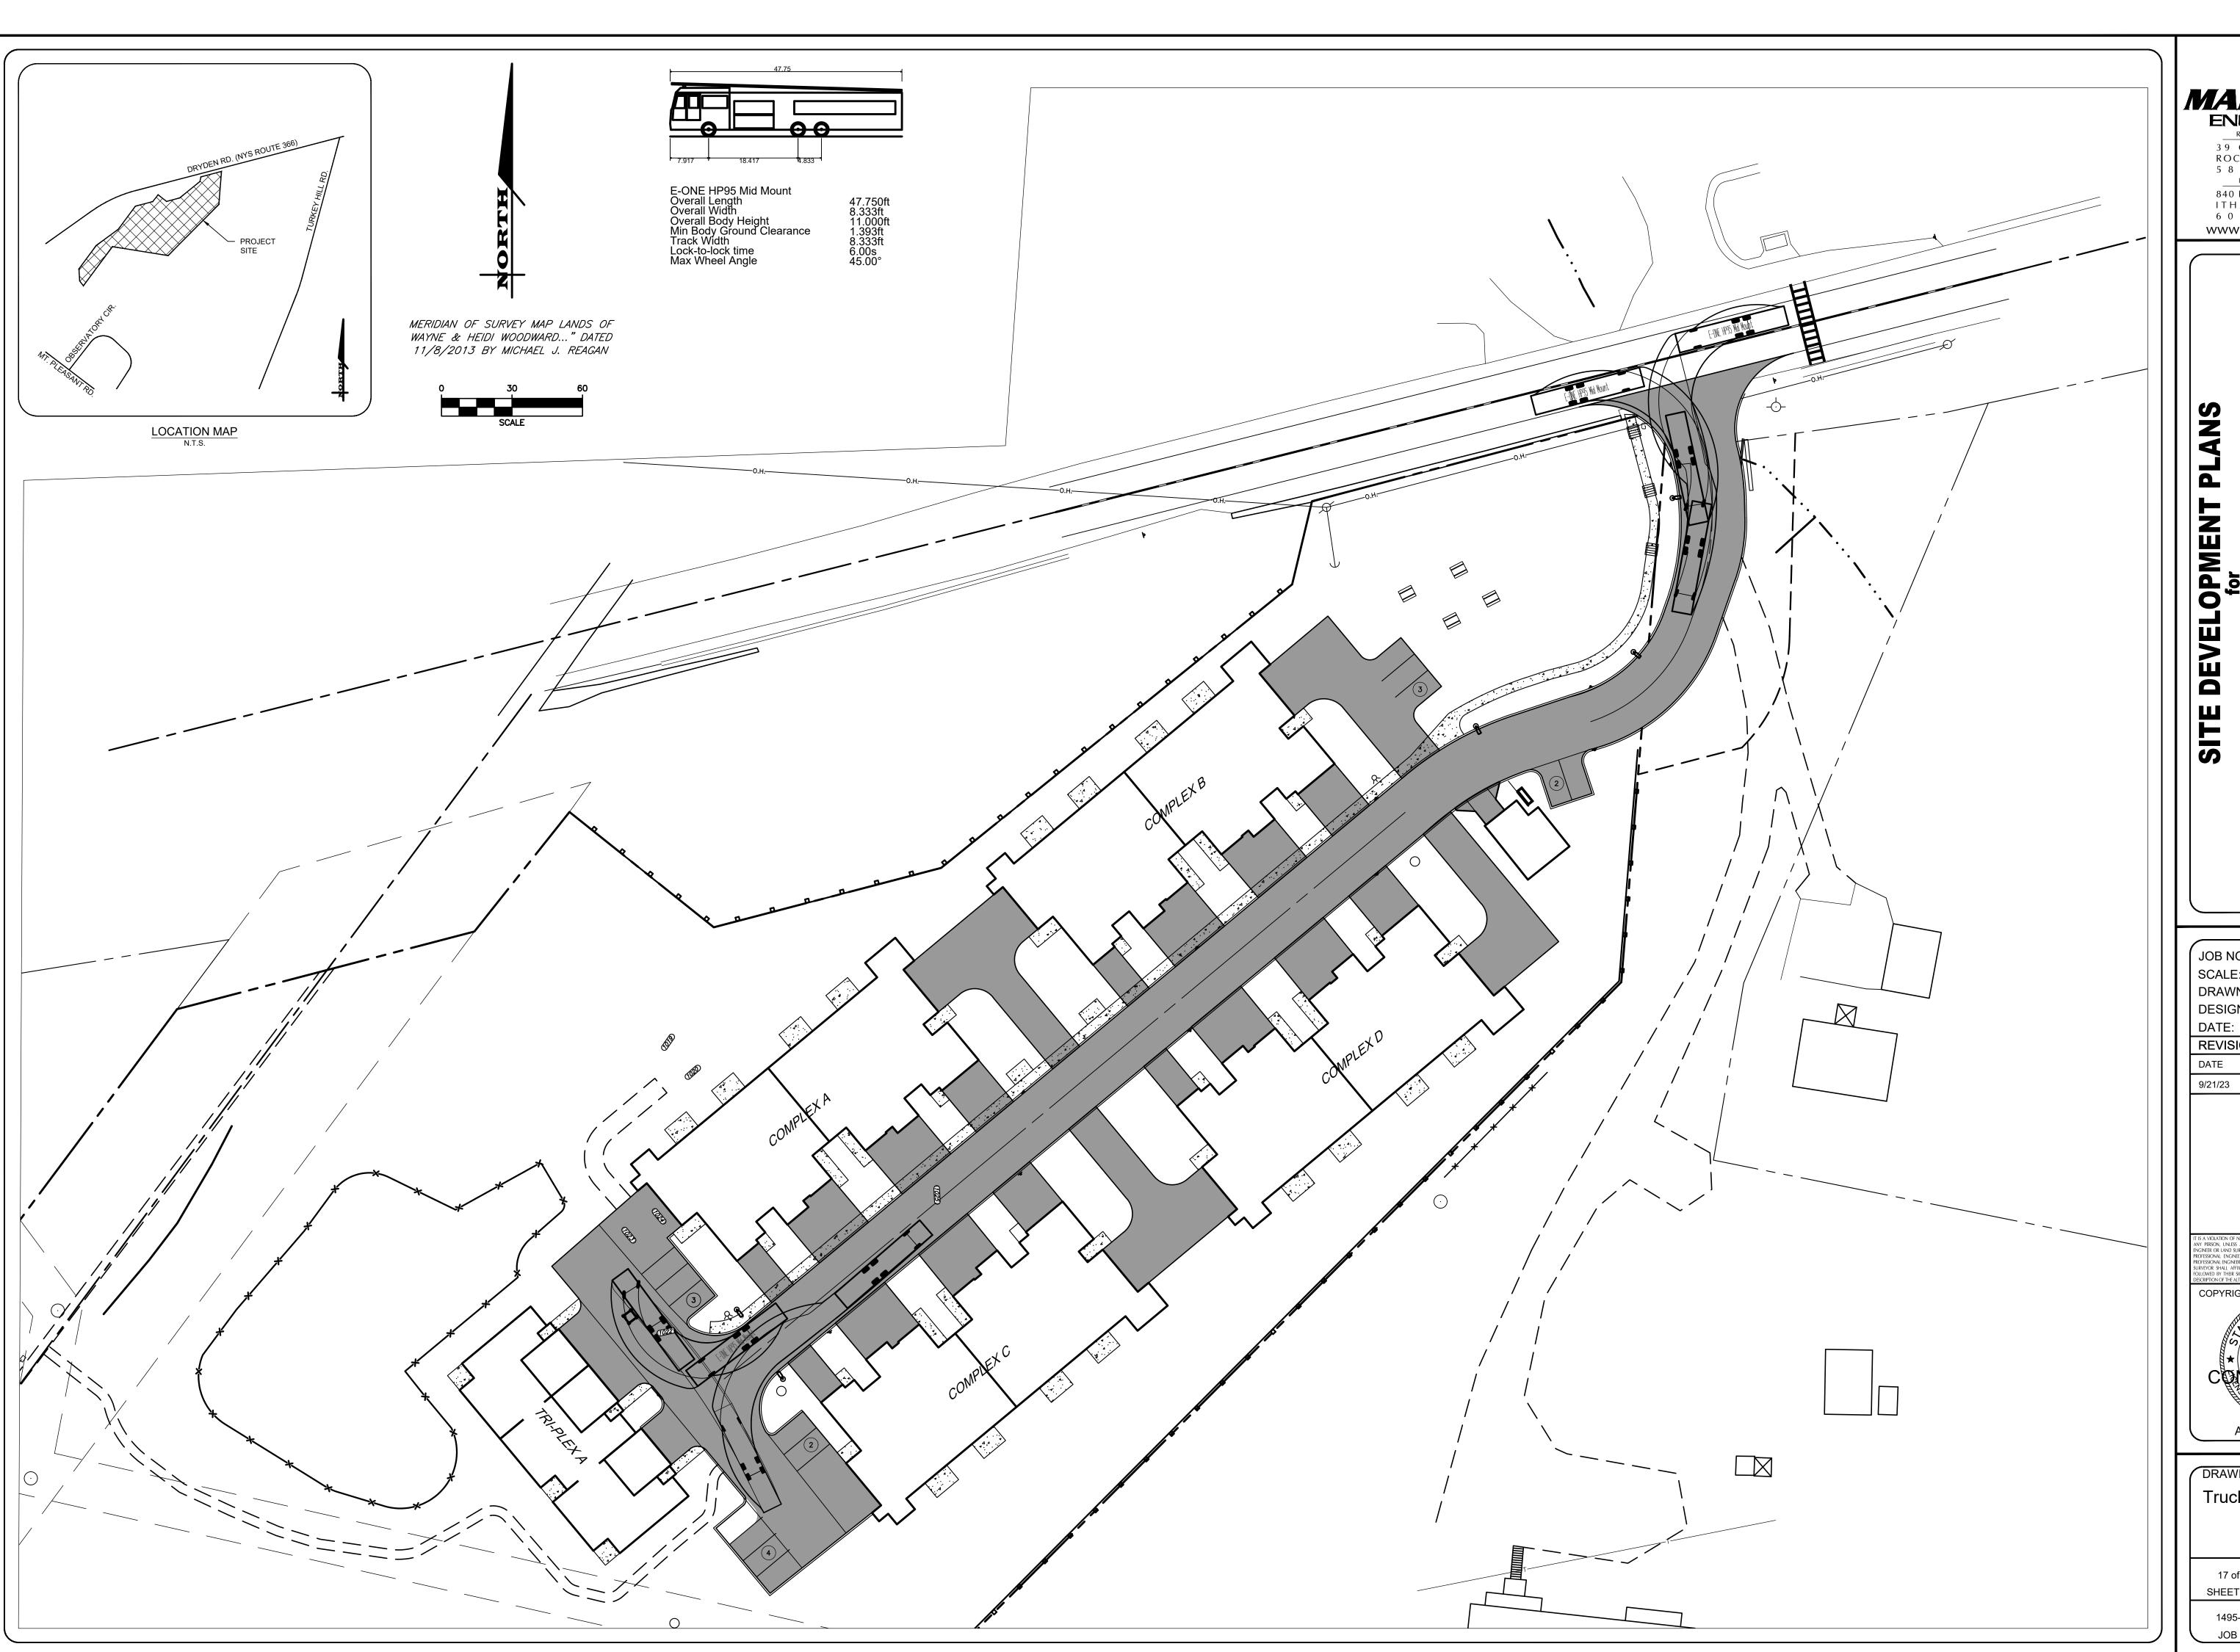

3 9 CASCADE DRIVE ROCHESTER, NY 14614 5 8 5 - 4 5 8 - 7 7 7 0 ITHACA LOCATION

840 HANSHAW RD, STE 6
ITHACA, NY 14850
607-241-2917
www.marathoneng.com

JOB NO: 1495-22 SCALE: 1"=30' DRAWN: DESIGNED: 8/30/23 REVISIONS DATE BY REVISION 9/21/23 AF TOWN SUBMITTAL

COPYRIGHT[©] 2023 MARATHON ENG.

ADAM M. FISHEL

DRAWING TITLE: Truck Turn Plan

17 of 17 C-8.0 SHEET No: 1495-22

JOB No: DRAWING No: